

PROJECT DIRECTORY

PROJECT OWNER REAL QUEST HOLDING, LLC MR. MICHAEL WANG C/O CHIH WANG 3129 S HACIENDA BLVD. #649 HACIENDA HEIGHTS, CA 91745 CONTACT: CHIH WANG (626) 271-5322

ARCHITECT LANEY LA, INC. 13110 HAWTHORNE BLVD. HAWTHORNE, CA 90250 CONTACT: ANTHONY LANEY ANTHONY@LANEY.LA (310) 498-2455

CIVIL ENGINEER APPLE ENGINEERING 9080 TELSTAR AVE. #309 **EL MONTE, CA 91731** CONTACT: LILY XIAO LILY@APPLEENGINEERING.NET (626) 552-9818

STRUCTURAL ENGINEER NOUS ENGINEERING, INC. 527 WEST 7TH ST. SUITE 701 LOS ANGELES, CA 90014 CONTACT: OMAR GARZA OMAR.GARZA@NOUSENGINEERING.COM (213) 627-6687

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ELECTRICAL ENGINEER JOHN R. HANZLIK & ASSOCIATES, INC. 7100 HAVENHURST AVE. SUITE 301 **VAN NUYS, CA 91406** CONTACT: JOHN HANZLIK HANZLIK@PACBELL.NET (818) 901-1778

RAINVILLE DESIGN STUDIO 1632 AVIATION BLVD. REDONDO BEACH, CA 90278 **CONTACT: MIRIAM RAINVILLE** MIRIAM@RAINVILLEDESIGN.COM (310) 378-2650 GEOTECHNICAL ENGINEER

LANDSCAPE ARCHITECT

CAL LAND ENGINEERING, INC. DBA QUARTECH CONSULTANTS 576 E. LAMBERT RD. BREA, CA 92821 CONTACT: JACK LEE LEE@CALLANDENG.COM (714) 671-1050

VICINITY MAP

LANEY LA LIFESTYLE + ARCHITECTURE

PROJECT NAME BIRCH

(626) 271-5322

PROJECT NUMBER

CLIENT REAL QUEST HOLDING, LLC MR. MICHAEL WANG C/O CHIH WANG 3129 S HACIENDA BLVD. #649 HACIENDA HEIGHTS, CA 91745

PROJECT ADDRESS 21809-21811 FIGUEROA STREET CARSON, CA 90745

ARCHITECT ANTHONY LANEY AIA LANEY LA, INC. 13110 HAWTHORNE BLVD. UNIT A **HAWTHORNE CA 90250** (310) 498-2455 ANTHONY@LANEY.LA

NOT FOR CONSTRUCTION

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2	08/16/17	1ST REVIEW RE-SUBMITTAL
3	11/30/17	100% DESIGN DEVELOPMENT
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PROJECT NO: 17065 **MODEL FILE:** DRAWN BY: DD CHK'D BY: COPYRIGHT

SHEET TITLE

Harbor Employees Federal Credit

W 218th Pl

SITE

COVER SHEET

G-000.0

ABBREVIATIONS

INSULATION

INTERIOR

ΑT LAMINATE LAM ABOVE FINISH FLOOR LAV LAVATORY A.F.F. AFG **ABOVE FINISH GRADE** LT FXT LIGHT FIXTURE ACOUS ACOUSTICAL MAX MAXIMUM ADJ **ADJUSTABLE** MECH **MECHANICAL** ALUM ALUMINUM METAL ANCH ANCHOR MINIMUM APPROX **APPROXIMATELY** NEW **NOT IN CONTRACT ATTEN ATTENUATION** ON CENTER BLDG BUILDING OD **OUTSIDE DIAMETER** BLK BLOCK PROPERTY CORNER BEAM PROPERTY LINE **BOTTOM OF** PLATE COMPACT PARKING STALL PLAS PLASTER CLEAR ANODIZED PLYWOOD CABINET RISERS CERAMIC **ROOF DRAIN** ROUGH OPENING CONTROL JOINT CLOSET RADIUS **CENTER LINE** RDL **ROOF DRAIN LEADER** RECESSED CEILING CLEAR REINFORCED **CONCRETE MASONRY UNIT** CMU REQUIRED COL COLUMN RESISTANT CONC RESIL CONCRETE RESILIENT CONST CONSTRUCTION RETAINING CONT CONTINUOUS REVERSE RM DOUBLE ROOM S.S. STAINLESS STEEL DETAIL SHEET VINYL DIAMETER DIAGONAL SCHED SCHEDULE SECT SECTION DIMENSION SAU SELF ADHERING UNDERLAYMENT DOWN SFR SINGLE FAMILY RESIDENCE DOWNSPOUT SHT DRAWING SHEET SIM EACH SIMILAR SPEC **ELEVATION SPECIFICATION** ELECTRICAL SQUARE STD STANDARD **EQUIPMENT** STEEL **EXISTING** STRUCT STRUCTURAL **EXTERIOR** SUSPENDED FLOOR DRAIN **TREADS FINISH** TOP AND BOTTOM T&B FIN. FINISH FLOOR ELEVATION TONGUE AND GROOVE F.F.E. T&G FLR FLOOR T.O. TOP OF T.O.C. TOP OF CONCRETE **FLUOR FLUORESCENT** FACE OF TOP TOPPING TELE TELEPHONE FOOT FOOTING **TEMP TEMPERED** FIELD VERIFY T.S. **TUBE STEEL** TYP TYPICAL GAUGE **GALVANIZED IRON** UNO **UNLESS NOTED OTHERWISE GALVANIZED UNREINFORCED MASONRY** GALV VINYL COMPOSITION TILE GLASS GYP BD **GYPSUM BOARD** WATER CLOSET HEAD HDWD HARDWOOD WIDE FLANGE HORIZ HORIZONTAL WATERPROOF HEIGHT WOOD WEATHER RESISTANT BARRIER INSIDE DIAMETER

PLUS OR MINUS

NUMBER


SYMBOLS

ENTRY

100

(100 A

101

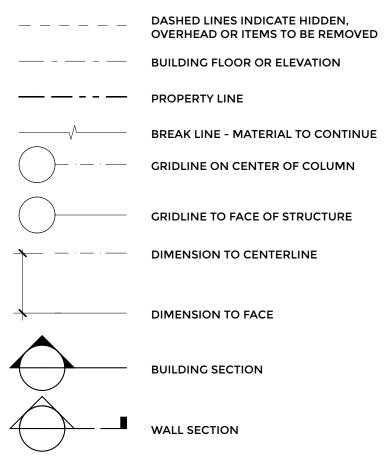

INTERIOR ELEVATION - MULTIPLE WALLS

INTERIOR ELEVATION - 1 WALL


ROOM NAME

WALL TYPE

DOOR MARK


WINDOW MARK


ROOM NUMBER

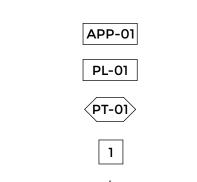







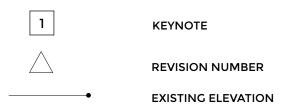

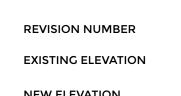

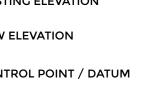

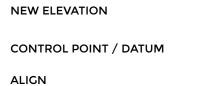














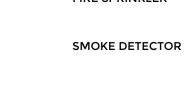


NEW WALL










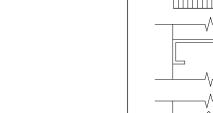

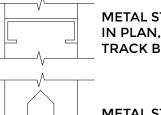

METAL STUD



MATERIALS

ALUMINUM WOOD, FINISH

CONCRETE

GRAVEL

GYPSUM BOARD PLASTER IN SECTION & ELEVATION

CONCRETE IN PLAN & ELEVATION

CEMENT PLASTER

BATT INSULATION

PLYWOOD GLASS

CERAMIC TILE **METAL STUD**

IN PLAN, METAL TRACK BELOW

IN ELEVATION

IN ELEVATION

CONCRETE

MASONRY UNIT

RIGID INSULATION

////// STEEL

ALLOWABLE AREA

GARAGE: TYPE I-A	UNLIMITED
CONDOMINIUM: TYPE V-A	36,000 SQ FT

FRONTAGE INCREASE

 $I_f = [F/P-0.25]W/30$ $I_f = [396/680 - 0.25]20/30$ $I_f = 0.22$

OCCUPANT LOAD ANALYSIS & EXITING DIAGRAMS

EVEL	USE	TOTAL AREA	OCCUPANT LOAD FACTOR	OCCUPANT LOAD
ROUND	PARKING	26,520 SF	200	133
	LOBBY	472 SF	15	32
	MAIL ROOM	269 SF	300	1
			TOTAL GROUND LEVE	L: 166
EVEL 2	RESIDENTIAL	14,799 SF	200	79
EVEL 3	RESIDENTIAL	14,799 SF	200	80
EVEL 4	RESIDENTIAL	15,166 SF	200	80
EVEL 5	ROOF DECK	3,496 SF	200	18

EXIT COMPONENT WIDTH/CAPACITY CALCS

CALCULATION OF CAPACITY OF MINIMUM WIDTH CODE PRESCRIBED EXIT COMPONENTS. SEE LOAD TABLE ABOVE AND DIAGRAMS BELOW. SEE EGRESS JUSTIFICATION CALCULATION BELOW.

STAIRWAYS

MINIMUM WIDTH OF STAIR SERVING OCCUPANT LOAD >49 = 44" (CBC 1005.1) CAPACITY OF 48" STAIR (CBC 1004.1.1) 0.3"/PERSON = 48"/0.3" = 160 OCCUPANTS STAIR #1 LOAD = 82 OCCUPANTS STAIR #2 LOAD = 78 OCCUPANTS 48" STAIR IS OK

PARKING

NUMBER OF UNITS WITH 2 BEDROOMS: NUMBER OF UNITS WITH 3 BEDROOMS: TOTAL UNITS:	21 11 32
PARKING REQUIREMENT NUMBER OF SPACES PER UNIT: NUMBER OF GUEST SPACES (1/EVERY 4 UNITS):	2 PER UN 8
RESIDENCE PARKING: NUMBER OF UNITS: PARKING REQUIRED	32 64
GUEST PARKING: NUMBER OF GUEST SPACES (1/EVERY 4 UNITS): PARKING REQUIRED:	8 8
TOTAL PARKING REQUIRED: TOTAL PARKING PROVIDED:	72 73
BICYCLE RACKS	

TOTAL BIKE RACKS REQUIRED (5% OF REQUIRED PARKING):

TOTAL BIKE RACKS PROVIDED

FAIR HOUSING ACT (FHA) AMERICAN DISABILITIES ACT (ADA)

CONDOMINIUM CALCULATIONS

UNIT#	PLAN TYPE	# OF BEDROOMS	AREA (SF)	OPEN SPACE
1	Α	2	924	150
2	K	2	1,108	157
3	K	2	1,104	158
4	Н	2	1,427	154
5 6	С	3	1,705	N/A
6	E	3	1,774	N/A
7	G	3	1,978	N/A
8	1	2	1,326	151
9	В	2	1,100	158
10	В	2	1,103	165
11	J	2	1,135	175
12	Α	2	920	150
13	K	2	1,108	157
14	K	2	1,104	158
15	Н	2	1,427	154
16	С	3	1,701	N/A
17	E	3	1,774	N/A
18	G	3	1,978	N/A
19	1	2	1,326	151
20	В	2	1,100	158
21	В	2	1,103	165
22	J	2	1,135	175
23	F	3	1,381	150
24	1	3	1,918	157
25	Н	2	1,427	154
26	С	3	1,705	N/A
27	E	3	1,774	N/A
28	D	3	1,979	N/A
29	1	2	1,326	151
30	В	2	1,100	158
31	В	2	1,103	165
32	J	2	1,135	175
TOTAL AR	EA:		44,208 SF	3,646 SF

AREA BREAKDOWNS

NET SIZE OF LOT:	33,703 SF
GROSS FLOOR AREA:	52,616 SF
NET FLOOR AREA:	44,208 SF
PROPOSED DENSITY:	32 UNITS PER ACRE
LOT COVERAGE RATIO:	64.05%
FLOOR AREA RATIO:	156.12%

GOVERNING ACCESSIBILITY STANDARDS

2016 CALIFORNIA BUILDING CODE

PROJECT INFORMATION

PROJECT ADDRESS 21809-21811 FIGUEROA STREET

CARSON, CA 90745 LEGAL DESCRIPTION A PORTION OF LOT 41 OF TRACT NO. 3612, IN THE CITY OF CARSON, COUNTY OF

LOS ANGELES, STATE OF CALIFORNIA, AS PER MAP RECORDED IN BOOK 40 PAGES 5 AND 6 OF MAPS, IN THE OFFICE OF THE COUNTY RECORDER OF SAID

7343-020-009 7343-020-010

ZONING: BIRCH SPECIFIC PLAN LOT AREA (NET): 33,703 SF

> **BUILDING FOOTPRINT:** 18,990 SF

GOVERNING CODES: 2016 CALIFORNIA BUILDING CODE 2016 CALFORNIA FIRE CODE 2016 CALIFORNIA MECHANICAL CODE 2016 CALIFORNIA PLUMBING CODE 2016 ELECTRICAL CODE 2016 CALIFORNIA GREEN CODE AND ALL APPLICABLE CODES, L CAL, ENENT OSHA LAWS, T-24 ENERGY CONSERVATION, LIST OF STANDARDS, DISABLED ACCESS REGULATIONS AND LA COUNTY AMENDMENTS

OCCUPANCY GROUP: RESIDENTIAL: PARKING LEVEL:

CONSTRUCTION TYPE: TYPE V-A - FULLY SPRINKLERED **RESIDENTIAL (3 STORIES):**

TYPE I-A - FULLY SPRINKLERED

R-2

S-2

FIRE SPRINKLERS: **FULL NFPA 13 AUTOMATIC SPRINKLER SYSTEM**

PARKING LEVEL (GROUND LEVEL):

NEW 4-STORY CONDOMINIUM WITH 32 UNITS + ROOF GARDEN

GENERAL BUILDING INFORMATION

LOT AREA CALCULATIONS	
LOT AREA:	33,703 SF
SETBACKS:	
REQUIRED FRONT: REQUIRED SIDE: REQUIRED REAR:	20' 10' 15'
HEIGHT LIMIT (PER BIRCH SPECIFIC PLAN):	55'



LANEY LA LIFESTYLE + ARCHITECTURE

PROJECT NAME BIRCH

PROJECT NUMBER

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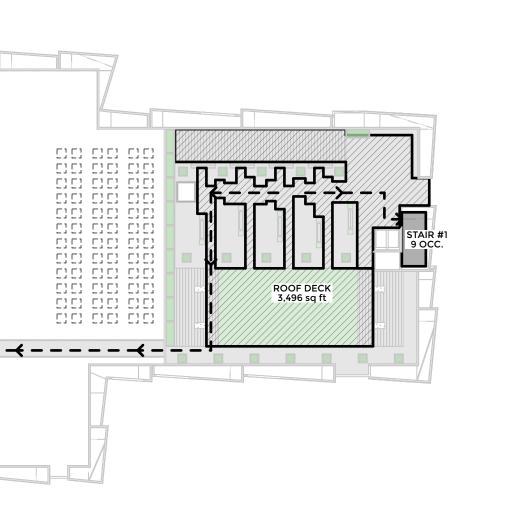
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SHEET TITLE

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PROJECT INFORMATION



ROOF LEVEL - EGRESS DIAGRAM


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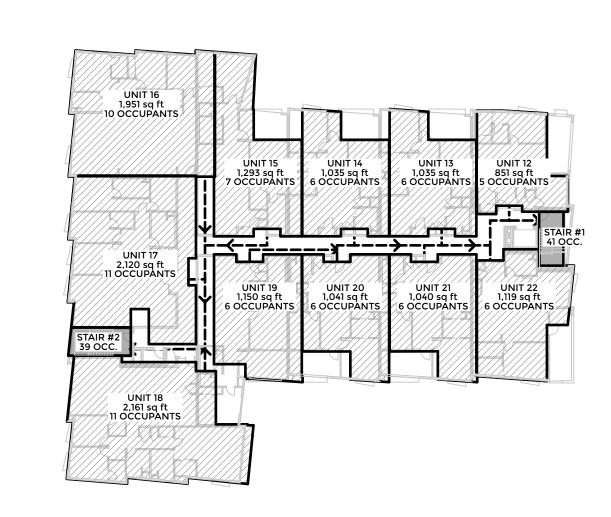
STAIR #2 9 OCC.




FRONTAGE DIAGRAM

SCALE: 1/32" = 1'-0"



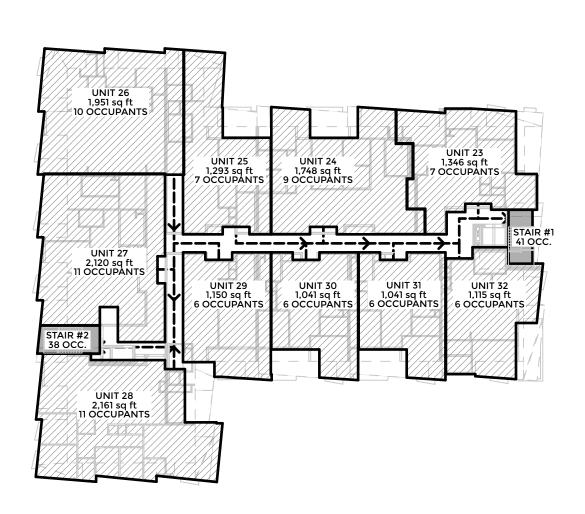

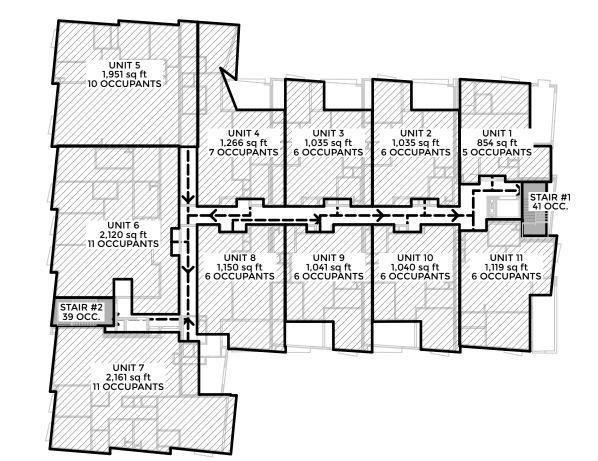

2ND FLOOR - EGRESS DIAGRAM

SCALE: 1/32" = 1'-0"

2

3RD FLOOR - EGRESS DIAGRAM
SCALE: 1/32" = 1'-0"

GROUND FLOOR - EGRESS DIAGRAM

SCALE: 1/32" = 1'-0"


4TH FLOOR - EGRESS DIAGRAM

SCALE: 1/32" = 1'-0"

4

G-101.0



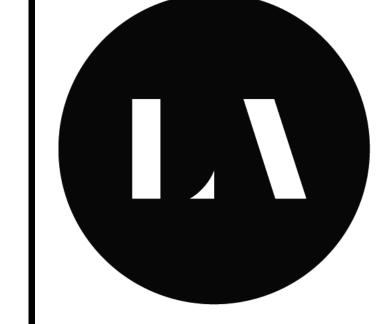

LANEY LA

LIFESTYLE + ARCHITECTURE

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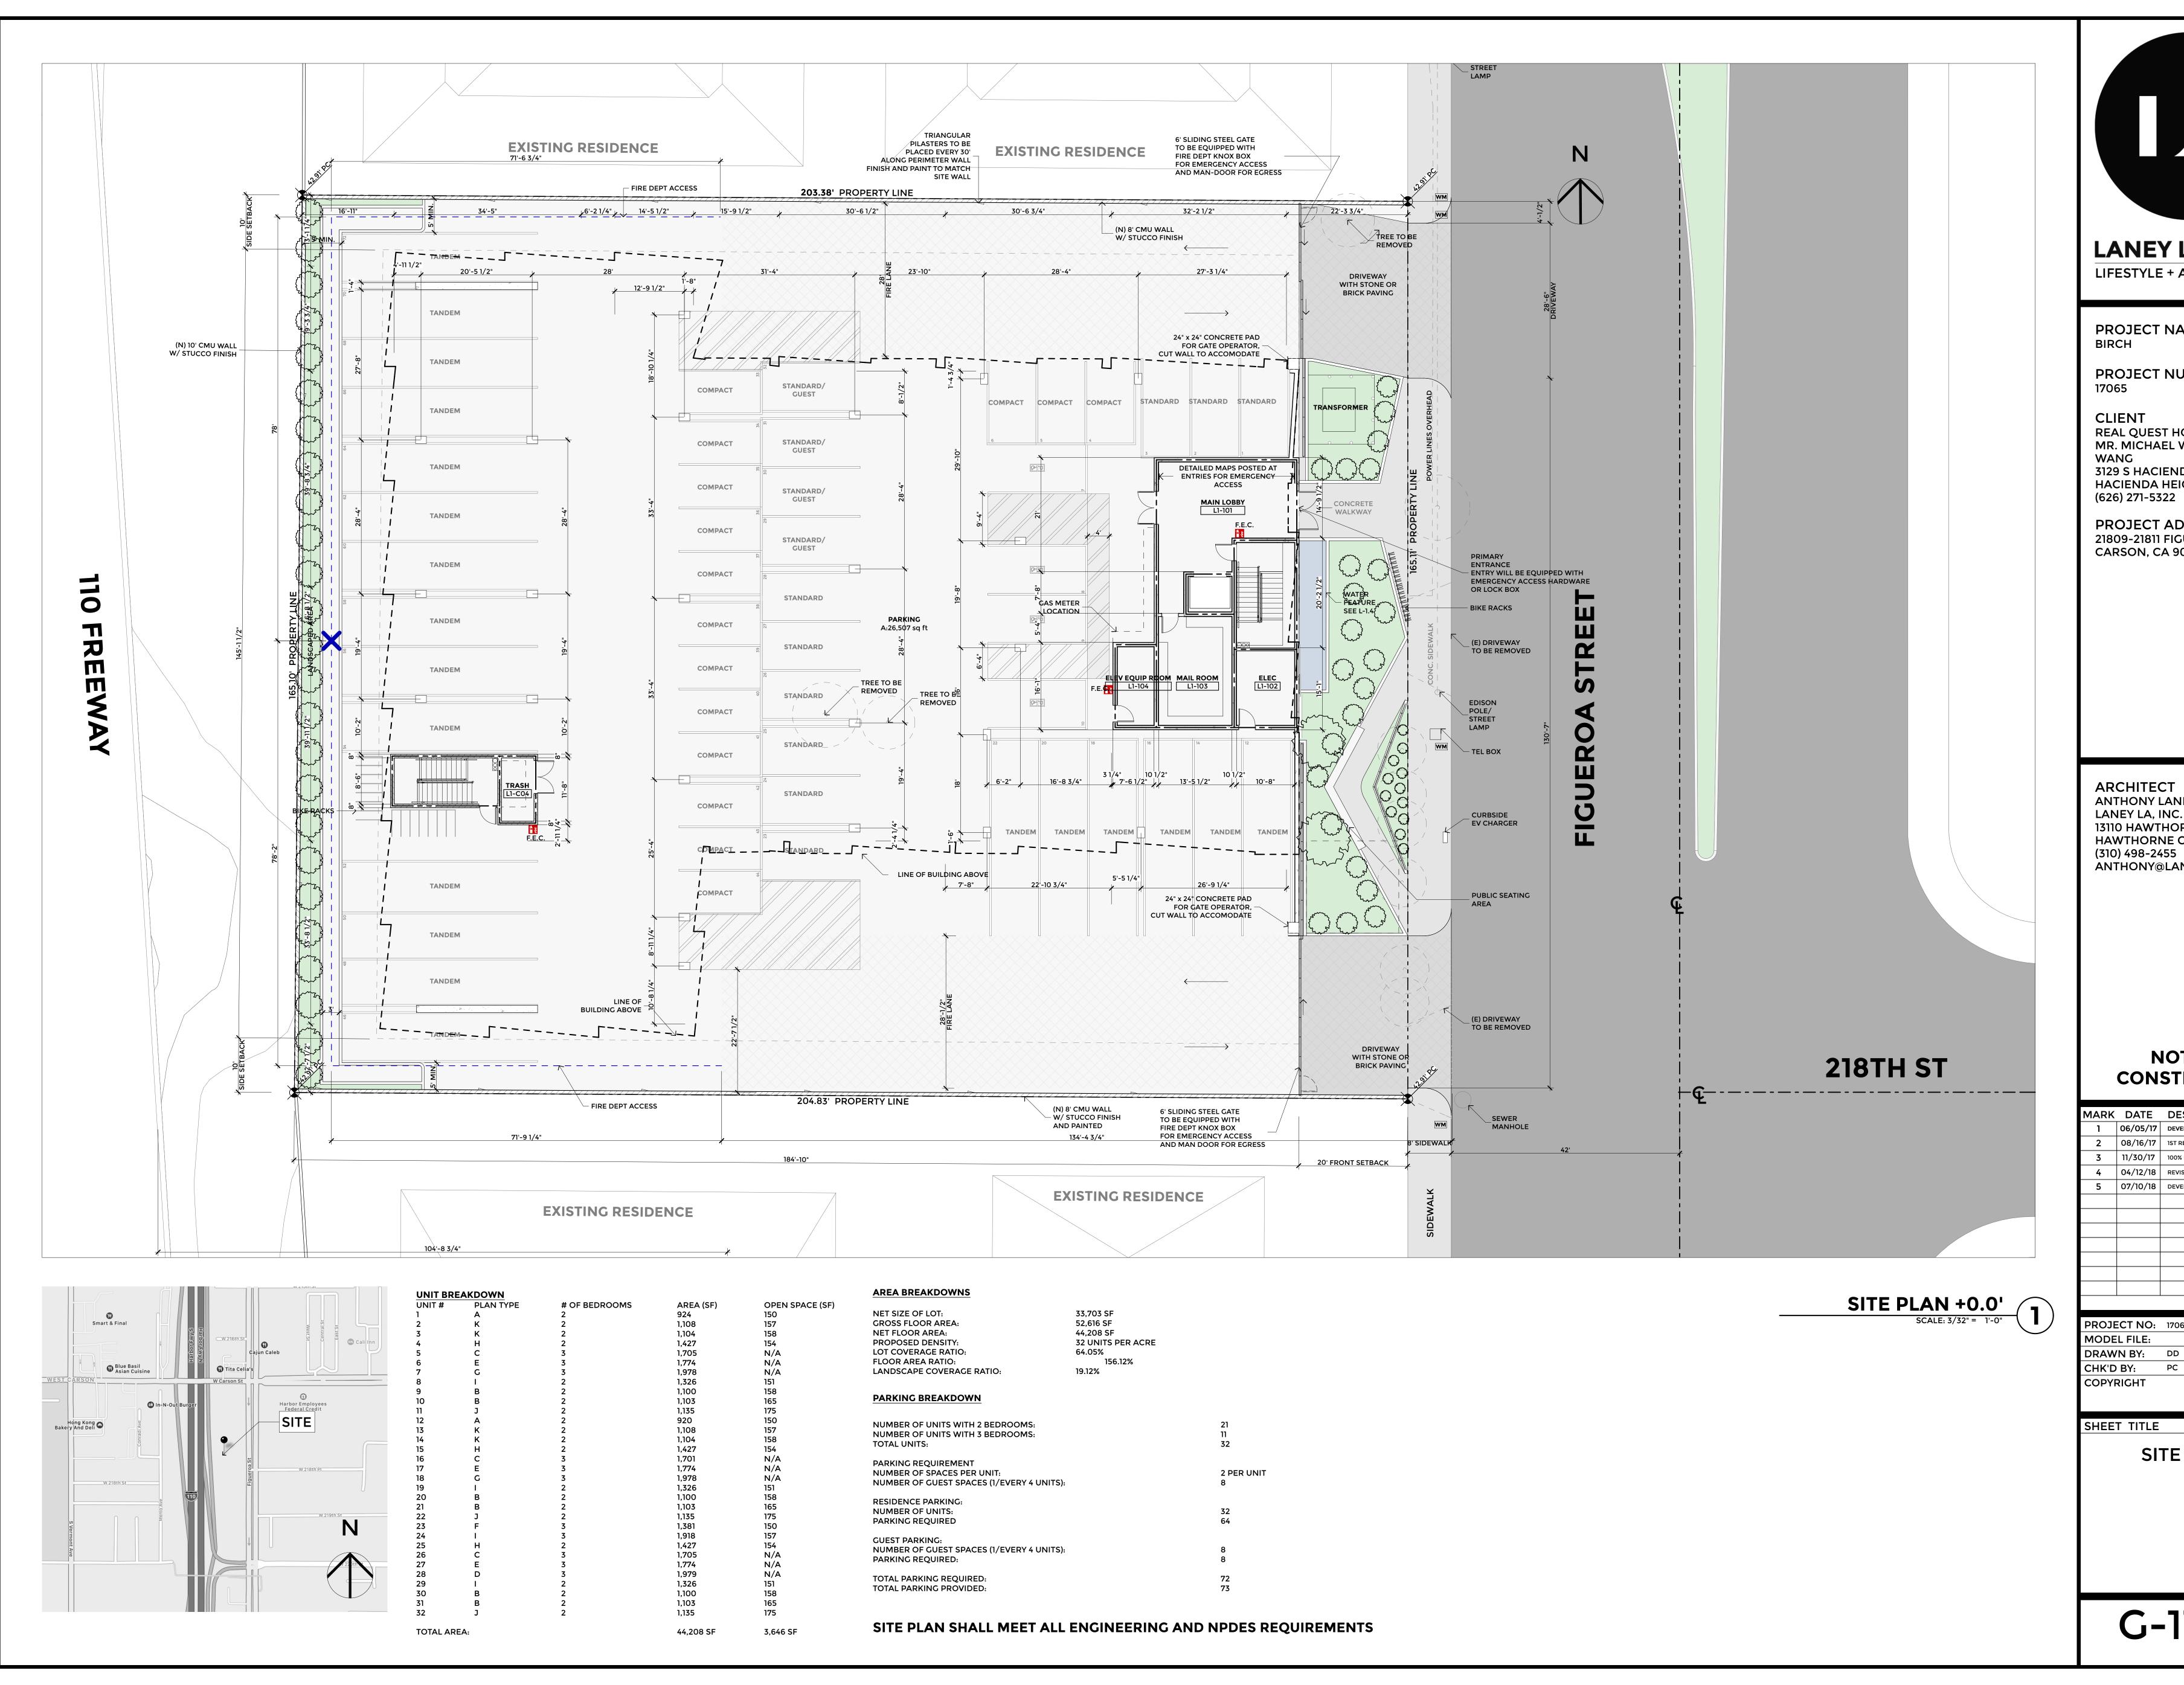
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SHEET TITLE

SITE UTILIZATION
MAP

A-1.0



LANEY LA LIFESTYLE + ARCHITECTURE

PROJECT NAME BIRCH

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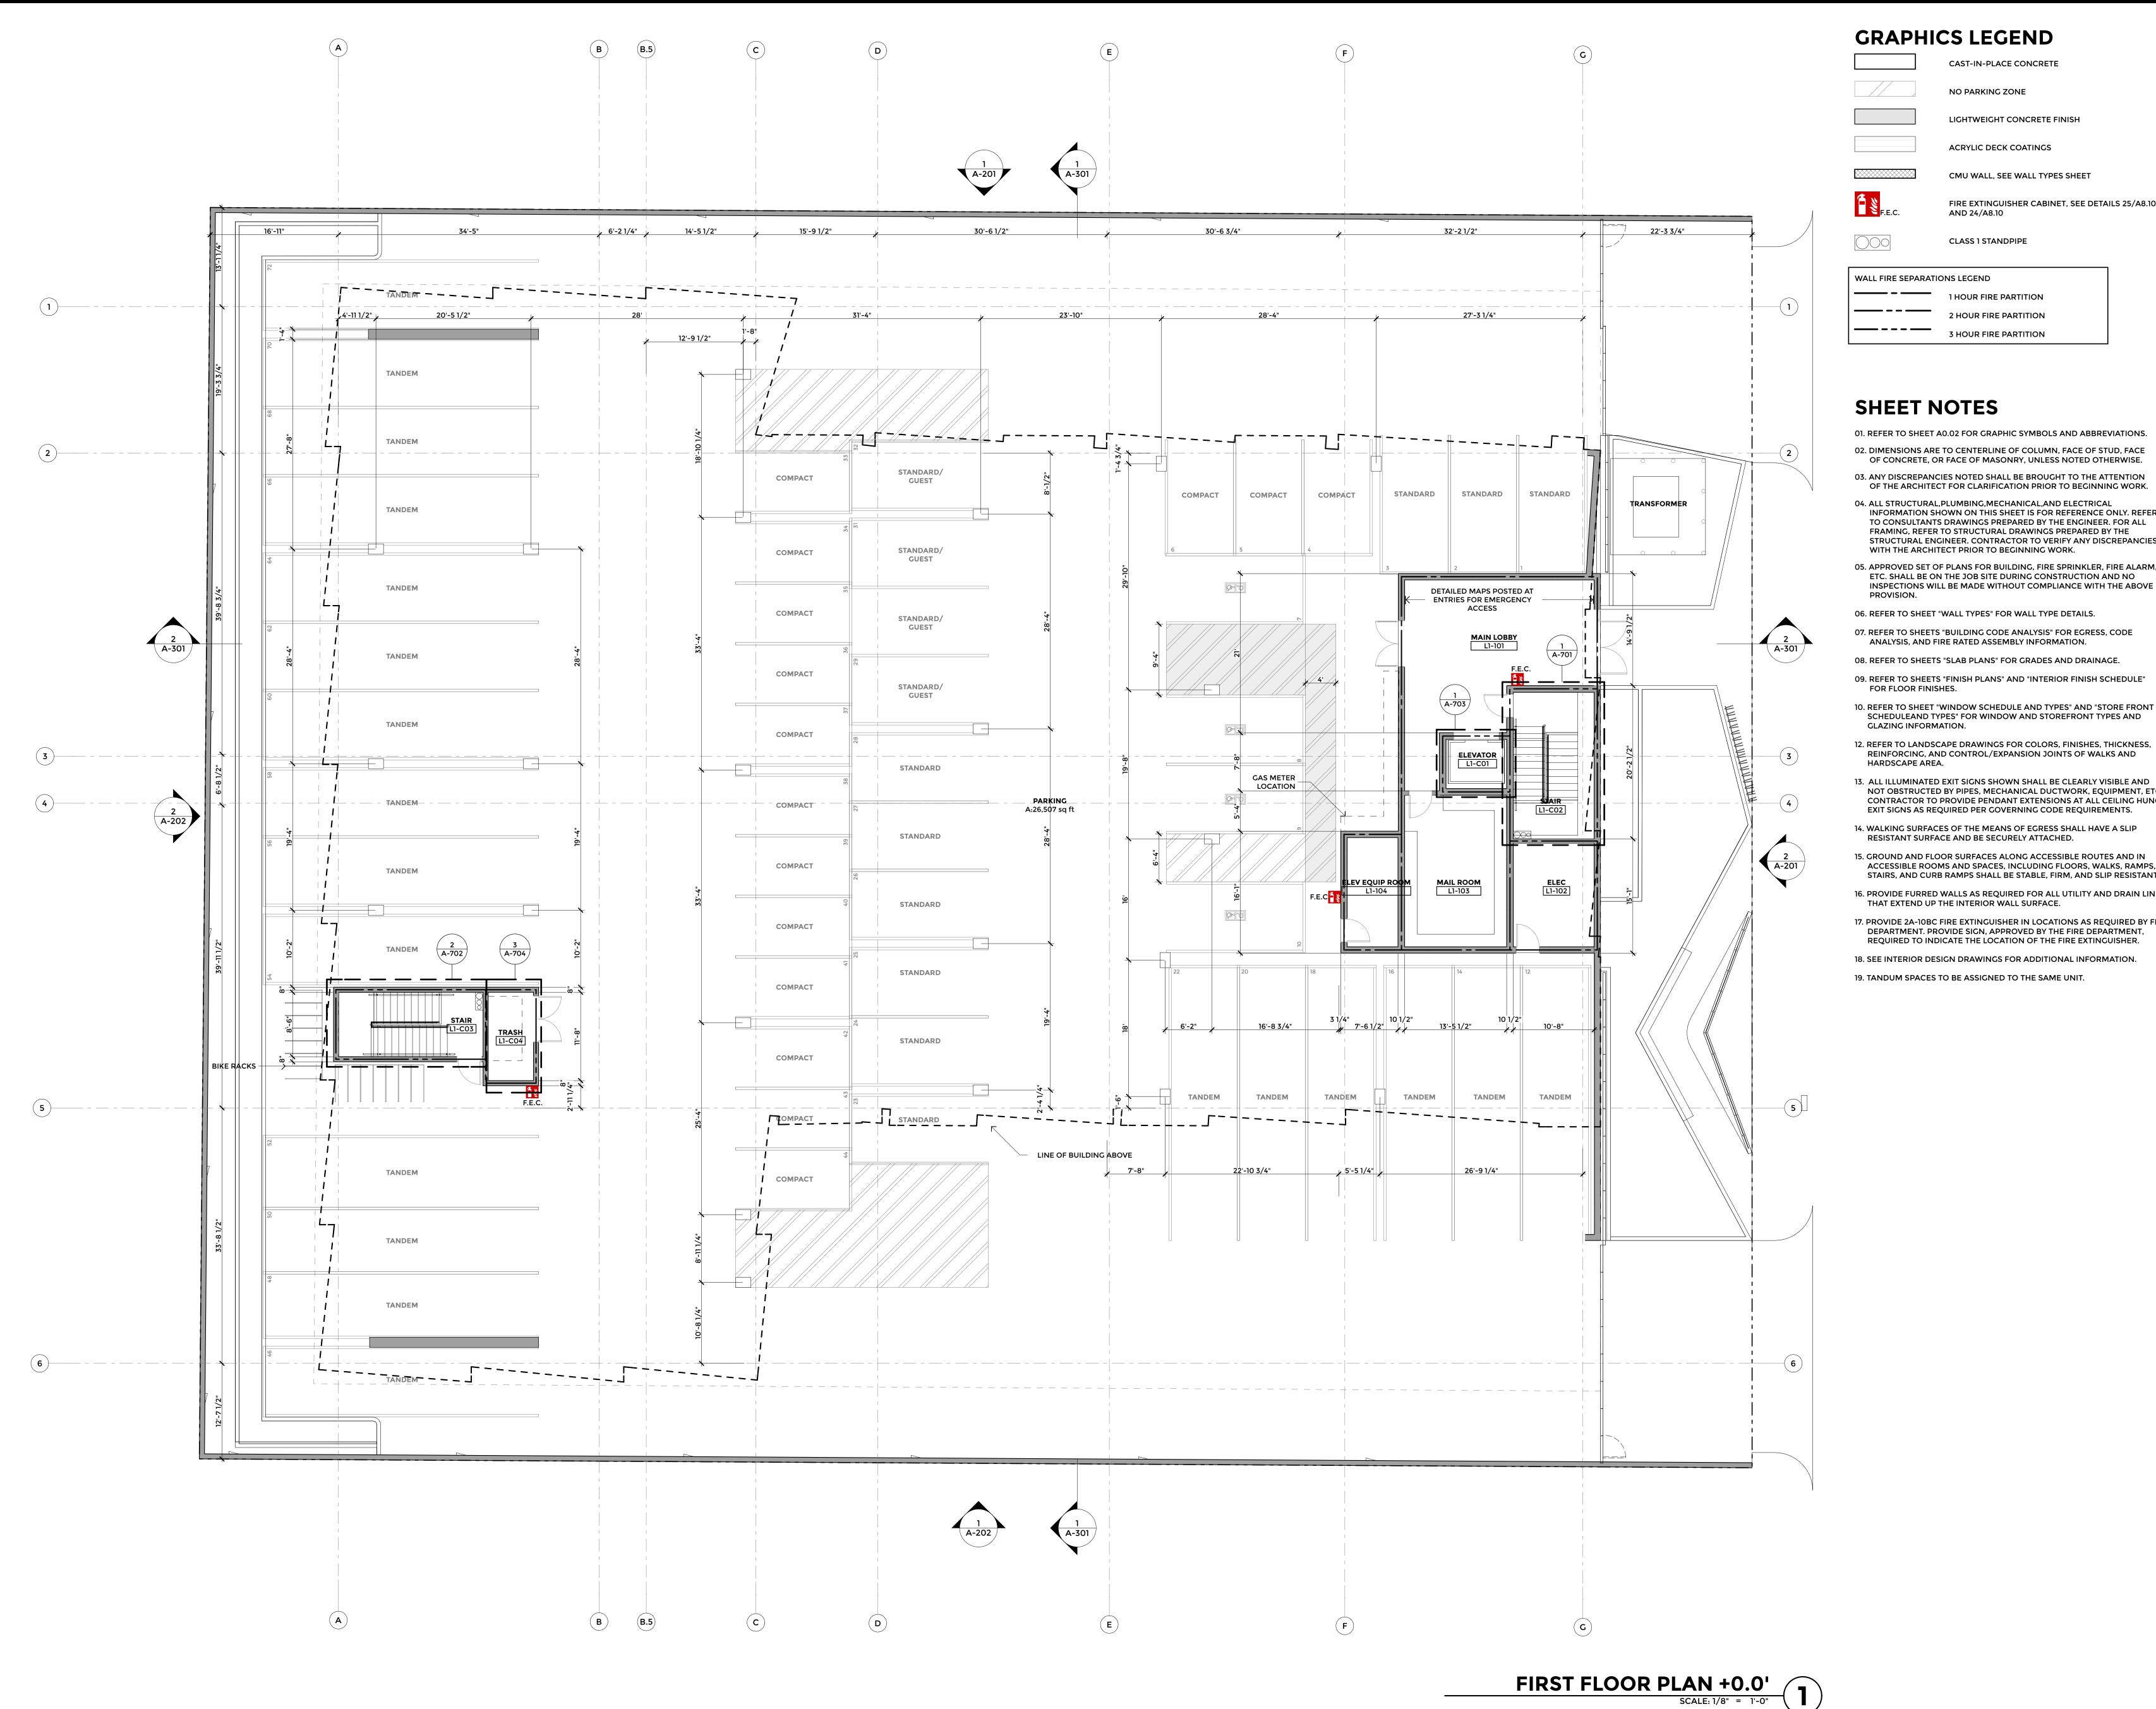
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	06/05/17 08/16/17 11/30/17 04/12/18

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SHEET TITLE

SITE PLAN

G-115.0




NO PARKING ZONE



LIGHTWEIGHT CONCRETE FINISH

ACRYLIC DECK COATINGS

CAST-IN-PLACE CONCRETE

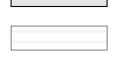

CMU WALL, SEE WALL TYPES SHEET



FIRE EXTINGUISHER CABINET, SEE DETAILS 25/A8.10 AND 24/A8.10

CLASS 1 STANDPIPE

WALL FIRE SEPARATIONS LEGEND

_____ 1 HOUR FIRE PARTITION ____ 2 HOUR FIRE PARTITION **3 HOUR FIRE PARTITION**

SHEET NOTES

01. REFER TO SHEET A0.02 FOR GRAPHIC SYMBOLS AND ABBREVIATIONS. 02. DIMENSIONS ARE TO CENTERLINE OF COLUMN, FACE OF STUD, FACE OF CONCRETE, OR FACE OF MASONRY, UNLESS NOTED OTHERWISE.

OF THE ARCHITECT FOR CLARIFICATION PRIOR TO BEGINNING WORK. 04. ALL STRUCTURAL, PLUMBING, MECHANICAL, AND ELECTRICAL INFORMATION SHOWN ON THIS SHEET IS FOR REFERENCE ONLY. REFER TO CONSULTANTS DRAWINGS PREPARED BY THE ENGINEER. FOR ALL FRAMING, REFER TO STRUCTURAL DRAWINGS PREPARED BY THE

WITH THE ARCHITECT PRIOR TO BEGINNING WORK. 05. APPROVED SET OF PLANS FOR BUILDING, FIRE SPRINKLER, FIRE ALARM, ETC. SHALL BE ON THE JOB SITE DURING CONSTRUCTION AND NO INSPECTIONS WILL BE MADE WITHOUT COMPLIANCE WITH THE ABOVE

06. REFER TO SHEET "WALL TYPES" FOR WALL TYPE DETAILS.

07. REFER TO SHEETS "BUILDING CODE ANALYSIS" FOR EGRESS, CODE ANALYSIS, AND FIRE RATED ASSEMBLY INFORMATION.

08. REFER TO SHEETS "SLAB PLANS" FOR GRADES AND DRAINAGE.

09. REFER TO SHEETS "FINISH PLANS" AND "INTERIOR FINISH SCHEDULE" FOR FLOOR FINISHES.

12. REFER TO LANDSCAPE DRAWINGS FOR COLORS, FINISHES, THICKNESS, REINFORCING, AND CONTROL/EXPANSION JOINTS OF WALKS AND

HARDSCAPE AREA. 13. ALL ILLUMINATED EXIT SIGNS SHOWN SHALL BE CLEARLY VISIBLE AND NOT OBSTRUCTED BY PIPES, MECHANICAL DUCTWORK, EQUIPMENT, ETC. CONTRACTOR TO PROVIDE PENDANT EXTENSIONS AT ALL CEILING HUNG


14. WALKING SURFACES OF THE MEANS OF EGRESS SHALL HAVE A SLIP RESISTANT SURFACE AND BE SECURELY ATTACHED.

15. GROUND AND FLOOR SURFACES ALONG ACCESSIBLE ROUTES AND IN ACCESSIBLE ROOMS AND SPACES, INCLUDING FLOORS, WALKS, RAMPS, STAIRS, AND CURB RAMPS SHALL BE STABLE, FIRM, AND SLIP RESISTANT.

16. PROVIDE FURRED WALLS AS REQUIRED FOR ALL UTILITY AND DRAIN LINE

THAT EXTEND UP THE INTERIOR WALL SURFACE. 17. PROVIDE 2A-10BC FIRE EXTINGUISHER IN LOCATIONS AS REQUIRED BY FIR DEPARTMENT. PROVIDE SIGN, APPROVED BY THE FIRE DEPARTMENT,

REQUIRED TO INDICATE THE LOCATION OF THE FIRE EXTINGUISHER. 18. SEE INTERIOR DESIGN DRAWINGS FOR ADDITIONAL INFORMATION.

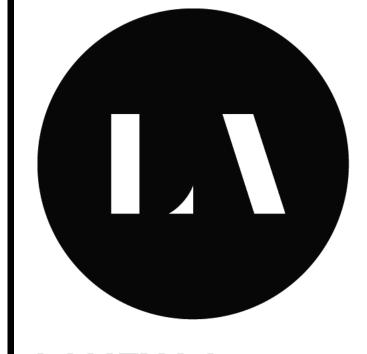

LANEY LA LIFESTYLE + ARCHITECTURE

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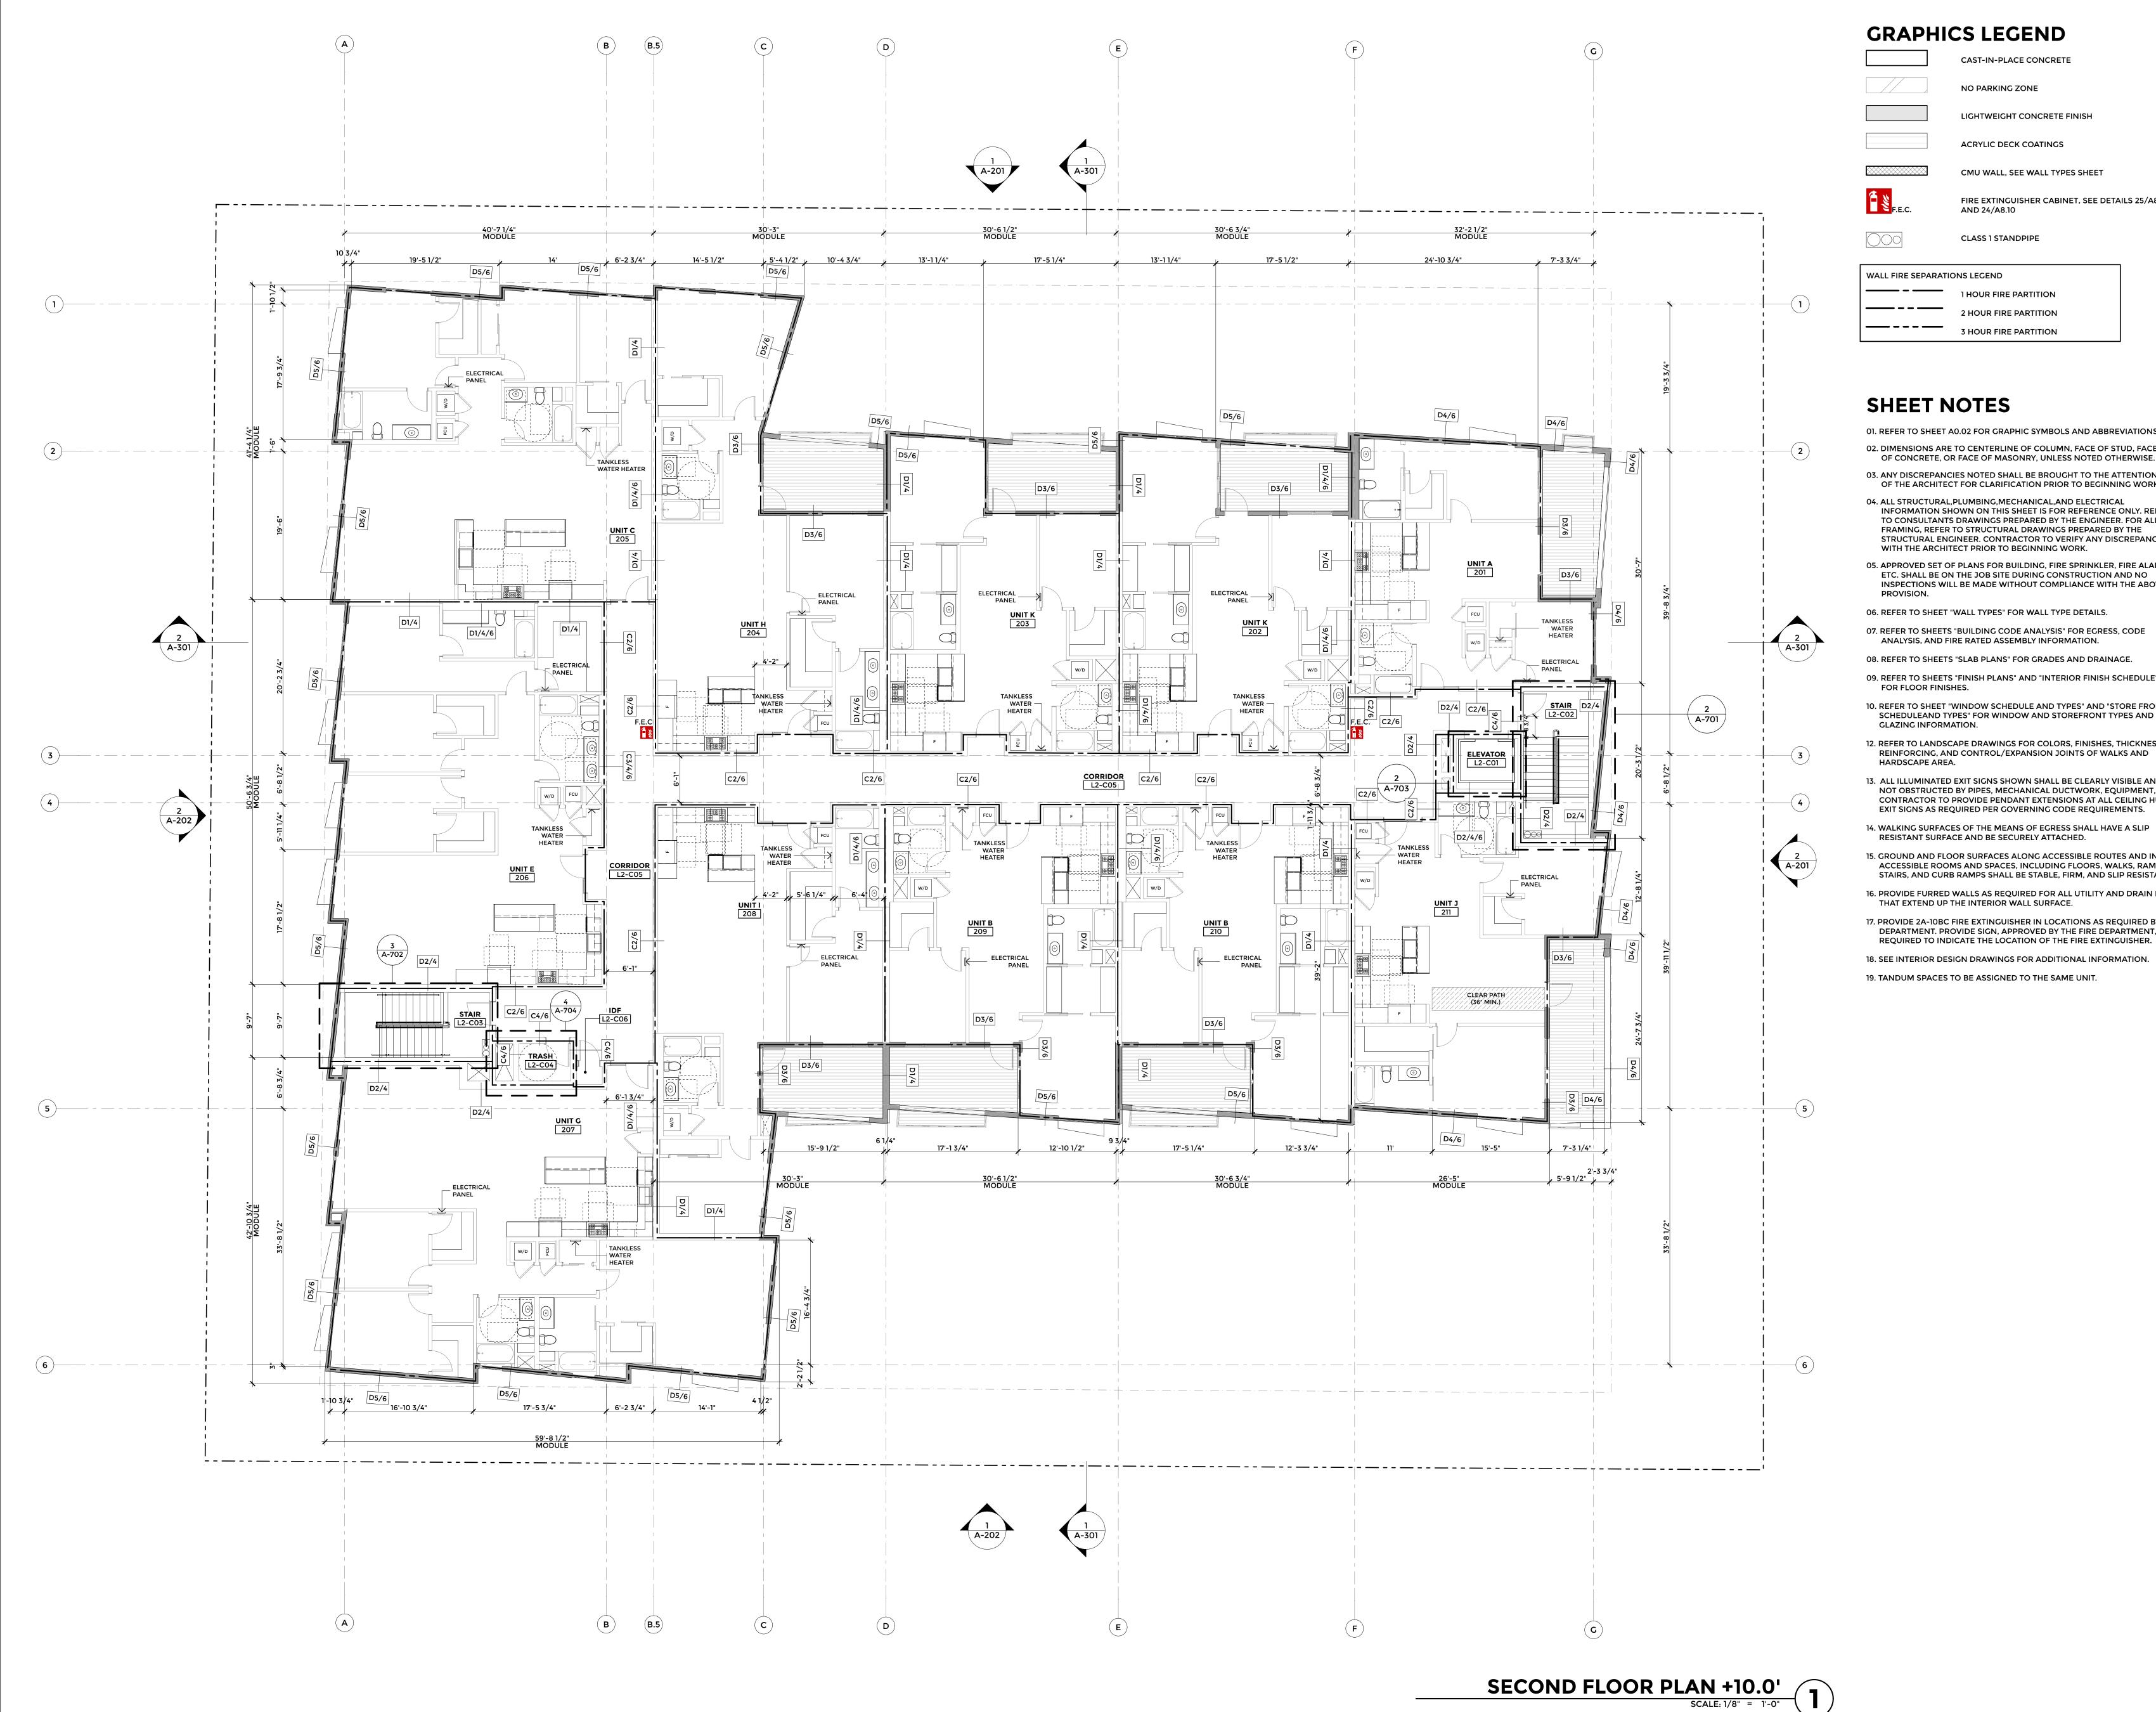
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SHEET TITLE

FLOOR PLAN - FIRST **FLOOR**




CAST-IN-PLACE CONCRETE

NO PARKING ZONE



LIGHTWEIGHT CONCRETE FINISH

ACRYLIC DECK COATINGS

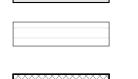

CMU WALL, SEE WALL TYPES SHEET



FIRE EXTINGUISHER CABINET, SEE DETAILS 25/A8.10 AND 24/A8.10



CLASS 1 STANDPIPE

WALL FIRE SEPARATIONS LEGEND

1 HOUR FIRE PARTITION . — - - — 2 HOUR FIRE PARTITION **3 HOUR FIRE PARTITION**

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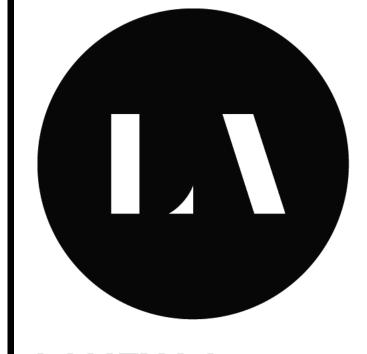
14. WALKING SURFACES OF THE MEANS OF EGRESS SHALL HAVE A SLIP RESISTANT SURFACE AND BE SECURELY ATTACHED.

15. GROUND AND FLOOR SURFACES ALONG ACCESSIBLE ROUTES AND IN ACCESSIBLE ROOMS AND SPACES, INCLUDING FLOORS, WALKS, RAMPS STAIRS, AND CURB RAMPS SHALL BE STABLE, FIRM, AND SLIP RESISTANT.

16. PROVIDE FURRED WALLS AS REQUIRED FOR ALL UTILITY AND DRAIN LINE THAT EXTEND UP THE INTERIOR WALL SURFACE.

17. PROVIDE 2A-10BC FIRE EXTINGUISHER IN LOCATIONS AS REQUIRED BY FIR DEPARTMENT. PROVIDE SIGN, APPROVED BY THE FIRE DEPARTMENT, REQUIRED TO INDICATE THE LOCATION OF THE FIRE EXTINGUISHER.

18. SEE INTERIOR DESIGN DRAWINGS FOR ADDITIONAL INFORMATION. 19. TANDUM SPACES TO BE ASSIGNED TO THE SAME UNIT.



LANEY LA LIFESTYLE + ARCHITECTURE

PROJECT NAME

PROJECT NUMBER

REAL QUEST HOLDING, LLC MR. MICHAEL WANG C/O CHIH 3129 S HACIENDA BLVD. #649

HACIENDA HEIGHTS, CA 91745 (626) 271-5322 **PROJECT ADDRESS**

21809-21811 FIGUEROA STREET

CARSON, CA 90745

ARCHITECT ANTHONY LANEY AIA LANEY LA, INC. 13110 HAWTHORNE BLVD. UNIT A **HAWTHORNE CA 90250** (310) 498-2455

ANTHONY@LANEY.LA

NOT FOR CONSTRUCTION

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5	07/10/18	DEVELOPMENT APPLICATION REVISION

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PROJECT NO: 17065


SHEET TITLE

FLOOR PLAN -SECOND FLOOR



CAST-IN-PLACE CONCRETE


NO PARKING ZONE

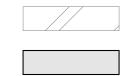

LIGHTWEIGHT CONCRETE FINISH

ACRYLIC DECK COATINGS

CLASS 1 STANDPIPE

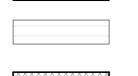

CMU WALL, SEE WALL TYPES SHEET



FIRE EXTINGUISHER CABINET, SEE DETAILS 25/A8.10 AND 24/A8.10

WALL FIRE SEPARATIONS LEGEND

1 HOUR FIRE PARTITION ____ **3 HOUR FIRE PARTITION**

SHEET NOTES

01. REFER TO SHEET A0.02 FOR GRAPHIC SYMBOLS AND ABBREVIATIONS. 02. DIMENSIONS ARE TO CENTERLINE OF COLUMN, FACE OF STUD, FACE OF CONCRETE, OR FACE OF MASONRY, UNLESS NOTED OTHERWISE.

03. ANY DISCREPANCIES NOTED SHALL BE BROUGHT TO THE ATTENTION OF THE ARCHITECT FOR CLARIFICATION PRIOR TO BEGINNING WORK.

04. ALL STRUCTURAL, PLUMBING, MECHANICAL, AND ELECTRICAL INFORMATION SHOWN ON THIS SHEET IS FOR REFERENCE ONLY. REFER TO CONSULTANTS DRAWINGS PREPARED BY THE ENGINEER. FOR ALL FRAMING, REFER TO STRUCTURAL DRAWINGS PREPARED BY THE STRUCTURAL ENGINEER. CONTRACTOR TO VERIFY ANY DISCREPANCIES WITH THE ARCHITECT PRIOR TO BEGINNING WORK.

05. APPROVED SET OF PLANS FOR BUILDING, FIRE SPRINKLER, FIRE ALARM, ETC. SHALL BE ON THE JOB SITE DURING CONSTRUCTION AND NO INSPECTIONS WILL BE MADE WITHOUT COMPLIANCE WITH THE ABOVE PROVISION.

06. REFER TO SHEET "WALL TYPES" FOR WALL TYPE DETAILS.

07. REFER TO SHEETS "BUILDING CODE ANALYSIS" FOR EGRESS, CODE ANALYSIS, AND FIRE RATED ASSEMBLY INFORMATION.

08. REFER TO SHEETS "SLAB PLANS" FOR GRADES AND DRAINAGE. 09. REFER TO SHEETS "FINISH PLANS" AND "INTERIOR FINISH SCHEDULE"

10. REFER TO SHEET "WINDOW SCHEDULE AND TYPES" AND "STORE FRONT SCHEDULEAND TYPES" FOR WINDOW AND STOREFRONT TYPES AND GLAZING INFORMATION.

12. REFER TO LANDSCAPE DRAWINGS FOR COLORS, FINISHES, THICKNESS, REINFORCING, AND CONTROL/EXPANSION JOINTS OF WALKS AND HARDSCAPE AREA.

13. ALL ILLUMINATED EXIT SIGNS SHOWN SHALL BE CLEARLY VISIBLE AND NOT OBSTRUCTED BY PIPES, MECHANICAL DUCTWORK, EQUIPMENT, ETC. CONTRACTOR TO PROVIDE PENDANT EXTENSIONS AT ALL CEILING HUNG EXIT SIGNS AS REQUIRED PER GOVERNING CODE REQUIREMENTS.

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LANEY LA LIFESTYLE + ARCHITECTURE

PROJECT NAME

PROJECT NUMBER

REAL QUEST HOLDING, LLC MR. MICHAEL WANG C/O CHIH

3129 S HACIENDA BLVD. #649 HACIENDA HEIGHTS, CA 91745 (626) 271-5322

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PROJECT NO: 17065

SHEET TITLE

MODEL FILE:

FLOOR PLAN -THIRD FLOOR



CAST-IN-PLACE CONCRETE

NO PARKING ZONE

LIGHTWEIGHT CONCRETE FINISH ACRYLIC DECK COATINGS

CMU WALL, SEE WALL TYPES SHEET

FIRE EXTINGUISHER CABINET, SEE DETAILS 25/A8.10 AND 24/A8.10

CLASS 1 STANDPIPE

WALL FIRE SEPARATIONS LEGEND 1 HOUR FIRE PARTITION . — - - — 2 HOUR FIRE PARTITION **3 HOUR FIRE PARTITION**

SHEET NOTES

01. REFER TO SHEET A0.02 FOR GRAPHIC SYMBOLS AND ABBREVIATIONS. 02. DIMENSIONS ARE TO CENTERLINE OF COLUMN, FACE OF STUD, FACE

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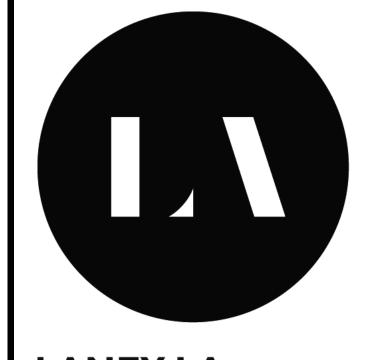
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18. SEE INTERIOR DESIGN DRAWINGS FOR ADDITIONAL INFORMATION. 19. TANDUM SPACES TO BE ASSIGNED TO THE SAME UNIT.

FOURTH FLOOR PLAN +30.0'

SCALE: 1/8" = 1'-0"



LANEY LA LIFESTYLE + ARCHITECTURE

PROJECT NAME

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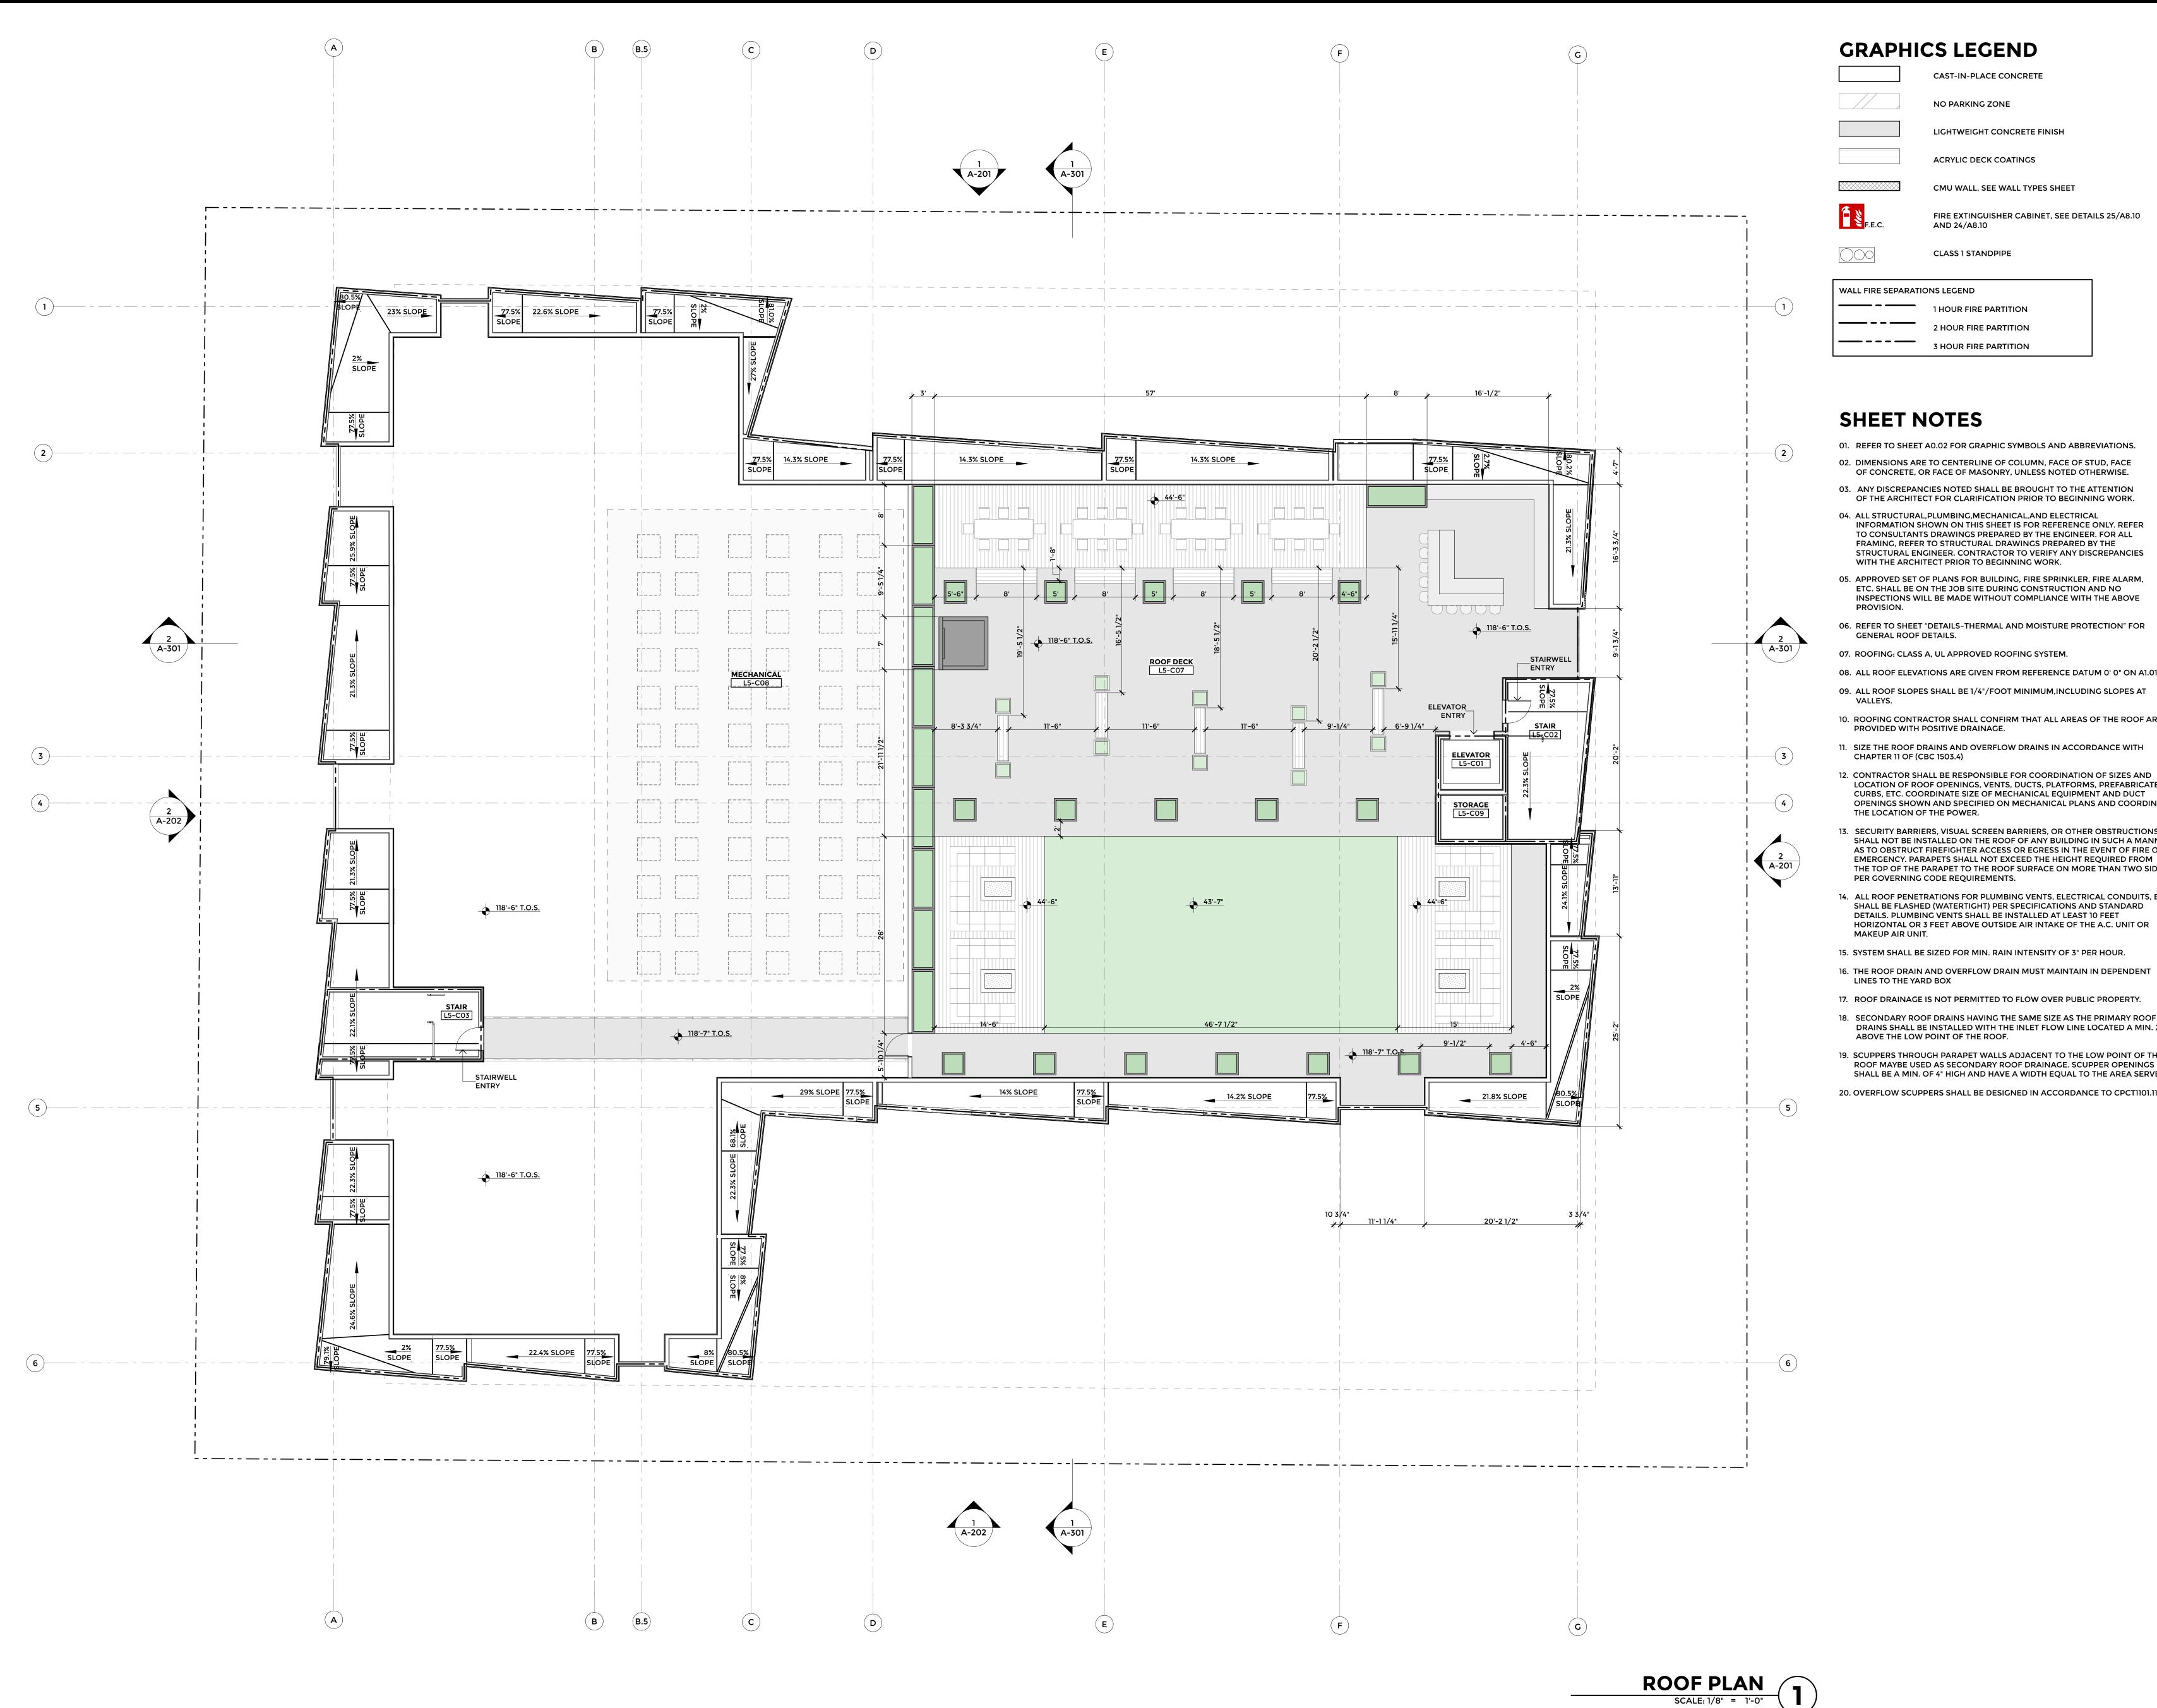
PROJECT NO: 17065

DRAWN BY: DD

SHEET TITLE

MODEL FILE:

FLOOR PLAN -**FOURTH FLOOR**



CAST-IN-PLACE CONCRETE

NO PARKING ZONE

LIGHTWEIGHT CONCRETE FINISH

CMU WALL, SEE WALL TYPES SHEET

ACRYLIC DECK COATINGS

FIRE EXTINGUISHER CABINET, SEE DETAILS 25/A8.10

CLASS 1 STANDPIPE

AND 24/A8.10

WALL FIRE SEPARATIONS LEGEND 1 HOUR FIRE PARTITION **3 HOUR FIRE PARTITION**

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- 06. REFER TO SHEET "DETAILS-THERMAL AND MOISTURE PROTECTION" FOR GENERAL ROOF DETAILS.
- 07. ROOFING: CLASS A, UL APPROVED ROOFING SYSTEM.
- 08. ALL ROOF ELEVATIONS ARE GIVEN FROM REFERENCE DATUM 0' 0" ON A1.01
- 09. ALL ROOF SLOPES SHALL BE 1/4"/FOOT MINIMUM,INCLUDING SLOPES AT
- 10. ROOFING CONTRACTOR SHALL CONFIRM THAT ALL AREAS OF THE ROOF ARE PROVIDED WITH POSITIVE DRAINAGE.
- 11. SIZE THE ROOF DRAINS AND OVERFLOW DRAINS IN ACCORDANCE WITH CHAPTER 11 OF (CBC 1503.4)
- 12. CONTRACTOR SHALL BE RESPONSIBLE FOR COORDINATION OF SIZES AND LOCATION OF ROOF OPENINGS, VENTS, DUCTS, PLATFORMS, PREFABRICATED CURBS, ETC. COORDINATE SIZE OF MECHANICAL EQUIPMENT AND DUCT OPENINGS SHOWN AND SPECIFIED ON MECHANICAL PLANS AND COORDINA THE LOCATION OF THE POWER.
- 13. SECURITY BARRIERS, VISUAL SCREEN BARRIERS, OR OTHER OBSTRUCTIONS SHALL NOT BE INSTALLED ON THE ROOF OF ANY BUILDING IN SUCH A MAN AS TO OBSTRUCT FIREFIGHTER ACCESS OR EGRESS IN THE EVENT OF FIRE O EMERGENCY. PARAPETS SHALL NOT EXCEED THE HEIGHT REQUIRED FROM THE TOP OF THE PARAPET TO THE ROOF SURFACE ON MORE THAN TWO SID PER GOVERNING CODE REQUIREMENTS.
- 14. ALL ROOF PENETRATIONS FOR PLUMBING VENTS, ELECTRICAL CONDUITS, SHALL BE FLASHED (WATERTIGHT) PER SPECIFICATIONS AND STANDARD DETAILS. PLUMBING VENTS SHALL BE INSTALLED AT LEAST 10 FEET HORIZONTAL OR 3 FEET ABOVE OUTSIDE AIR INTAKE OF THE A.C. UNIT OR
- 15. SYSTEM SHALL BE SIZED FOR MIN. RAIN INTENSITY OF 3" PER HOUR.
- LINES TO THE YARD BOX
- 18. SECONDARY ROOF DRAINS HAVING THE SAME SIZE AS THE PRIMARY ROOF
- DRAINS SHALL BE INSTALLED WITH THE INLET FLOW LINE LOCATED A MIN. 2 ABOVE THE LOW POINT OF THE ROOF.
- SHALL BE A MIN. OF 4" HIGH AND HAVE A WIDTH EQUAL TO THE AREA SERVE 20. OVERFLOW SCUPPERS SHALL BE DESIGNED IN ACCORDANCE TO CPCT1101.11

LANEY LA LIFESTYLE + ARCHITECTURE

PROJECT NAME BIRCH

PROJECT NUMBER

CLIENT REAL QUEST HOLDING, LLC MR. MICHAEL WANG C/O CHIH

3129 S HACIENDA BLVD. #649 HACIENDA HEIGHTS, CA 91745 (626) 271-5322

PROJECT ADDRESS 21809-21811 FIGUEROA STREET **CARSON, CA 90745**

ARCHITECT ANTHONY LANEY AIA LANEY LA, INC. 13110 HAWTHORNE BLVD. UNIT A **HAWTHORNE CA 90250** (310) 498-2455 ANTHONY@LANEY.LA

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PROJECT NO: 17065

DRAWN BY: DD CHK'D BY: PC

MODEL FILE:

SHEET TITLE

FLOOR PLAN - ROOF **LEVEL**



NORTH ELEVATION

SCALE: 1/8" = 1'-0"





LANEY LA

LIFESTYLE + ARCHITECTURE

PROJECT NAME BIRCH

(626) 271-5322

PROJECT NUMBER

CLIENT
REAL QUEST HOLDING, LLC
MR. MICHAEL WANG C/O CHIH
WANG
3129 S HACIENDA BLVD. #649
HACIENDA HEIGHTS, CA 91745

PROJECT ADDRESS 21809-21811 FIGUEROA STREET CARSON, CA 90745

ARCHITECT
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13110 HAWTHORNE BLVD. UNIT A
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PROJECT NO: 17065

MODEL FILE:

DRAWN BY: DD

CHK'D BY: PC

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SHEET TITLE

BUILDING ELEVATIONS



*ALL OPERABLE WINDOWS ON WEST FACADE TO BE USED FOR EGRESS ONLY;

WINDOWS TO BE HARDWIRED TO FIRE ALARM TO TRIGGER WHEN OPENED



LANEY LA LIFESTYLE + ARCHITECTURE

PROJECT NAME

(626) 271-5322

PROJECT NUMBER

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SHEET TITLE

BUILDING **ELEVATIONS**







KEYNOTES

- 1 WOOD STUD WALL WITH BRICK VENEER
- 2 VERTICAL WOOD CLADDING
- WOOD STUD WALL WITH SANDY GREY STUCCO FINISH
- 2" METAL RAILING SET AT 42" HIGH WITH 3 7/8" GAP
- 5 42" PAINTED METAL RAILING
- 6 CONCRETE COLUMNS PAINTED WHITE
- 7 CONCRETE WALL WITH STUCCO FINISH, PAINTED WHITE
- 8 CONCRETE SLAB
- 9 WOOD FLOOR ASSEMBLY
- 10 INTERIOR STUD WALL
- 11 42" PLANTER WITH BRICK VENEER
- 12 ROOF DECK ASSEMBLY
- 13 SLIDING DOOR
- 14 WOOD CABANA
- FIXED WINDOW WITH AWNING WINDOW ABOVE
- 16 OUTDOOR KITCHEN
- OVERHANG WITH WOOD CLADDING
- 18 STUD WALL WITH WOOD CLADDING
- 19 MECHANICAL EQUIPMENT SCREENING
- STEEL PLATE AWNING, PAINTED TO MATCH WINDOW FRAME COLOR



LANEY LA

LIFESTYLE + ARCHITECTURE

PROJECT NAME BIRCH

(626) 271-5322

PROJECT NUMBER

CLIENT
REAL QUEST HOLDING, LLC
MR. MICHAEL WANG C/O CHIH
WANG
3129 S HACIENDA BLVD. #649
HACIENDA HEIGHTS, CA 91745

PROJECT ADDRESS 21809-21811 FIGUEROA STREET CARSON, CA 90745

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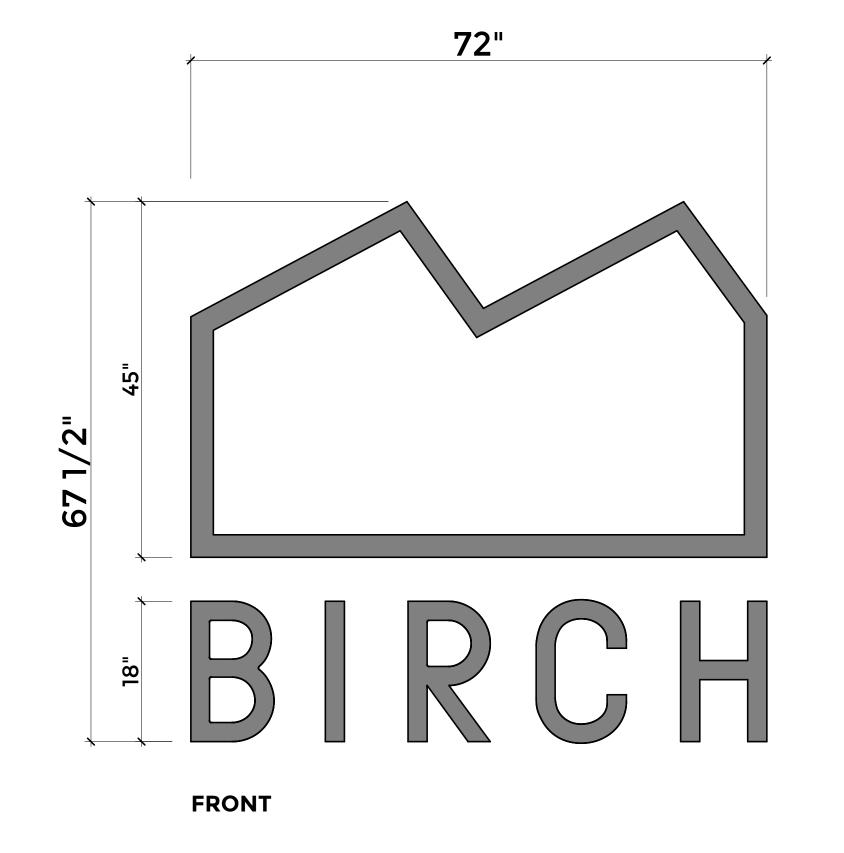
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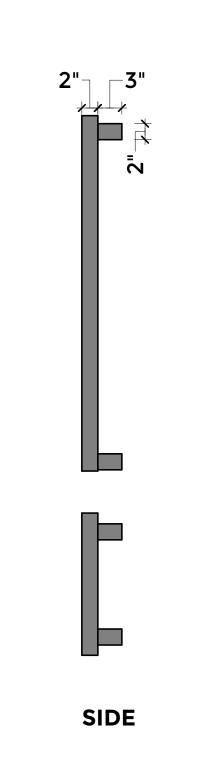
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SHEET TITLE

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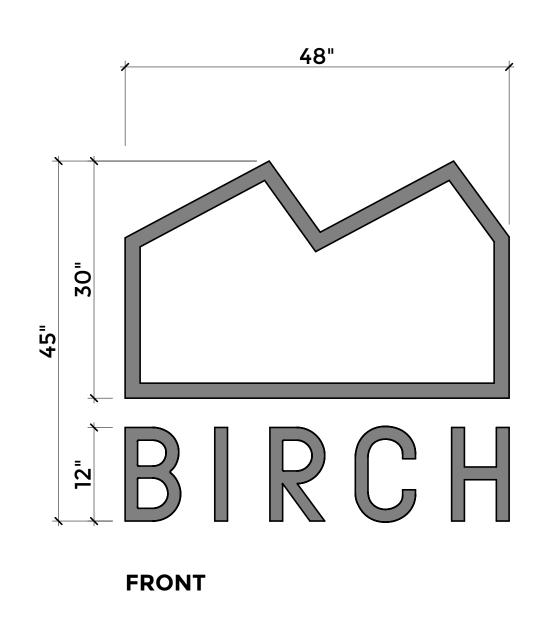
BUILDING SECTIONS






SIGNB
SCALE: 1" = 1'-0"

SIGN AREA:



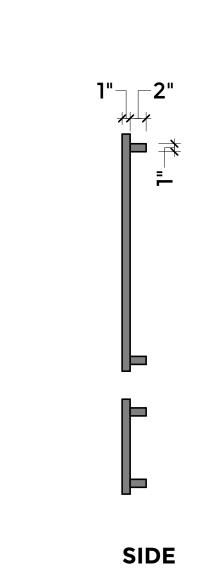


SIGN DESCRIPTION:
INDIVIDUAL ALUMINUM FABRICATED
HALO CHANNEL LETTERS WITH LED
BACKLIGHTING.

34 SF, HEIGHT NOT TO EXCEED 68"

SIGN AREA:





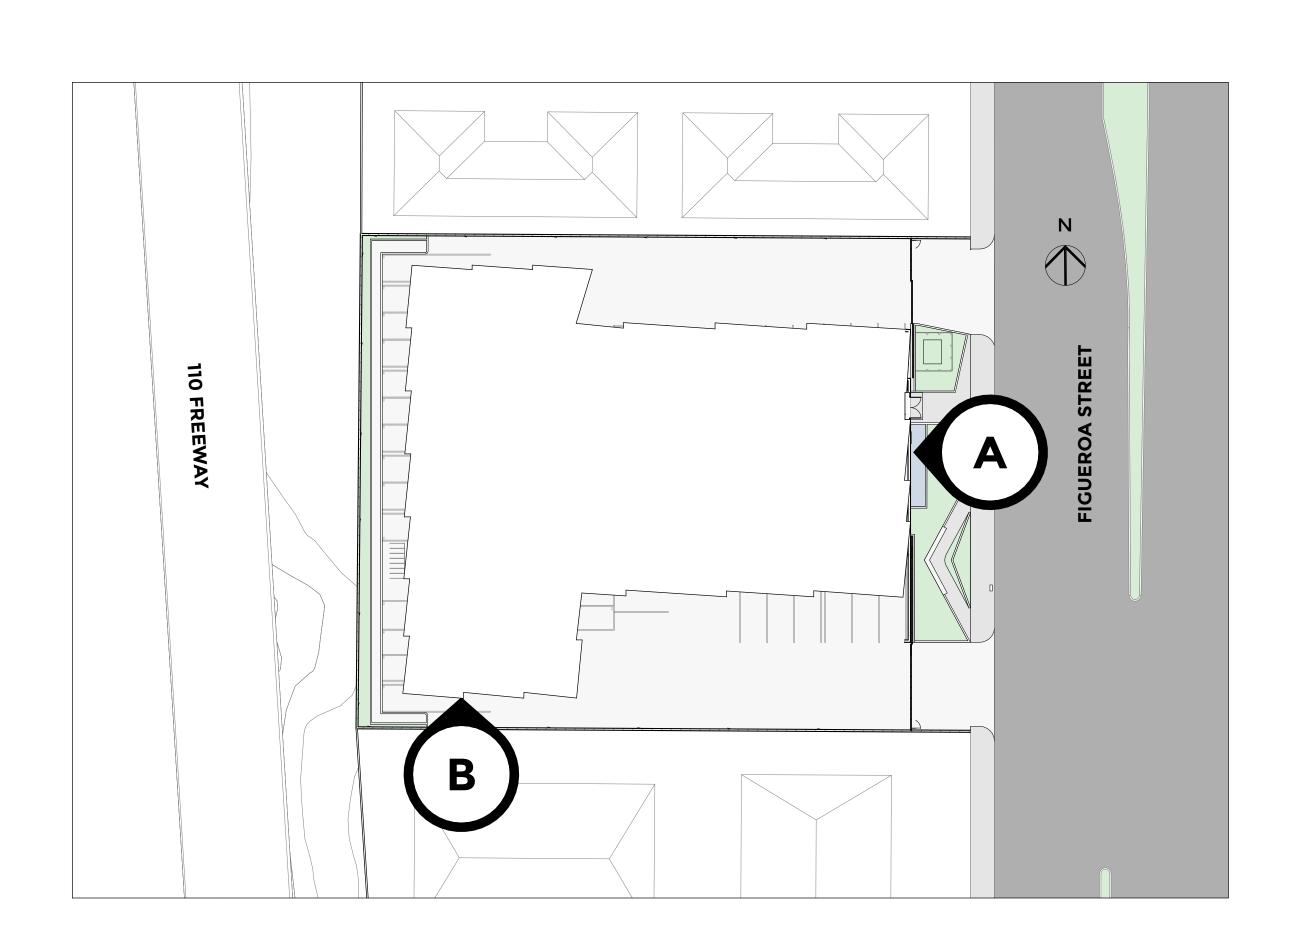



LANEY LA, INC.
13110 HAWTHORNE BLVD. UNIT A
HAWTHORNE CA 90250
(310) 498-2455
ANTHONY@LANEY.LA

ARCHITECT
ANTHONY LANEY AIA

LANEY LA

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21809-21811 FIGUEROA STREET CARSON, CA 90745

PROJECT ADDRESS

BIRCH

CLIENT

(626) 271-5322

WANG

LIFESTYLE + ARCHITECTURE

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DD035	CTNC	1005
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SIGNAGE PLAN



LANEY LA

LIFESTYLE + ARCHITECTURE

PROJECT NAME

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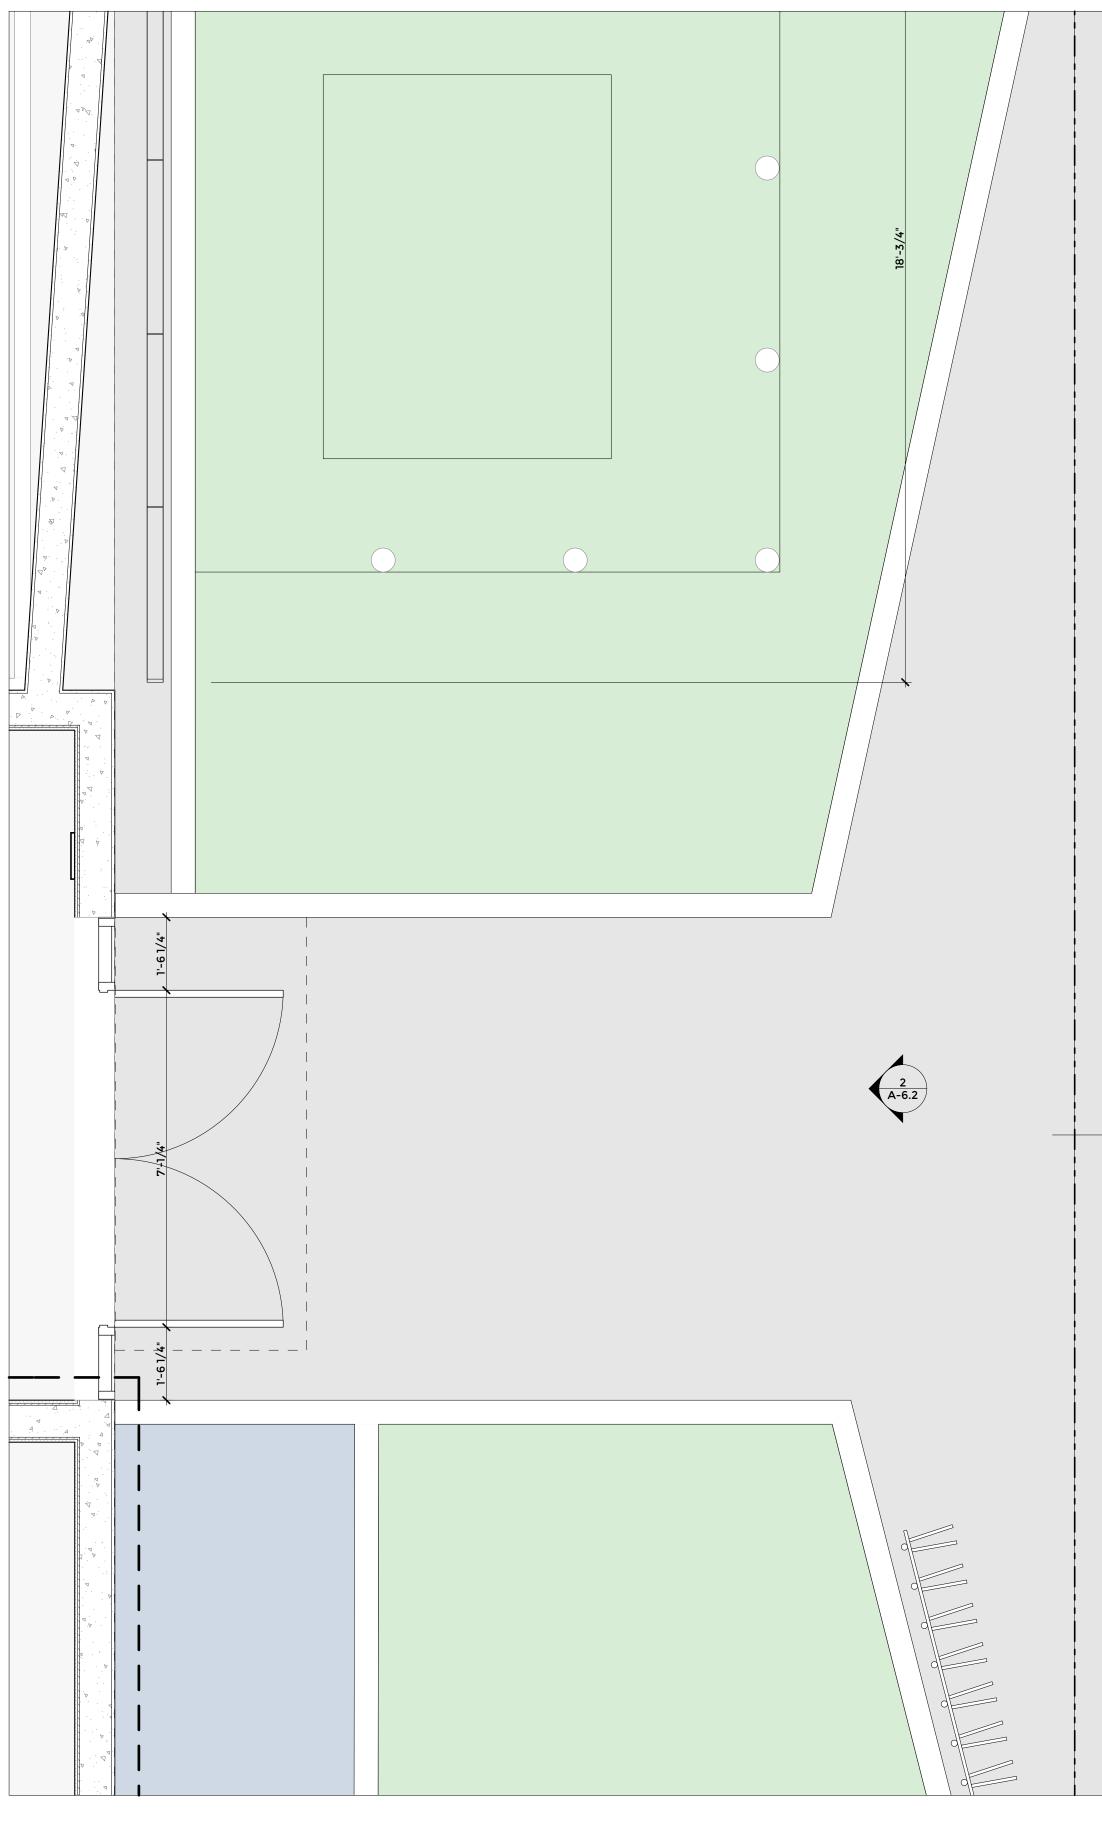
CHK'D BY:

MAIN ENTRY ENLARGED DRAWINGS



ENTRY PERSPECTIVE

SCALE: 1' = 1'-0"



ENTRY PLAN

| SCALE: 1/2" = 1'-0" | 1



SCALE: 1/4" = 1'-0"



PROJECT NAME

LIFESTYLE + ARCHITECTURE

PROJECT NUMBER

BIRCH

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SHEET TITLE

MAIN ENTRY ENLARGED DRAWINGS



SLIDING GATE PAINT COLOR

BENJAMIN MOORE BLACK IRON





TITAN TREE UP-LIGHT

SPJ LIGHTING INC. **GUN METAL FINISH**



SPJ-MMW1 WALL WASHER LIGHT

SPJ LIGHTING INC. **GUN METAL FINISH**



12V UNDERWATER LIGHT

VISTA PRO LIGHTING STAINLESS STEEL FINISH




LED RECESSED BOX

SPJ LIGHTING INC. **GUN METAL FINISH**



FIBER CEMENT BOARD SIDING (FACADE ACCENT MATERIAL, EXTERIOR BALCONY SIDING)

JAMES HARDIE HARDIE PANEL VERITCAL SIDING SMOOTH **TIMBER BARK**

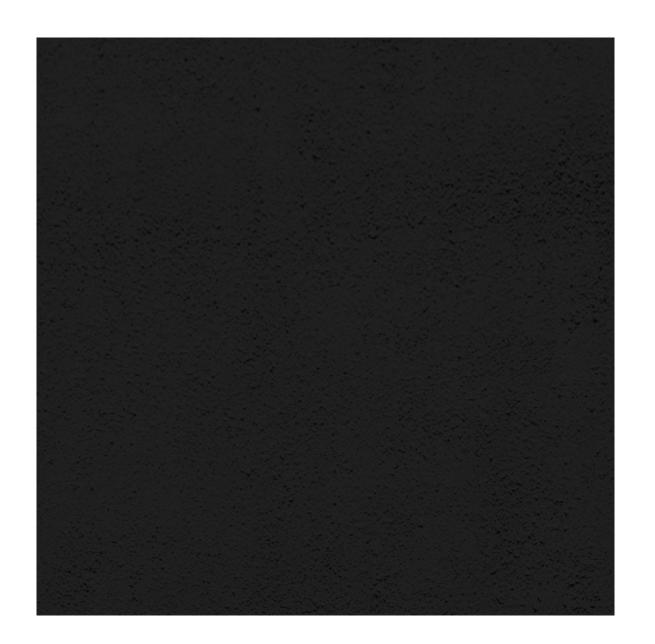

EXTERIOR STUCCO AT LEVELS 2 AND HIGHER WHERE BRICK DOES NOT OCCUR


* THE PROJECT WILL ALSO USE RECYCLED

ASPHALT AT THE PARKING LEVEL AND FLY-

ASH IN CONCRETE FOR THE CONCRETE

PODIUM

OMEGA COLORTEK 16/20 SAND FINISH STUCCO PAINT WITH BENJAMIN MOORE **BLACK IRON**

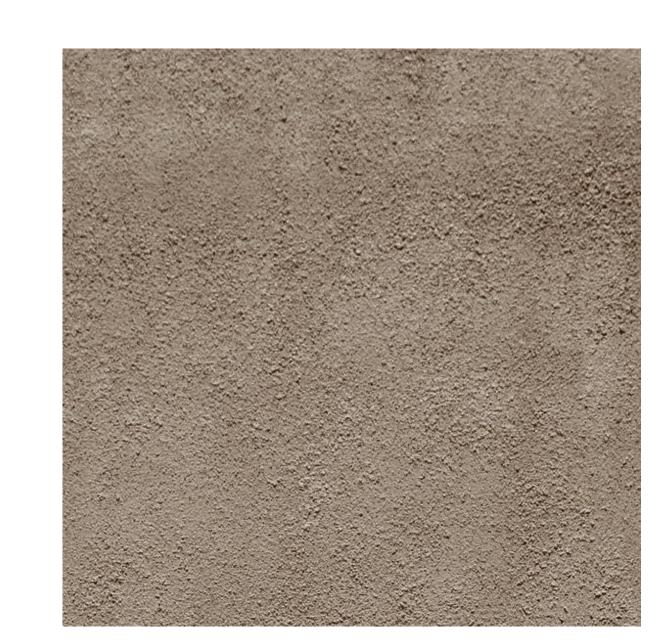


EXTERIOR BRICK FACADES

ENDICOTT

MANGANESE

EXTERIOR STUCCO FACADES AT GROUND FLOOR LEVEL

OMEGA COLORTEK 16/20 SAND FINISH STUCCO PAINT WITH BENJAMIN MOORE **TAOS TAUPE**

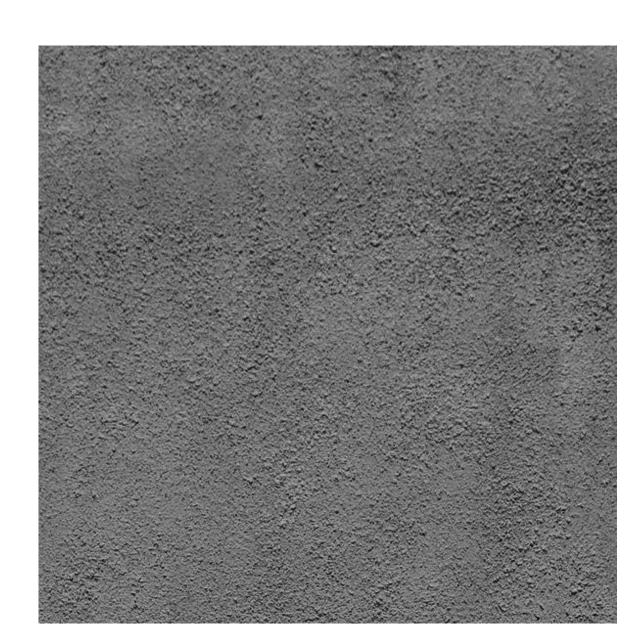

EXTERIOR STUCCO PERIMETER WALL

OMEGA COLORTEK 16/20 SAND FINISH STUCCO PAINT WITH BENJAMIN MOORE DIOR GRAY



PROJECT NUMBER

CLIENT REAL QUEST HOLDING, LLC MR. MICHAEL WANG C/O CHIH 3129 S HACIENDA BLVD. #649 HACIENDA HEIGHTS, CA 91745 THIN BRICK

> PROJECT ADDRESS 21809-21811 FIGUEROA STREET CARSON, CA 90745

(626) 271-5322

ARCHITECT ANTHONY LANEY AIA LANEY LA, INC. 13110 HAWTHORNE BLVD. UNIT A HAWTHORNE CA 90250 (310) 498-2455 ANTHONY@LANEY.LA

NOT FOR CONSTRUCTION

MARK	DATE	DESCRIPTION				
1	06/05/17	DEVELOPMENT APPLICATION SUBMISSION				
2	08/16/17	1ST REVIEW RE-SUBMITTAL				
3	11/30/17	100% DESIGN DEVELOPMENT				
4	07/10/18	DEVELOPMENT APPLICATION REVISION				
PROJE	CT NO:	17065				
MODE	L FILE:					

SHEET TITLE

DRAWN BY: DD CHK'D BY: PC

MATERIALS

A STIPA TENUISSIMA
'MEXICAN FEATHERGRASS'
(WUCOLS - LOW)



B AGAVE ATTENUATA
'FOX TAIL AGAVE'
(WUCOLS - LOW)



C SENECIO SERPENS
'BLUE CHALKSTICKS'
(WUCOLS - LOW)



D EUPHORBIA MYRSINITES
'MYRTLE SPURGE'
(WUCOLS - LOW)



PARTHENOCISSUS TRICUSPIDATA
'BOSTON IVY'
(WUCOLS - MEDIUM)



F CAREX TUMULICOLA
'BERKELEY SEDGE'
(WUCOLS - LOW)



MISCANTHUS SINENSIS 'MORNING LIGHT'
'MAIDEN GRASS'
(WUCOLS - MEDIUM)



H GINKGO BILOBA 'PRINCETON SENTRY'
'MAIDENHAIR TREE'
(WUCOLS - MEDIUM)




J PODOCARPUS ELONGATUS ICEE BLUE
'YELLOW WOOD'
(WUCOLS - MEDIUM)



COLEA EUROPAEA 'SWAN HILL'
'FRUITLESS OLIVE'
(WUCOLS - LOW)



WESTRINGIA FRUTICOSA 'MORNING LIGHT'
'COAST ROSEMARY'
(WUCOLS - LOW)

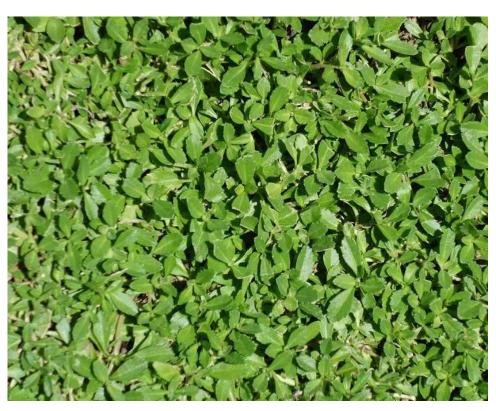

N KURAPIA
'SOD'
(WUCOLS - LOW)

5

0 ~

rain ville • design • studio
landscape design + planning

1632 aviation blvd redondo beach california 90278

ph 310.378.2650 miriam@rainvilledesign.com

REVI	SION
09.26.2017	
11.02.2017	
11.20.2017	
11.21.2018	

DATE: 11.21.2018

SCALE: AS SHOWN

DRAWN BY: AQ

CONCEPTUAL PLANT IMAGES

L-U

CONCEPT IMAGES



1. <u>Drainage</u> WITH 12" OF WATER. THE WATER SHALL DRAIN OVERNIGHT. IF IT DOESN'T, YOU HAVE A DRAINAGE PROBLEM WHICH NEED TO BE CORRECTED WITH A FRENCH DRAIN OR SOME OTHER METHOD THAT TAKES EXCESS WATER DOWN AND AWAY FROM THE BOTTOM OF THE ROOT BALL.

2. PLANTING

THE HOLE SHALL BE 2' WIDER THAN THE BOX SIZE AND THE SAME DEPTH AS THE ROOT BALL. LEAVE THE BOTTOM FOR 48" BOX SIZES AND LARGER FOR STABILITY AND SAFETY. VERIFY THE TOP OF THE ROOT BALL IS EVEN OR SLIGHTLY HIGHER THAN THE SURROUNDING SOIL.

3. SOIL PIPES

48" BOX AND LARGER TREES SHALL HAVE FOR 4" PERFORATED PVC PIPES INSTALLED ON ALL FOUR SIDES TO THE BOTTOM OF THE ROOT BALL. FILL 3 PIPES WITH GRAVEL FOR DEEP FEEDING AND WATERING. USE THE FOURTH PIPE FOR CHECKING THE CONDITION OF THE ROOT BALL (TOO MUCH WATER OR TOO DRY). CAP ALL PIPES APPROXIMATELY 4" ABOVE SOIL LEVEL. RELEASE 20-5-5 FERTILIZER MIXED HALF-AND-HALF WITH BLOODMEAL.

THE FIRST 12 TO 18 MONTHS. WATER AS OFTEN AS NECESSARY TO KEEP THE ROOT BALL MOIST, BUT NOT SATURATED. THIS MAY MEAN WATERING EVERY 2 TO 3 DAYS AT FIRST, OR ONLY ONCE A WEEK. HOW YOU WATER WILL DEPEND ON THE WEATHER, HOW HOT OR DRY YOUR AREA IS AND YOUR SOIL TYPE. BE ESPECIALLY CAREFUL TO KEEP THE TREES WATERED DURING SANTA ANA WINDS.

6. <u>FERTILIZING</u>

THE TREE SHOULD BE FED IN MARCH, JUNE AND SEPTEMBER WITH A SLOW

LEGEND	QTY	SIZE	ARRANGEMENT	BOTANICAL NAME	COMMON NAME	HEIGHT	WIDTH	IV	NOTES
Α	2	QT FLAT	PER PLAN	STIPA TENUISSIMA	MEXICAN FEATHERGRASS	1'-3'	1'-3'	LOW	
В	4	5 GAL	PER PLAN	AGAVE ATTENUATA	FOX TAIL AGAVE	3'-4'	4'-6'	LOW	
С	4	QT FLAT	PER PLAN	SENECIO SERPENS	BLUE CHALKSTICKS	3'-4'	4'-6'	LOW	
D	31	1 GAL	PER PLAN	EUPHORBIA MYRSINITES	MYRTLE SPURGE	1'	1'-2'	LOW	
E	10	1 GAL	PER PLAN	PARTHENOCISSUS TRICUSPIDATA	BOSTON IVY	6'-8'	8'-10'	MED	
F	6	QT FLAT	PER PLAN	CAREX TUMULICOLA	BERKELEY SEDGE	1'	1'-2'	LOW	
G	15	1 GAL	PER PLAN	MISCANTHUS SINENSIS 'MORNING LIGHT'	MAIDEN GRASS	3'-4'	3'-4'	MED	
н	2	24" BOX	PER PLAN	GINKGO BILOBA 'PRINCETON SENTRY'	MAIDENHAIR TREE	35'-40'	15'-20'	MED	

- SOIL TO BE SAMPLED BY WALLACE LABS (310.615.0116)
- CONTRACTOR TO AMEND PER WALLACE LAB RECOMMENDATION - 2" MIN. - LEAF POST MULCH ON SURFACE OF ALL P.A. - DURA EDGE AT ALL P.A. EDGES WWW.JDRUSSELCO.COM (800.888.7425) - WEATHER BASED AUTOMATED IRRIGATION SHALL BE PROVIDED FOR ALL THE LANDSCAPED AREAS


- A MINIMUM 3-INCH LAYER OF MULCH SHALL BE APPLIED ON ALL EXPOSED SOIL SURFACES OF PLANTING AREAS EXCEPT TURF AREAS, CREEPING OR ROOTING GROUNDCOVERS, OR DIRECT SEEDING APPLICATIONS WHERE IS CONTRAINDICATED.



STREET
1/8": 1'-0"

DATE: 11.21.2018 SCALE: AS SHOWN

PLANTING PLAN

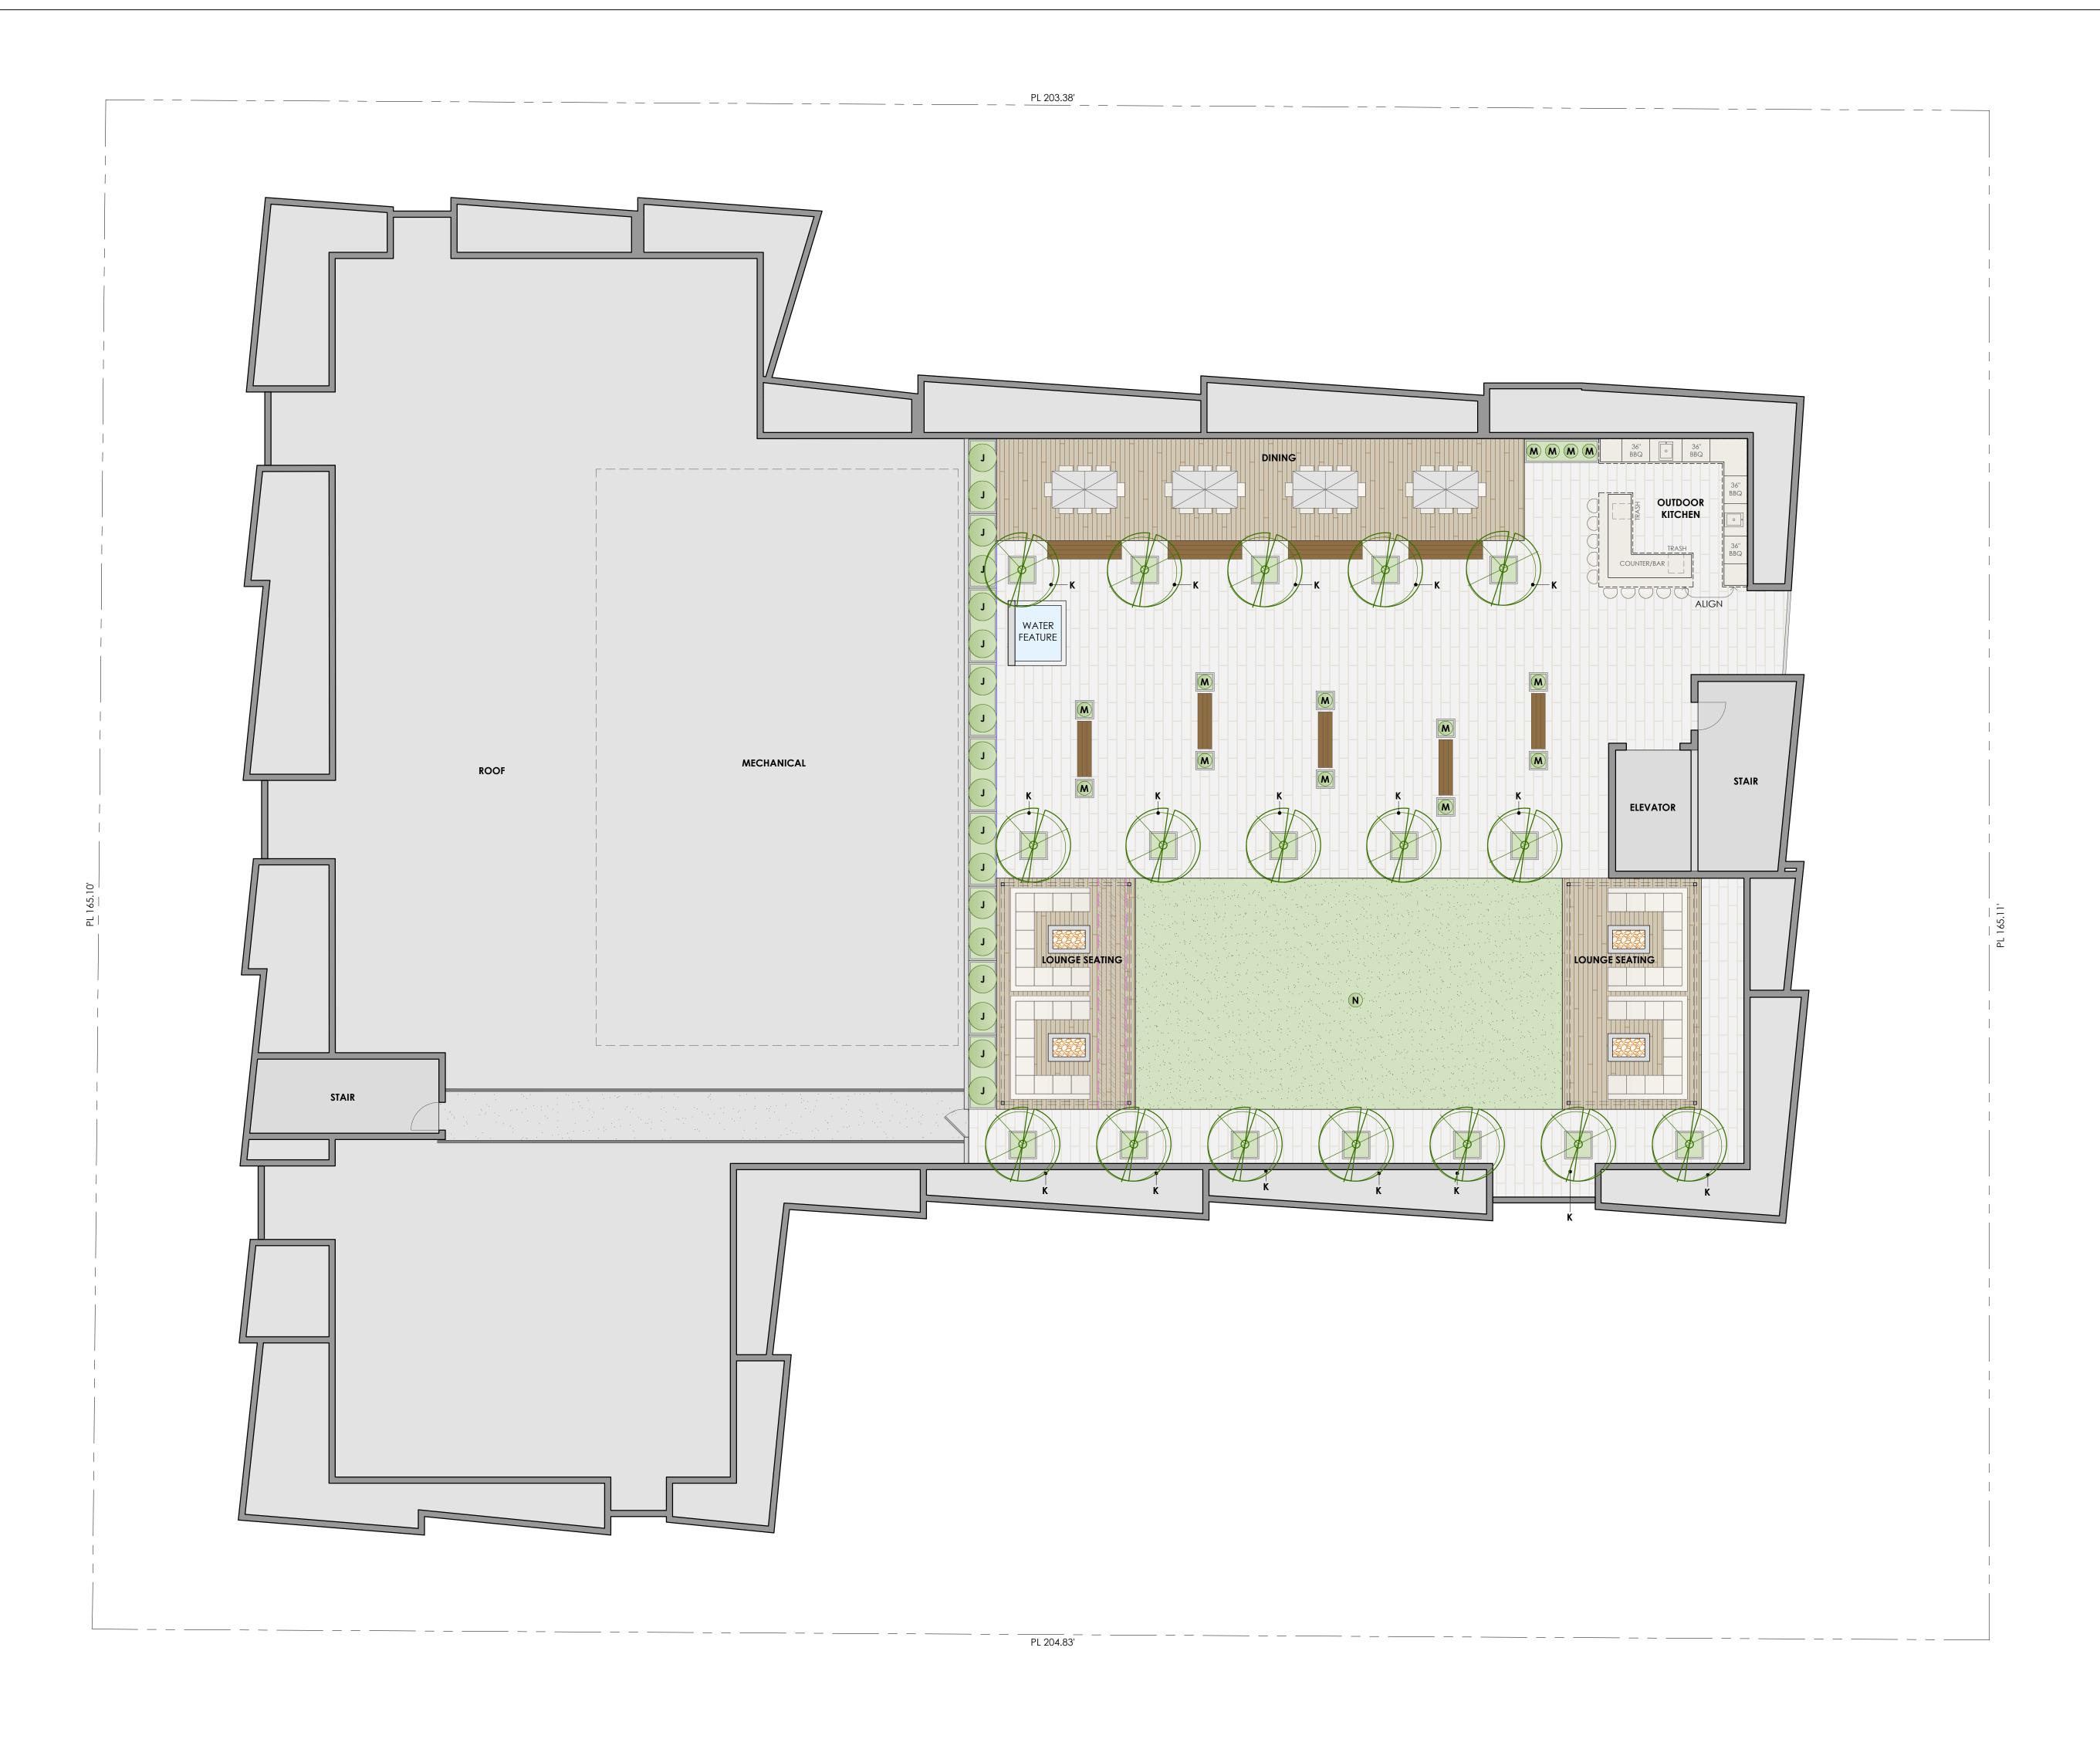

TREE PLANTING AND CARE INSTRUCTIONS

1. <u>DRAINAGE</u> PREPARE THE HOLE A COUPLE OF DAYS PRIOR TO PLANTING. FILL THE HOLE

USE LEFT OVER SOIL MIX TO BUILD A SEVERAL-INCH-HIGH CIRCULAR WITH 12" OF WATER. THE WATER SHALL DRAIN OVERNIGHT. IF IT DOESN'T, YOU HAVE A DRAINAGE PROBLEM WHICH NEED TO BE CORRECTED WITH A FRENCH DRAIN OR SOME OTHER METHOD THAT TAKES EXCESS WATER DOWN AND AWAY FROM THE BOTTOM OF THE ROOT BALL.

2. PLANTING THE HOLE SHALL BE 2' WIDER THAN THE BOX SIZE AND THE SAME DEPTH AS THE ROOT BALL. LEAVE THE BOTTOM FOR 48" BOX SIZES AND LARGER FOR STABILITY AND SAFETY. VERIFY THE TOP OF THE ROOT BALL IS EVEN OR

SLIGHTLY HIGHER THAN THE SURROUNDING SOIL. 3. SOIL PIPES 48" BOX AND LARGER TREES SHALL HAVE FOR 4" PERFORATED PVC PIPES INSTALLED ON ALL FOUR SIDES TO THE BOTTOM OF THE ROOT BALL. FILL 3 PIPES WITH GRAVEL FOR DEEP FEEDING AND WATERING. USE THE FOURTH PIPE FOR CHECKING THE CONDITION OF THE ROOT BALL (TOO MUCH

4. WATERING BERM OR BASIN WATERING BERM AROUND THE ROOT BALL. MAKE SURE THE BERM OR BASIN IS NO LARGER THAN THE ROOT BALL, OTHERWISE WATERING MAY WET THE SOIL AROUND THE TREE, BUT NOT THE ROOTBALL.

5. <u>WATERING</u>

IT IS VERY IMPORTANT TO KEEP A NEWLY PLANTED TREE WATERED DURING THE FIRST 12 TO 18 MONTHS. WATER AS OFTEN AS NECESSARY TO KEEP THE ROOT BALL MOIST, BUT NOT SATURATED. THIS MAY MEAN WATERING EVERY 2 TO 3 DAYS AT FIRST, OR ONLY ONCE A WEEK. HOW YOU WATER WILL DEPEND ON THE WEATHER, HOW HOT OR DRY YOUR AREA IS AND YOUR SOIL TYPE. BE ESPECIALLY CAREFUL TO KEEP THE TREES WATERED DURING SANTA ANA WINDS.

6. <u>FERTILIZING</u>

THE TREE SHOULD BE FED IN MARCH, JUNE AND SEPTEMBER WITH A SLOW WATER OR TOO DRY). CAP ALL PIPES APPROXIMATELY 4" ABOVE SOIL LEVEL. RELEASE 20-5-5 FERTILIZER MIXED HALF-AND-HALF WITH BLOODMEAL.

ROOF DECK LEVEL: PLANT LEGEND

LEGEND	QTY	SIZE	ARRANGEMENT	BOTANICAL NAME	COMMON NAME	HEIGHT	WIDTH	WUCOLS	NOTES
J	18	15 GAL	PER PLAN	PODOCARPUS ELONGATUS 'ICEE BLUE'	YELLOW WOOD	10'-15'	10'-15'	MED	
K	17	24" BOX	PER PLAN	OLEA EUROPAEA 'SWAN HILL'	FRUITLESS OLIVE	15'-20'	15'-20'	LOW	LOW BRANCHING/MUILTI
M	14	5 GAL	PER PLAN	WESTRINGIA FRUTICOSA 'MORNING LIGHT'	COAST ROSEMARY	3'-4'	3'-4'	LOW	
N	1200 SF	SOD	PER PLAN	KURAPIA	GROUND COVER SOD	6"	SOD	LOW	

WUCOLS IV NOTE:

WATER REQUIREMENTS FOR ALL PLANTS LISTED HAVE BEEN CONFIRMED BY WUCOLS IV PLANT DATABASE PROVIDED BY THE CALIFORNIA DEPARTMENT

OF WATER RESOURCES (DWR) WATER USE EFFICIENCY PROGRAM.

PLANTING NOTES:

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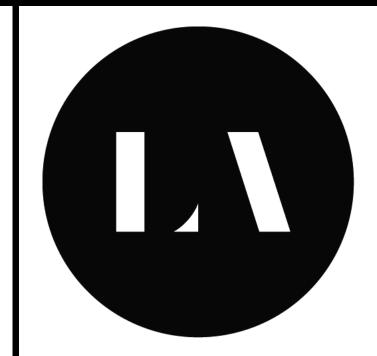
PLANTING PLAN



VIEW FROM STREET



VIEW FROM ABOVE



LANEY LA

LIFESTYLE + ARCHITECTURE

PROJECT NAME BIRCH

PROJECT NUMBER

CLIENT
REAL QUEST HOLDING, LLC
MR. MICHAEL WANG C/O CHIH
WANG
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HACIENDA HEIGHTS, CA 91745
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3	11/30/17	100% DESIGN DEVELOPMENT

PROJECT NO: 17065

MODEL FILE:

DRAWN BY: DD

CHK'D BY: PC

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SHEET TITLE

PERSPECTIVES

P-1