
CARSON LOFTS

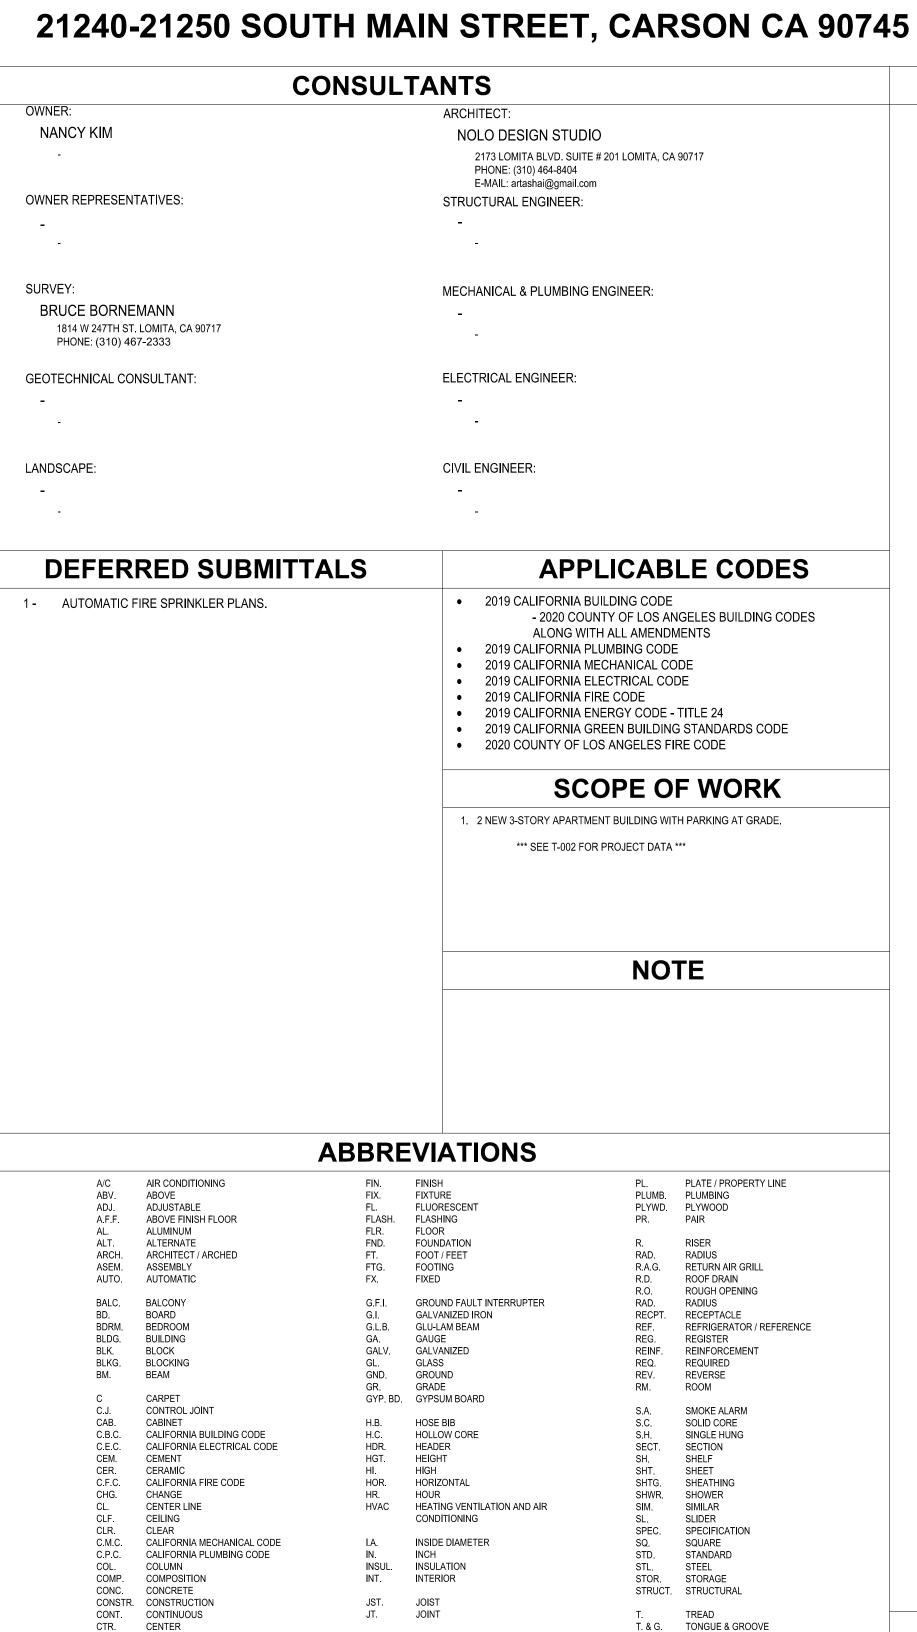

KIT. KITCHEN

MAS. MAT. MAX.

N.T.S.

O.A. O / OBS. OFF. OPNG.

LAVATORY

MATERIAL

MECHANICAL

MANUFACTURER

MISCELLANEOUS

METAL THRESHOLD

NOT IN CONTRACT

NOT TO SCALE

NATURAL

NUMBER

OBSCURE

OFFICE

OPENING

P.LAM. PLASTIC LAMINATE

PERIM PERIMETER
PERP. PERPENDICUL
PH. PHONE

OPPOSITE

PANTRY / POLE

PERPENDICULAR

PRESSURE TREATED

ON CENTER

OUTSIDE DIAMETER

MEMBRANE

MINIMUM

CASED OPENING

DOUGLAS FIF

DIAGONAL

DISPOSAL

DOWN

DOOR

DIMENSION

DOWNSPOUT

ELECTRIC

ENCLOSURE

EQUIPMENT

EXHAUST

EXPOSED

EXTERIOR

FACE OF CONCRETE

FACE OF FINISH

FACE OF MASONRY

ENCL.

EQUIP.

DISHWASHER

DOUBLE DETAIL T.B. T.O.C.

U.B.C.

V.T.R.

VENT. VERT. VEST.

VOL.

W.R.

TOP OF CURB

TOP OF WALL

TEMPERED

TRANSOM

TYPICAL

TRANSFORMER

UNIFORM BUILDING CODE

UNLESS NOTED OTHERWISE

VENT THROUGH ROOF

VENTILATION

WATER HEATER

WALK IN CLOSET

WATER RESISTANT

VERTICAL

VESTIBULE

VOLUME

WOOD

WEIGHT


WATERPROOF


UNDERWRITERS LABORATORY

T.O. DR. TOP OF DOOR T.O.M. TOP OF MASONRY
T.O.P. TOP OF PLATE
T. SHTG. TOP OF SHEATHING

T.O. WIN. TOP OF WINDOW

THICK

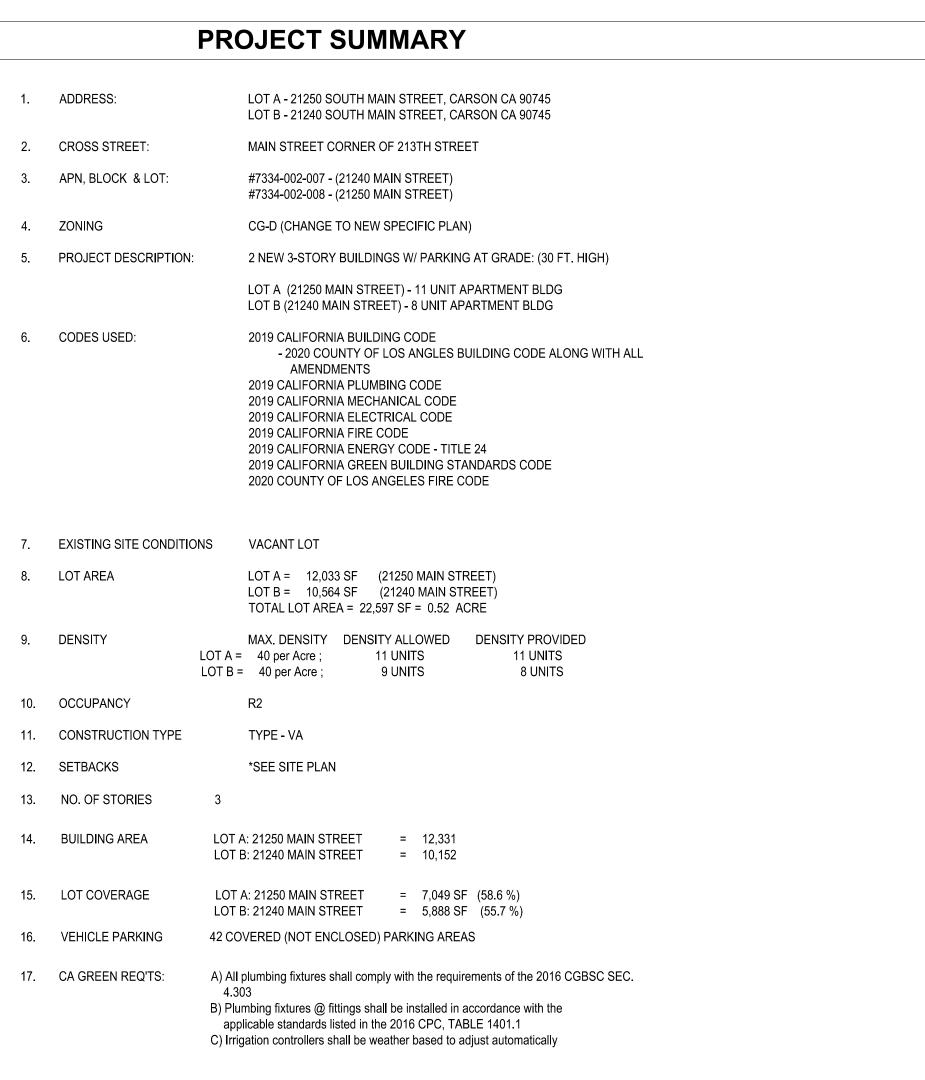

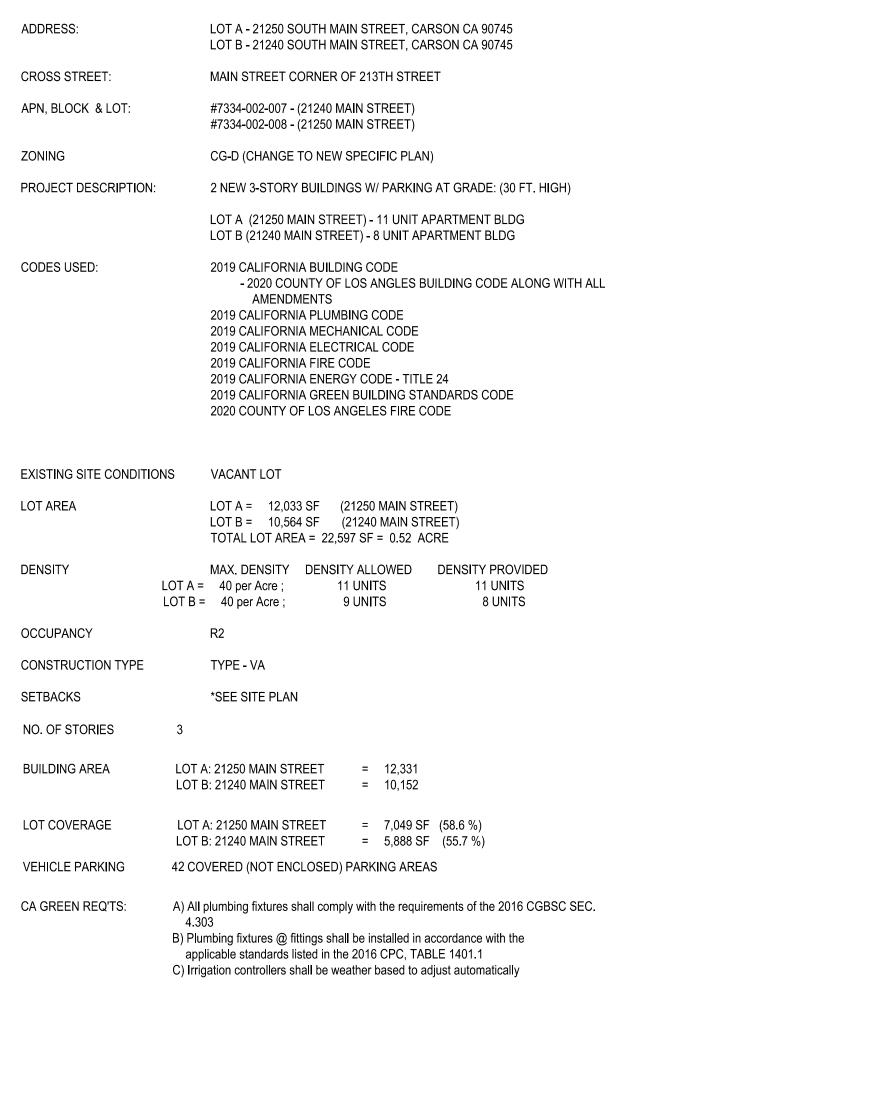



2173 LOMITA BLVD. #201 LOMITA CALIFORNIA 90717

Architect:

ART ASHAI, AIA

2173 LOMITA BLVD. #201 **LOMITA CALIFORNIA 90717** PHONE: 424-263-5888 email: artashai@gmail.com

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STREET

∞ర

21240 MAIN STREE

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NANCY KIM

FIRST FLOOR OVERALL PLAN A-101 A-102 SECOND FLOOR OVERALL PLAN A-103 THIRD FLOOR OVERALL PLAN A-104 **ROOF PLAN** A-111 **BUILDING A - UNIT PLANS**

OPEN SPACE PLAN

ARCHITECTURAL:

TITLE SHEET

SITE PLAN

PROJECT DATA

BUILDING A - UNIT PLANS **BUILDING A - UNIT PLANS BUILDING B - UNIT PLANS** A-122

T-002

A-001

A-003

BUILDING B - UNIT PLANS **BUILDING B - UNIT PLANS** BUILDING B - UNIT PLANS A-201 ELEVATIONS A-201.1 **BLOW-UP ELEVATIONS**

A-202 **ELEVATIONS** A-202.1 RENDERINGS A-301 SECTIONS A-302 SECTIONS

LANDSCAPE:

GROUND FLOOR CONCEPTUAL PLAN SECOND FLOOR CONCEPTUAL PLAN L.1.1 L.2.0 PLANT PALETTE


PROJECT INFORMATION:

Project Title: **CARSON APARTMENTS** 21240 Main Street Carson, CA 90745

21250 Main Street Carson, CA 90745

LEGAL DESCRIPTION

APN: 7334-002-007 APN: 7334-002-008

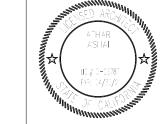

VICINITY MAP

SHEET INDEX

GRADING AND DRAINAGE TITLE SHEET

GRADING AND DRAINAGE PLAN

GRADING AND DRAINAGE SECTION

C-001

3 OF 3


SURVEY

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MECHANICAL:


PLUMBING:

ELECTRICAL:

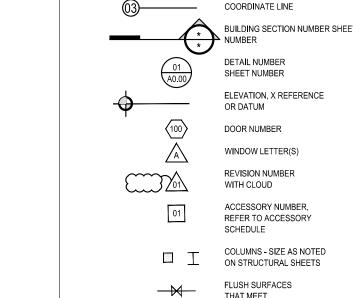



NOT IN CONTRACT BY OTHERS


(N.I.C. HAS TO BE WRITTEN

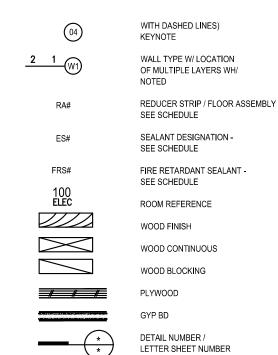

SYMBOLS(PARTIAL LIST)

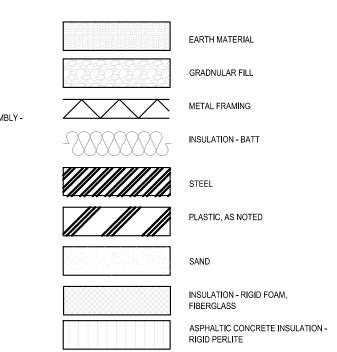

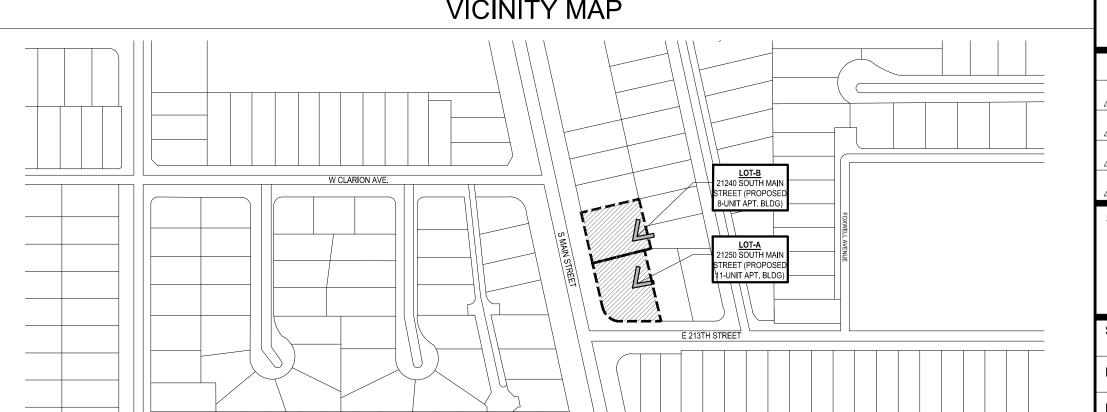

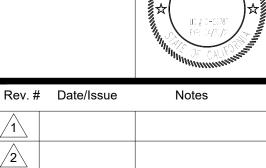

Sheet Title:

TITLE SHEET

AS NOTED J-1908 Date: Aug2021 Sheet Number : Drawn: arkihaus Check'd: CTV/RRJ

RECIPROCAL EASEMENT AGREEMENT (REA)

- A REA for reciprocal access, parking, utilities, and waste disposal shall be recorded against both properties (APN 7334-002-007 and APN 7334-002-007) prior to the issuance of building permits.
- The City of Carson shall review and approve the REA prior to recordation.
- The REA shall take effect immediately upon recordation.
- The City of Carson shall be a named third-party beneficiary of the REA. The REA shall not be amended or terminated without prior written

PROJECT AREAS

BUILDING INFORMATION:

21250 Main Street, Carson CA

Lot Area:

		,	
Max. Den	sity:	40 per Ac.	
Density A	llowed:	11 units	
Density P	roposed:	11 units	
Unit#	Type	Area	Balcony
101	2B + 2Ba	945	85
201	2B + 2Ba	980	74
202	2B + 2Ba	977	66
203	2B + 2Ba	1,037	76
204	2B + 2Ba	1,090	78
205	2B + 2Ba	1,054	88
301	2B + 2Ba	980	74
302	2B + 2Ba	977	66
303	2B + 2Ba	1,037	76
304	2B + 2Ba	1,090	78
305	2B + 2Ba	1,054	88
	TOTAL	11,221	849
Common	1,716		
	0.505		

12,033 sf

Parking required: 2.2 / unit Parking provided:

Common Floor Area 1st Floor = 540 SF 2nd Floor = 420 SF 3rd Floor = 150 SF TOTAL = 1,110 SF

Total open space

Total Bldg. Floor Area_ 11,221 + 1,110 = 12,331 SF

Covered (not enclosed) Parking Area = 5,714 SF

Lot Coverage = 7,049 SF (58.5%)

2,565

21240 Main Street, Carson CA

10,564 sf Lot Area: Max. Density: 40 per Ac. Density Allowed: 9 units Density Proposed: 8 units

Unit#	Type Area	Balcony
101	2B + 2Ba 1,042	92
201	2B + 2Ba 1,081	80
202	2B + 2Ba 1944	69
203	2B + 2Ba 1,031	54
204	2B + 2Ba 1,025	66
301	2B + 2Ba 1,081	80
302	2B + 2Ba 944	69
303	4B + 4Ba 2,061	120

9,209 Common open space 3,308 Total open space

Parking required: 2.2 / unit Parking provided:

Common Floor Area 1st Floor = 539 SF 2nd Floor = 324 SF 3rd Floor = 80 SF TOTAL = 943 SF

Total Bldg. Floor Area

Covered (not enclosed) Parking Area = 4,190 SF

Lot Coverage = 5,888 SF (55.7%)

BUILDING INFORMATION:

LOT AREA =

MAX DENSITY = 40 UNITS / ACRE

DENSITY ALLOWED = 20.8 UNITS (20 UNITS)

DENSITY PROPOSED = 19 UNITS 4,394 SF

TOTAL OPEN SPACE = 5,873 SF (309 SF / UNIT)

24 + 18 = 42 SPACES (INCLUDING 4 H/C)

PROPOSED LOT COVERAGE = 7,049 + 5,888 = 12,937 SF (57.25%)

PROPOSED BUILDING FLOOR AREA = 22,483 SF

PROPOSED FAR =

(MEASURED TO ROOF LVL.)

Jnit#	Type	Area	Balcony
101	2B + 2Ba	1,042	92
201	2B + 2Ba	1,081	80
202	2B + 2Ba	1944	69
203	2B + 2Ba	1,031	54
204	2B + 2Ba	1,025	66
301	2B + 2Ba	1,081	80
302	2B + 2Ba	944	69
303	4B + 4Ba	2,061	120

9,209 + 943 = 10,152 SF

22,597 (0.52 ACRES)

COMMON OPEN SPACE = PRIVATE OPEN SPACE = 1,479 SF

PARKING REQUIRED = 19 x 2.2 = 41.8 = 42 SPACES

PARKING PROPOSED =

1.0 PROPOSED BLDG. HT. = 39 FT.



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& 21250 MAIN STREET

21240 MAIN STREET

NANCY KIM


Architect:

LOMITA CALIFORNIA 90717

Project Title: CARSON APARTMENTS 21240 Main Street Carson, CA 90745

21250 Main Street Carson, CA 90745

LEGAL DESCRIPTION APN: 7334-002-007

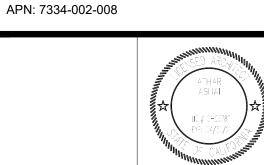


Rev.#	Date/Issue	Notes	
1			
2			
3			
4			

PROJ. AREAS AND SUMMARY

Check'd: CTV/RRJ

Job Number : J-1908 AS NOTED Date: Aug2021 Sheet Number: Drawn: arkihaus

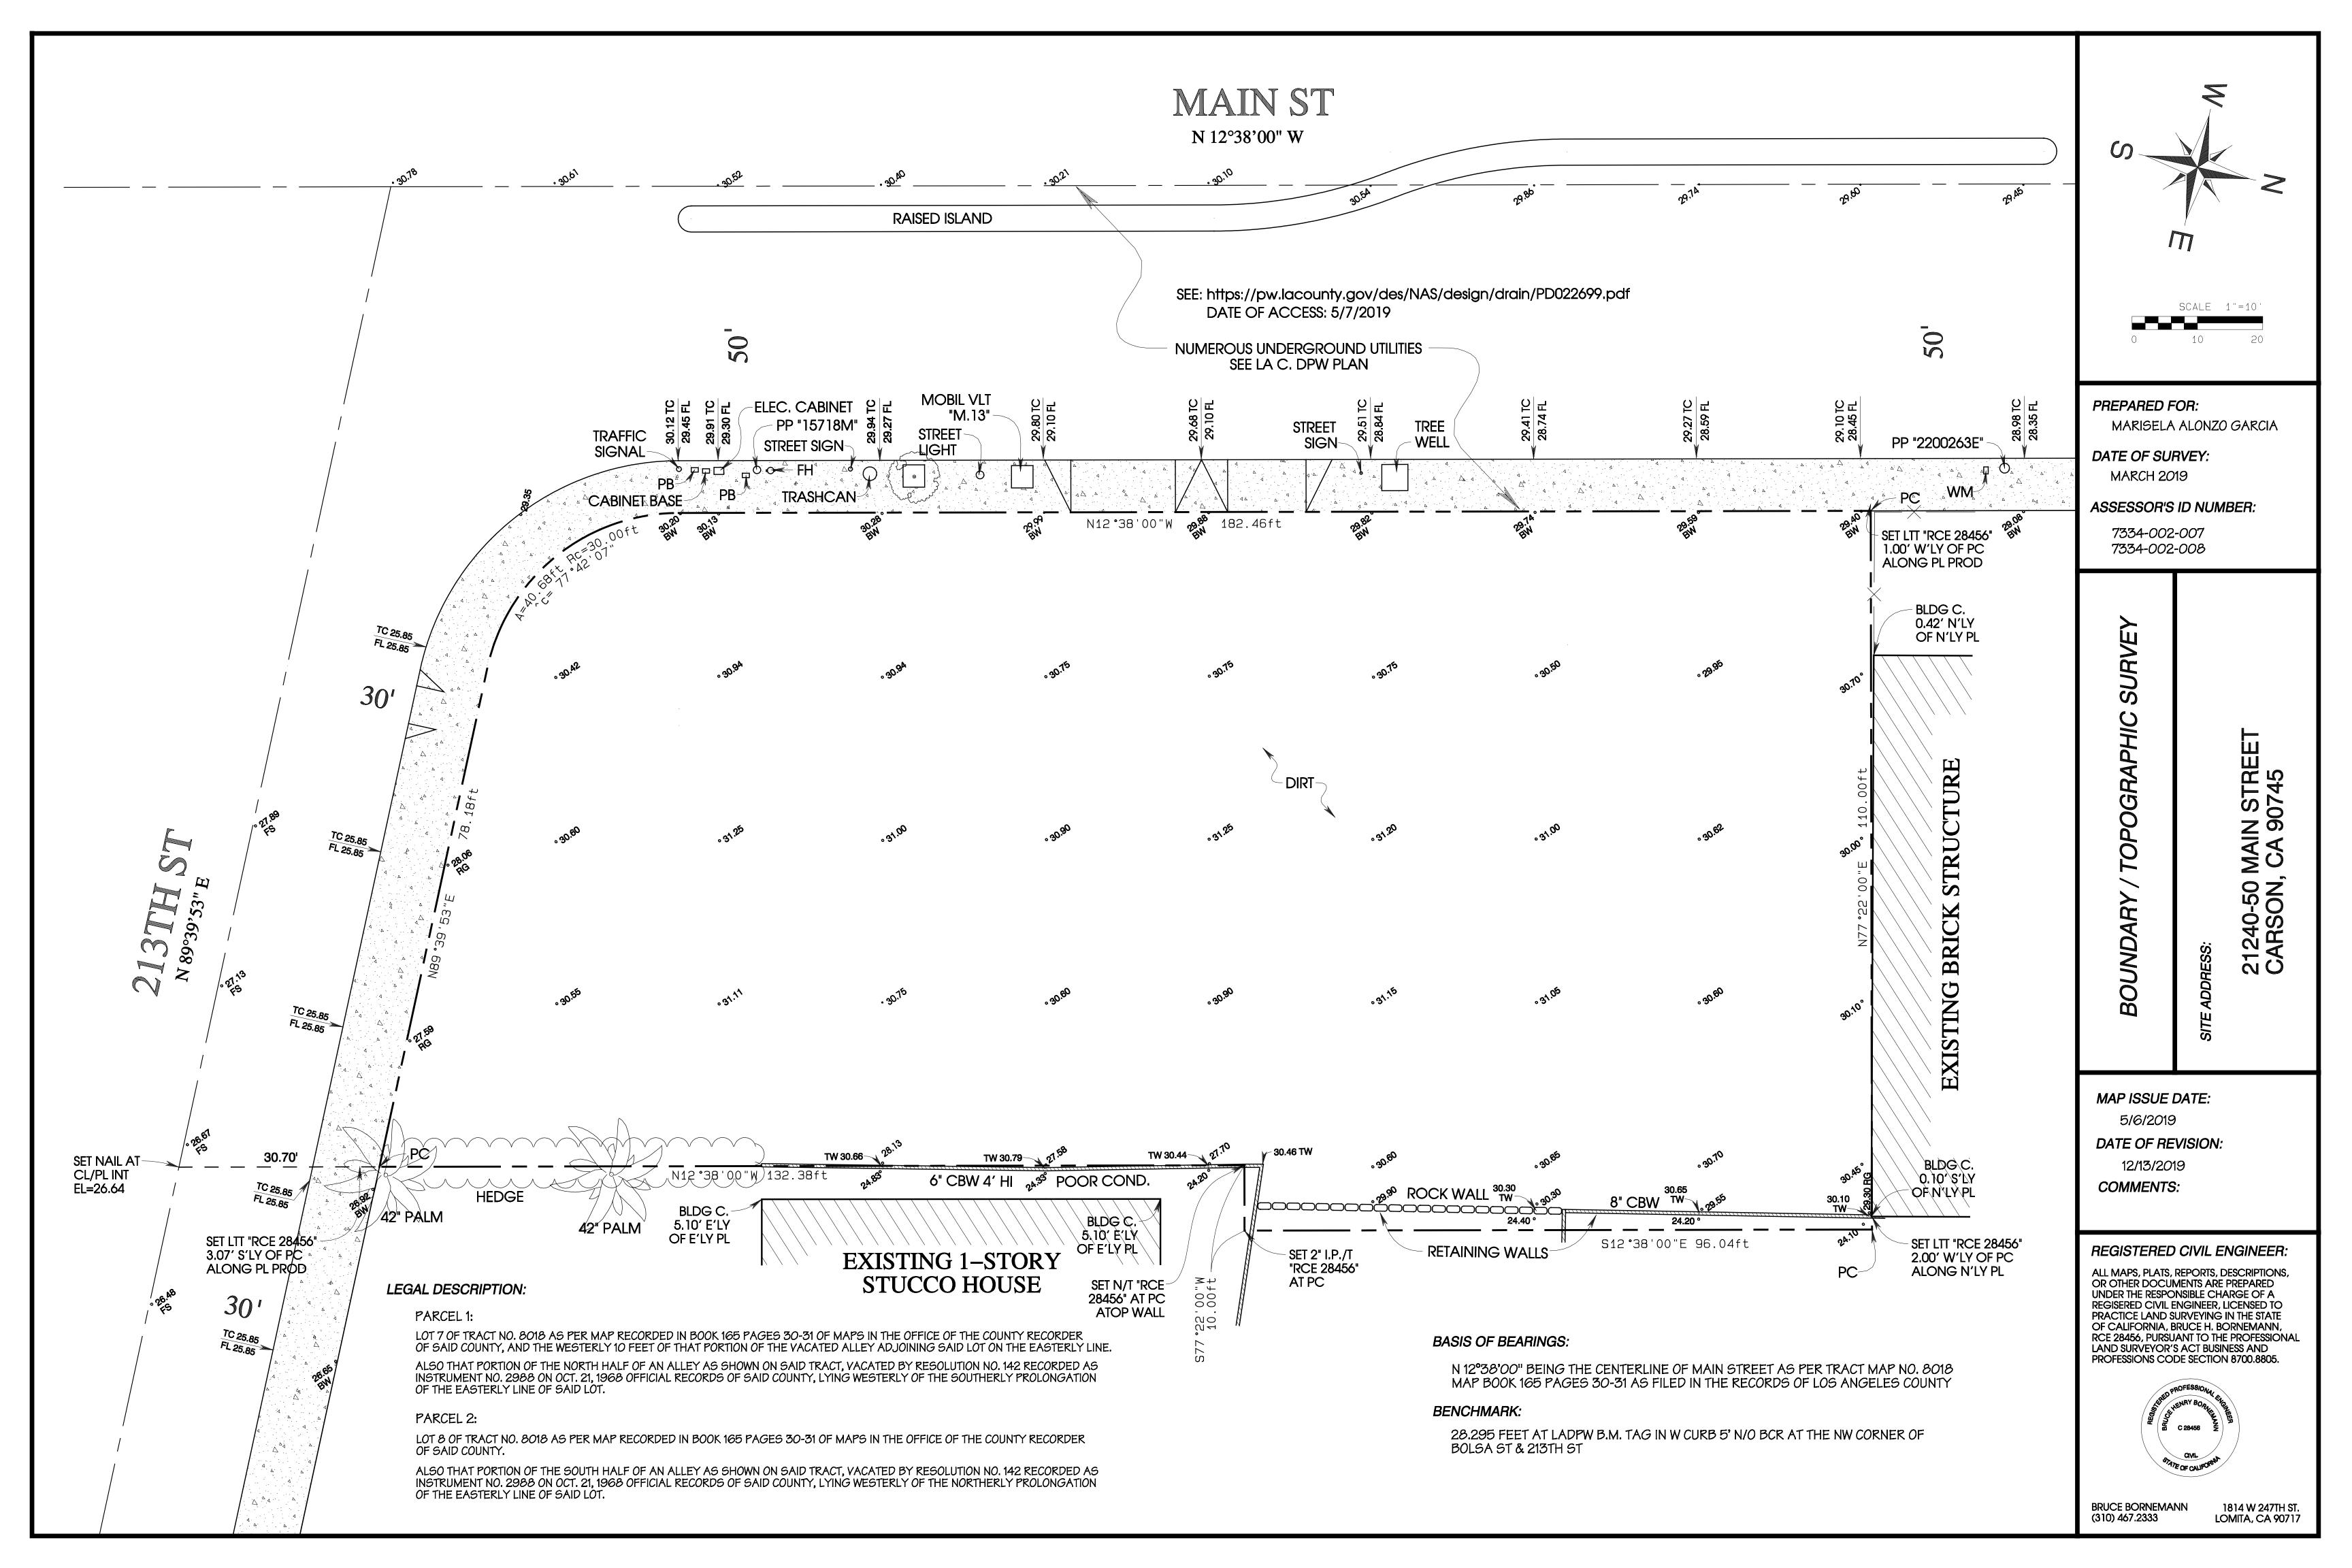

PROJECT INFORMATION:

WATER PURVEYOR: CALIFORNIA WATER SERVICE COMPANY TOTAL LANDSCAPE AREA: 3164 SQUARE FEET

PARCEL INFORMATION: 21240 MAIN STREET & 21250 MAIN STREET CARSON, CA 90745

A.P.N. 7334-002-007 A.P.N. 7334-002-008

GENERAL NOTES:

1. OWNER TO MAINTAIN LANDSCAPE AND IRRIGATION SYSTEM

2. STREET TREES WITHIN THE PUBLIC RIGHT-OF-WAY ARE TO BE PLANTED PER APPROVED STREET IMPROVEMENT PLANS.

3. ALL HARDSCAPES, RETAINING WALLS, SWIMMING POOLS, AND/OR BLOCK WALLS MUST BE REVIEWED AND APPROVED UNDER A SEPARATE PERMIT.

4. ALL PLANTS ARE IN COMPLIANCE WITH MODEL WATER EFFICIENT LANDSCAPE ORDINANCE (MWELO).

5. CONTRACTOR TO PROTECT AND PRESERVE IN PLACE ALL EXISTING SURVEY MONUMENTS. ANY MONUMENT DISTURBED SHALL BE RESET BY A LICENSED LAND SURVEYOR AND THE APPROPRIATE CORNER RECORD MUST BE FILED WITH THE COUNTY OF LOS ANGELES.

6. TREE CANOPIES ARE SHOWN AT FULL MATURITY.

7. AUDIT SHALL BE IN ACCORDANCE WITH THE LATEST STATE OF CALIFORNIA LANDSCAPE WATER MANAGEMENT PROGRAM AS DESCRIBED IN THE LATEST LANDSCAPE IRRIGATION AUDITOR HANDBOOK. THE LANDSCAPE IRRIGATION AUDITS TO BE CONDUCTED BY A QUALIFIED INDIVIDUAL AND THE AUDIT SCHEDULE SHALL BE CONDUCTED AT LEAST ONCE EVERY FIVE YEARS IN ACCORDANCE WITH THE REQUIREMENTS OF TITLE 20, DIVISION 1 OF THE LOS ANGELES COUNTY CODE.

8. TOTAL PROPOSED LANDSCAPE AREA: 3164 S.F.

9. TOTAL TURF AREA = 0 S.F. IS 0% OF TOTAL LANDSCAPE AREA.

10. TOTAL DROUGHT TOLERANT LANDSCAPING AREA = 3164 S.F. IS 100% OF THE TOTAL PROPOSED LANDSCAPE AREA.

11. HYDROZONING IRRIGATION TECHNIQUES SHALL BE INCORPORATED INTO THE LANDSCAPE DESIGN.

12. THIS PROJECT REQUIRES A LANDSCAPE PERMIT. PRIOR TO FINAL, CERTIFICATION FROM A LICENSED LANDSCAPE ARCHITECT SHALL BE PROVIDED TO THE BUILDING OFFICIAL. FINAL CERTIFICATION CAN BE OBTAINED AT THE FOLLOWING: http://dpw.lacounty.gov/bsd/publications/index.cfm

SHEET INDEX


L.0 TITLE SHEET

L.1.0 CONCEPTUAL PLAN - GROUND FLOOR
L.1.1 CONCEPTUAL PLAN - SECOND FLOOR


L.1.1 CONCEPTUAL PL
L.2 PLANT PALETTE

Site Information	20 - 22 - 23 - 24 - 2							
			AIN ST. CARSON, C					
	Site Type →	Residential	Allowed ETAF:	0.55				
Annual	Eto (inches/yr) →	42.6						
Hydrozone or Planting Description	Plant Fac	tor (PF)	Irrigation Method	Irrigation Efficiency (IE)	ETAF (PF/IE)	Hydrozone Area (sqft.)	ETAF x Area	Estimated Total Water Use (gal./yr.)
Regular Landscap	e Areas							
1	0.3	Low	Bubbler	0.81	0.4	22	8	21:
2	0.3	Low	Bubbler	0.81	0.4	22	8	21:
3	0.3	Low	Drip	0.81	0.4	158	59	1,558
4	0.3	Low	Drip	0.81	0.4	478	177	4,675
5	0.3	Low	Bubbler	0.81	0.4	13	5	13:
6	0.3	Low	Drip	0.81	0.4	941	349	9,21
B1	0.3	Low	Bubbler	0.81	0.4	51	19	502
B2	0.3	Low	Drip	0.81	0.4	451	167	4,41
B3	0.3	Low	Bubbler	0.81	0.4	19	7	18
B4	0.3	Low	Drip	0.81	0.4	128	47	1,24
B5	0.3	Low	Drip	0.81	0.4	944	350	9,24
Special Landscape	Areas				SUBTOTAL →	3,227	1,196	31,589
special cariascape	- Fileds				1		0	
					1		0	
		-			1		0	
					1		0	
					SUBTOTAL →	0	0	0
							r Use (ETWU) →	31,589
							ance (MAWA) →	46,877
ETAF Calculations Regular Landscap		6	1,196 3,227		Notes:		Efficient Worksheet	
	Average ETAF		0.37				California Code of le 23, Division 2,	
All Landscape Are	as Total ETAF x Area	v.	1,196			Chapter 2.7.	Model Water	
	Total Area		3,227			Efficient Lands	cape Ordinance	
	Sitewide ETAF		0.37					

SITE WATER USE CALCULATIONS

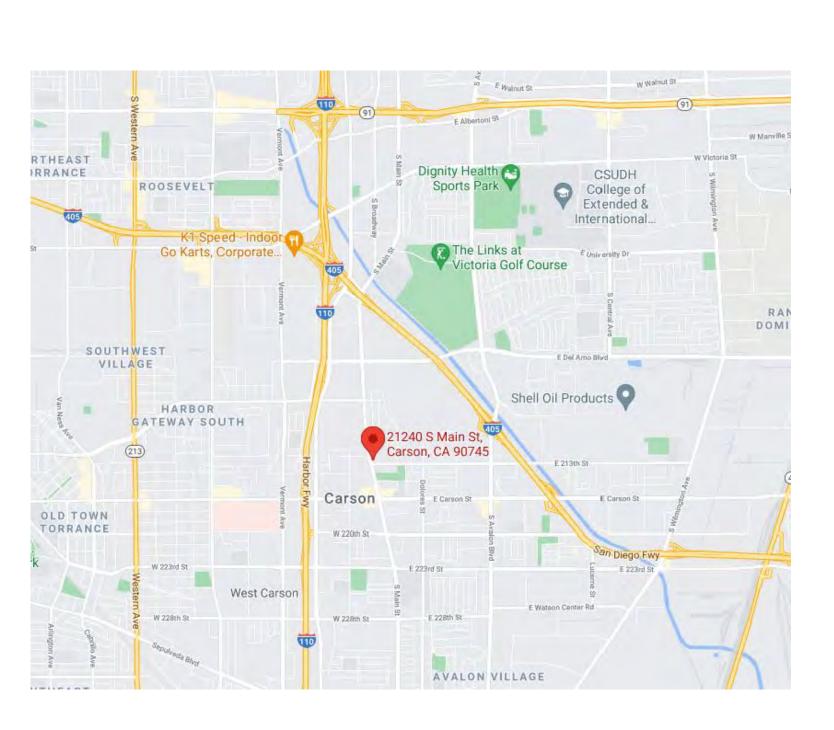


VICINITY MAP

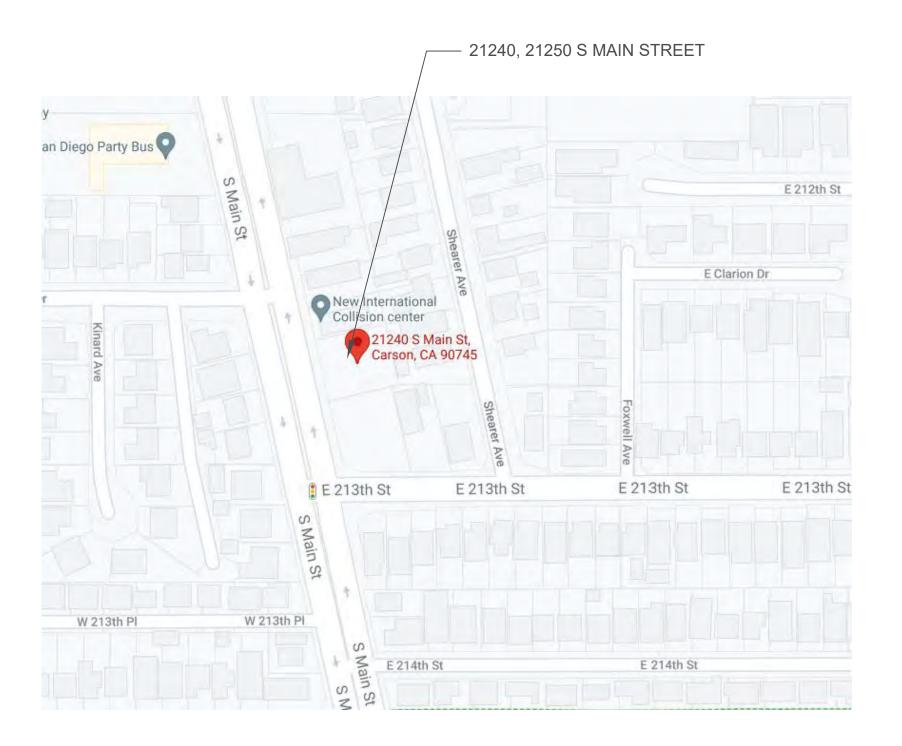

KEY MAP

CARSON LOFTS APARTMENTS 21240 MAIN STREET & 21250 MAIN STREET CARSON, CA 90745

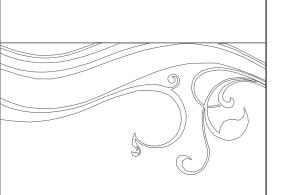

VIRIDITAS DESIGN

Landscape Architecture

Anne Jones RLA CA 5999 viriditasdesigngroup@gmail.com 2735 W. Avenue 33 Los Angeles, CA 323.377.1018







ARCHITECT:
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REVISIONS

DATE:

MAY 27, 2021

SCALE:


1/8" = 1'-0"

TITLE SHEET

L.0


PLANT LEGEND

	BOTANICAL NAME	COMMON NAME	SIZE AT 5 YRS.	PLANT TYPE	WUCOLS RATING						
* * * * * * * * * * * * * * * * * * *	ACHILLEA MILLEFOLIUM	COMMON YARROW	6" X 1'	GROUND COVER	0.3/L		RAPHIOLEPIS INDICA 'CLARA'	INDIAN HAWTHORN	4' X 4'	SHRUB	0.3/L
X	AGAVE ATTENUATA	FOXTAIL AGAVE	2' X 2'	SUCCULENT	0.3/L	•	WESTRINGIA 'BLUE GEM'	BLUE GEM COAST ROSEMARY	6' X 3'	SHRUB	0.3/L
	ALOE STRIATA	CORAL ALOE	2' X 18"	SUCCULENT	0.3/L		WESTRINGIA FRUTICOSA 'GREY BOX'	DWARF COAST ROSEMARY	3' X 3'	SHRUB	0.3/L
	CAREX DIVULSA (TUMULICOLA)	BERKELEY SEDGE	18" X 2'	GRASS LIKE	0.3/L		WESTRINGIA FRUTICOSA 'MUNDII'	MUNDI COAST ROSEMARY	18" X 3'	SHRUB	0.3/L
	GREVILLEA LANIGERA 'COASTAL GEM'	COASTAL GEM	1' X 3'	SHRUB	0.3/L		TREES				
	LANTANA 'NEW GOLD'	NEW GOLD LANTANA	3' X 3'	SHRUB	0.3/L		ARBUTUS MARINA - STANDARD FORM	STRAWBERRY TREE	15' X 12'	TREE	0.3/L
	LAURUS NOBILIS (SHRUB FORM)	SWEET BAY	8' X 4'	SHRUB	0.3/L		GEIJERA PARVIFLORA	AUSTRALIAN WILLOW	14' X 12'	TREE	0.3/L
	LOMANDRA 'NYALLA'	NYALLA MAT RUSH	3' X 3'	GRASS LIKE	0.3/L		PROPOSED PARKWAY TREE	N/A	N/A	TREE	N/A

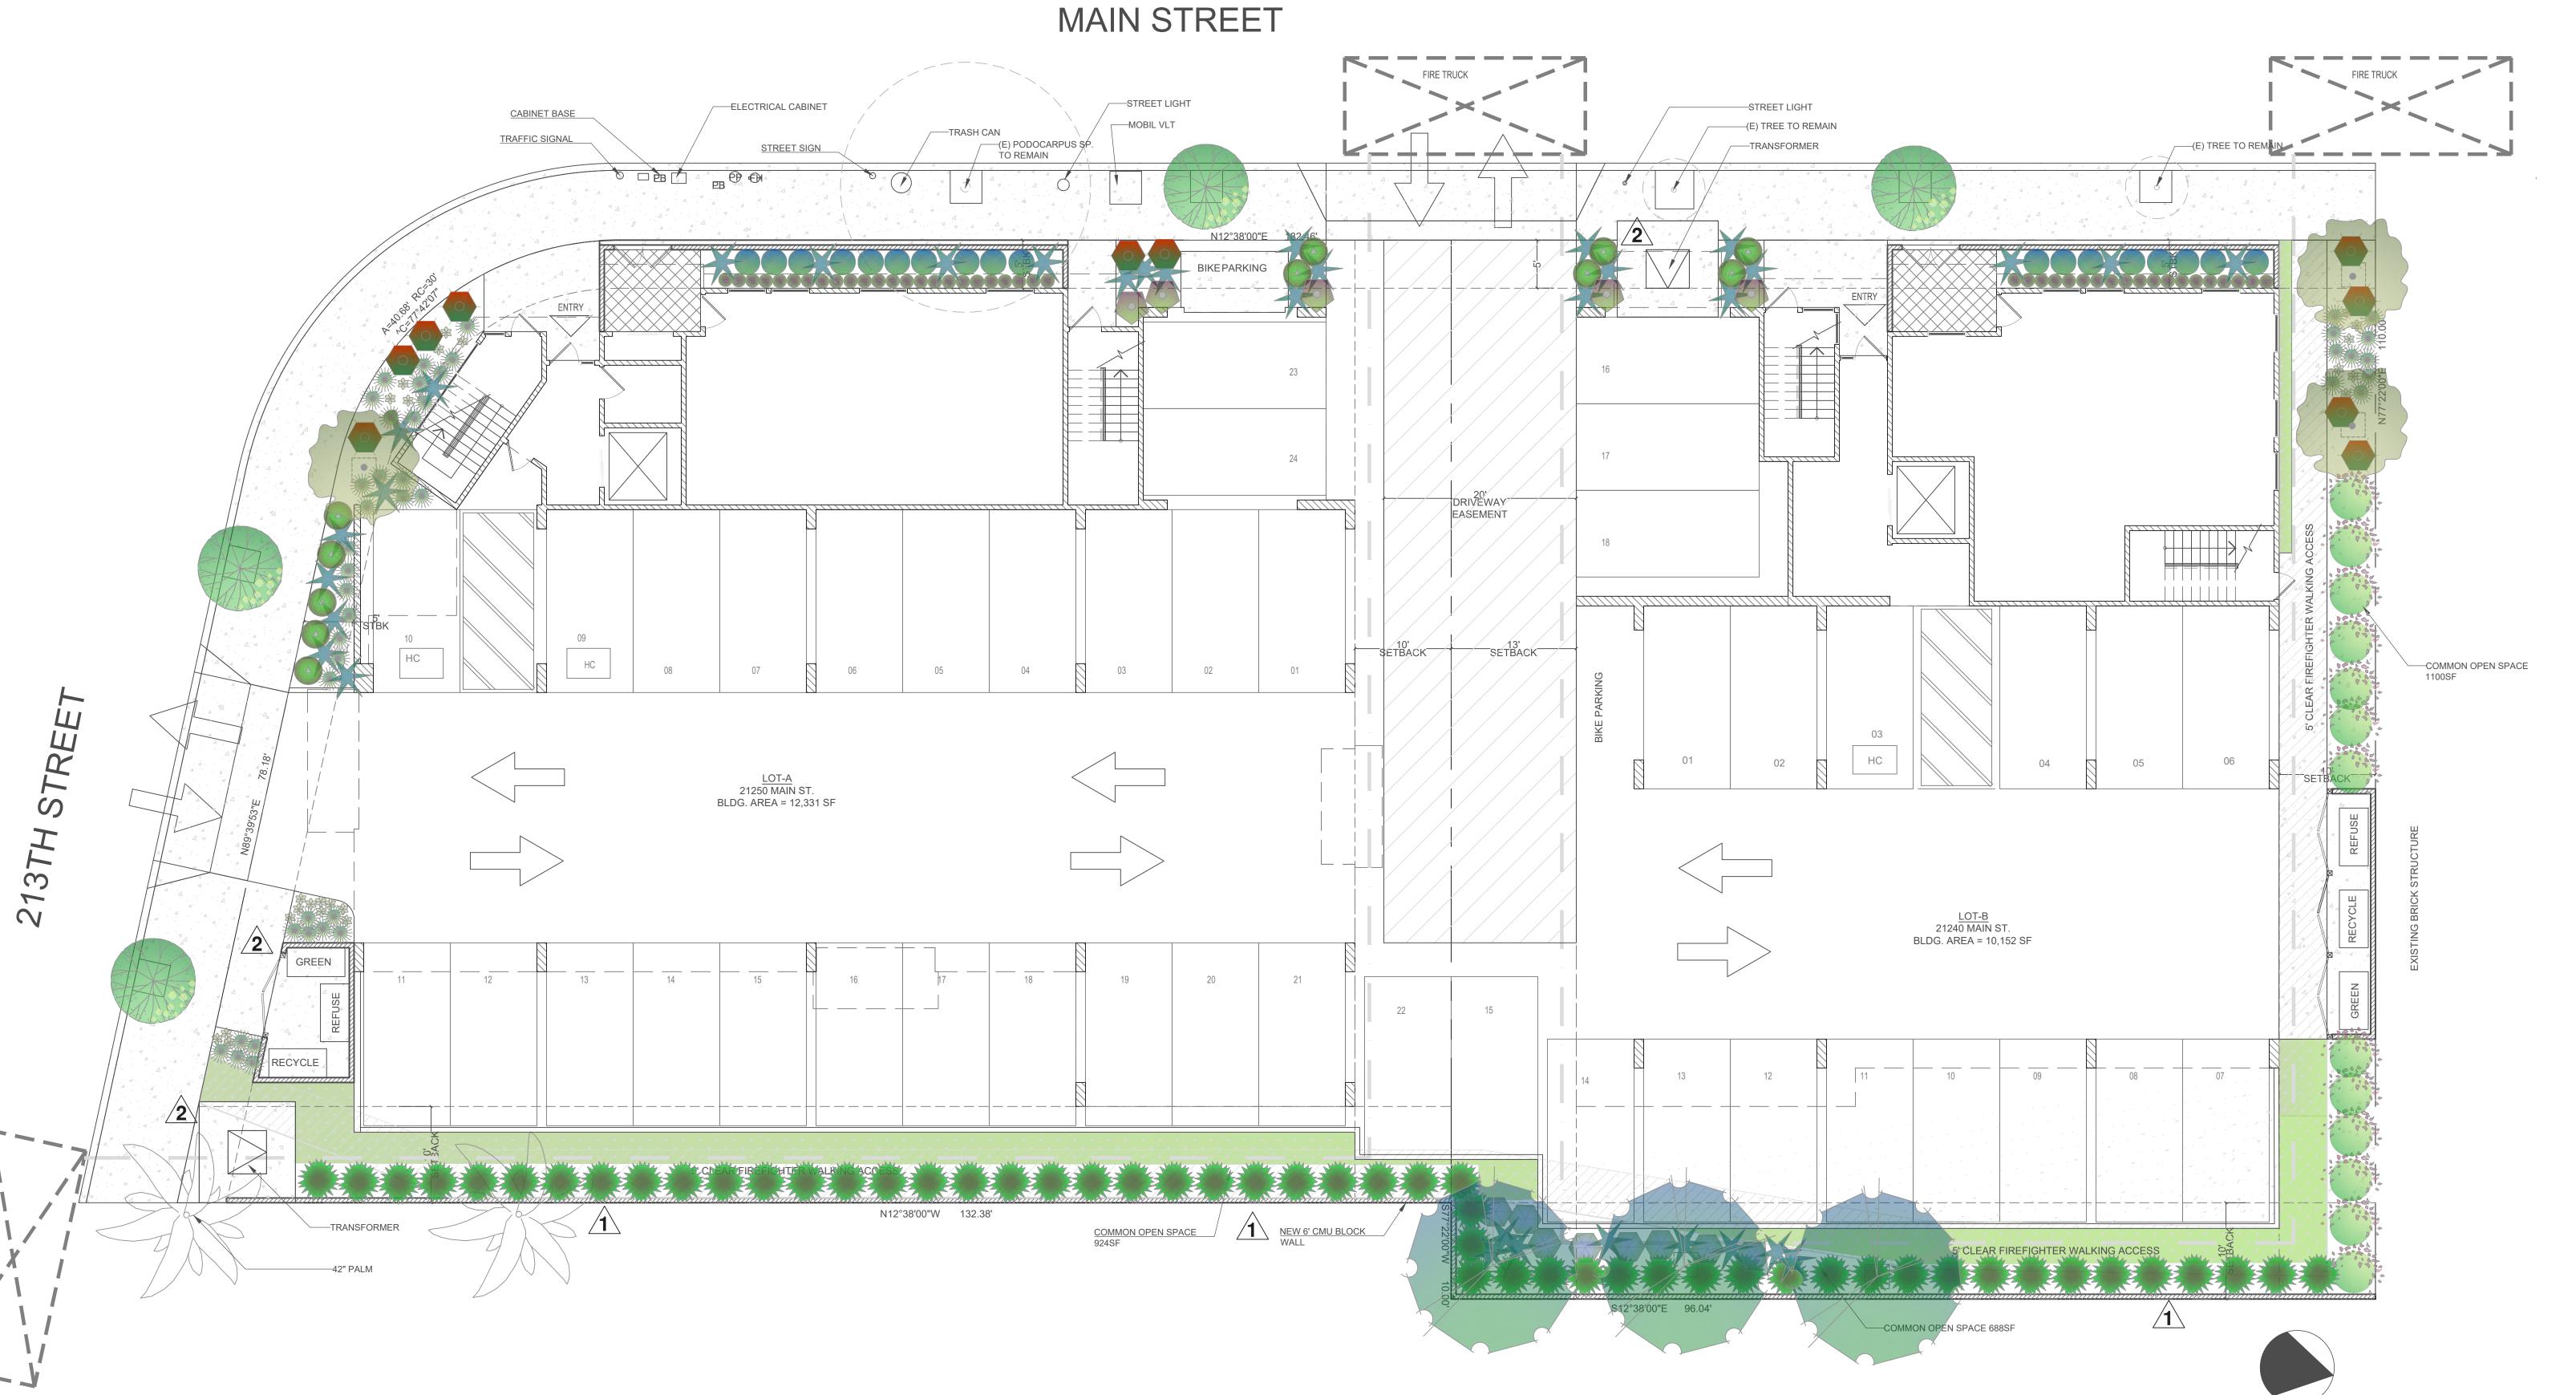

CONCEPTUAL LANDSCAPE PLAN - GROUND FLOOR SCALE: 1/8" = 1'-0"

CARSON LOFTS APARTMENTS 21240 MAIN STREET & 21250 MAIN STREET CARSON, CA 90745

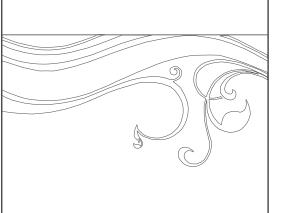


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REVISIONS
AUGUST 13, 202

AUGUST 13, 2021

OCTOBER 15, 2021

DATE:

MAY 27, 2021

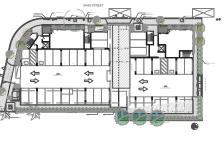SCALE:

1/8" = 1'-0"

CONCEPTUAL PLAN GROUND FLOOR


L.1.0

PLANT LEGEND

	BOTANICAL NAME	COMMON NAME	SIZE AT 5 YRS.	PLANT TYPE	WUCOLS RATING
	ECHEVERIA 'VIOLET QUEEN'	VIOLET QUEEN 'HENS AND CHICKS'	6" X 6"	SUCCULENT	0.3/L
	ECHEVERIA 'ZORRO'	ZORRO ECHEVERIA	18" X 1'	SUCCULENT	0.3/L
	HARDENBERGIA VIOLACEA TRELLISED	PURPLE VINE LILAC	6' X 3'	VINE	0.3/L
	KALANCHOE 'OAK LEAF'	DWARF VELVET PLANT	2' X 2'	SUCCULENT	0.3/L
*	PORTULACARIA AFRA MINIMA	ELEPHANT'S FOOD	>1' X 3'	SUCCULENT	0.3/L
	RUSELLIA EQUISETIFORMIS	CORAL FOUNTAIN	3' X 3'	PERENNIAL	0.3/L
	TRADESCANTIA 'GREENLEE'	PALE PUMA SPIDERWORT	<1' X 4'	SUCCULENT	0.3/L
	XEROSICYOS DANGUYI	SILVER DOLLAR VINE	<1' X 4'	SUCCULENT	0.3/L



CARSON LOFTS APARTMENTS 21240 MAIN STREET & 21250 MAIN STREET CARSON, CA 90745

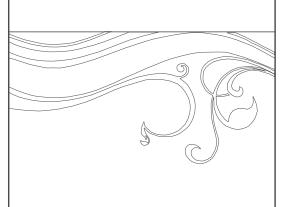


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REVISIONS

DATE:

MAY 27, 2021 SCALE:

1/8" = 1'-0"


CONCEPTUAL PLAN SECOND FLOOR

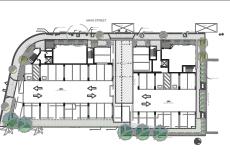_.1.1

CONCEPTUAL LANDSCAPE PLAN -SECOND FLOOR SCALE: 1/8" = 1'-0"

GEIJERA PARVIFLORA AUSTRALIAN WILLOW

XEROSICYOS DANGUYI SILVER DOLLAR VINE ARBUTUS UNEDO STD. STRAWBERRY TREE CARSON LOFTS APARTMENTS 21240 MAIN STREET & 21250 MAIN STREET CARSON, CA 90745

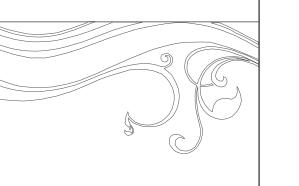

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REVISIONS

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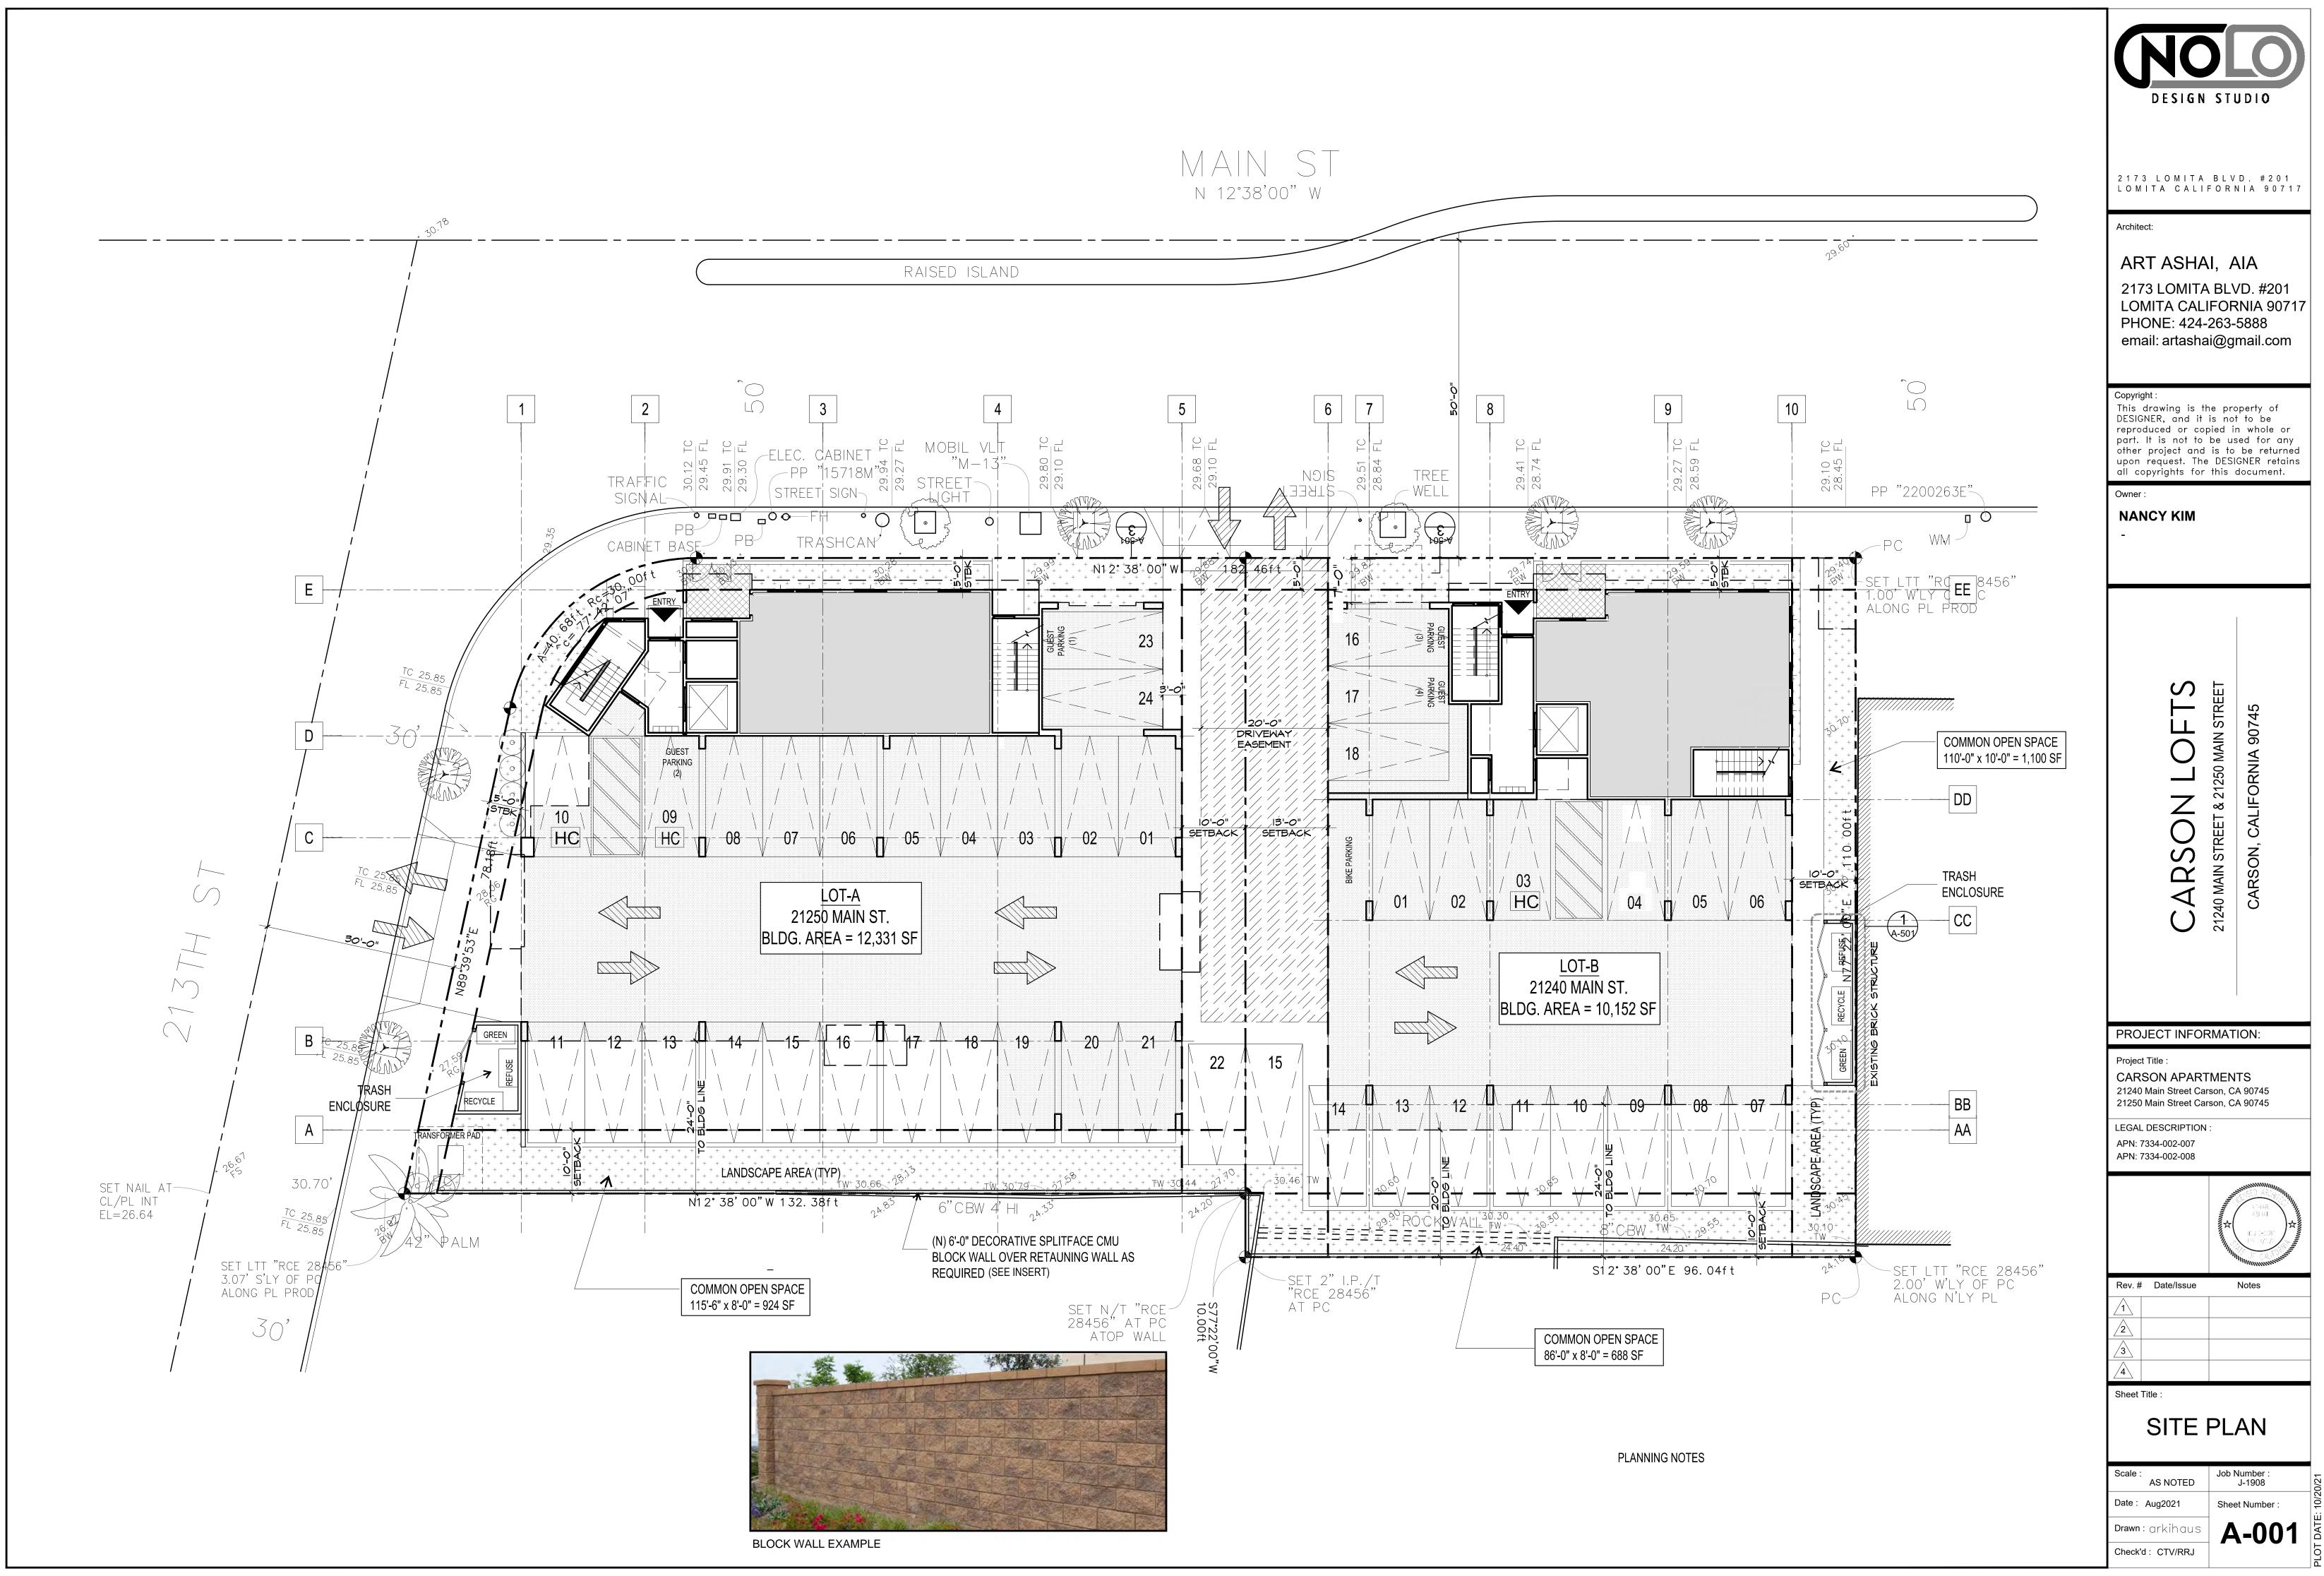
MAY 27, 2021

SCALE:

N.T.S.


PLANT PALETTE

1 2







UNIT WIDTH DEPTH AREA UNIT WIDTH DEPTH AREA 101 10'-0" 9'-0" 90 S.F. 101 10'-10" 9'-0" 98 S.F. 201 10'-6" 7'-0" 74 S.F. 201 11'-6" 7'-0" 81 S.F. 202 11'-2" 6'-4" 71 S.F. 202 10'-6" 7'-0" 74 S.F. 203 12'-0" 6'-4" 76 S.F. 203 12'-0" 4'-6" 54 S.F. 204 12'-4" 6'-4" 78 S.F. 204 11'-2" 6'-4" 71 S.F. 205 14'-10" 6'-4" 94 S.F. 301 11'-6" 7'-0" 81 S.F. 301 10'-10" 7'-0" 76 S.F. 302 9'-10" 7'-0" 69 S.F. 302 11'-2" 6'-4" 71 S.F. 303 12'-0" 4'-6" 54 S.F. 303 12'-0" 6'-4" 76 S.F. 303 11'-2" 6'-4" 71 S.F. </th <th>242501</th> <th>AAINI CTREET</th> <th>(LOTA) OB</th> <th>N CDACE</th> <th>242404</th> <th>ALL CTREET</th> <th>LOTEN OR</th> <th>ENLODACE</th>	242501	AAINI CTREET	(LOTA) OB	N CDACE	242404	ALL CTREET	LOTEN OR	ENLODACE
UNIT WIDTH DEPTH AREA 101 10'-0" 9'-0" 90 S.F. 101 10'-10" 9'-0" 98 S.F. 201 10'-6" 7'-0" 74 S.F. 201 11'-6" 7'-0" 81 S.F. 202 11'-2" 6'-4" 71 S.F. 202 10'-6" 7'-0" 74 S.F. 203 12'-0" 6'-4" 76 S.F. 203 12'-0" 4'-6" 54 S.F. 204 12'-4" 6'-4" 78 S.F. 204 11'-2" 6'-4" 71 S.F. 205 14'-10" 6'-4" 94 S.F. 301 11'-6" 7'-0" 81 S.F. 301 10'-10" 7'-0" 76 S.F. 302 9'-10" 7'-0" 69 S.F. 302 11'-2" 6'-4" 71 S.F. 303 12'-0" 4'-6" 54 S.F. 303 12'-0" 6'-4" 77 S.F. 302 9'-10" 7'-0" 69 S.F. 304 12'-4" 6'-4" 78 S.F. 303 12'-0" 4'-6" 54 S.F. 305 14'-2" 6'-4" 78 S.F. 303 12'-0" 4'-6" 54 S.F. 306 12'-4" 6'-4" 78 S.F. 303 12'-0" 4'-6" 54 S.F. 307 12'-0" 6'-4" 78 S.F. 303 12'-0" 4'-6" 54 S.F. 308 12'-0" 6'-4" 78 S.F. TOTAL PRIVATE OPEN SPACE 653 S.F. 309 12'-2" 6'-4" 90 S.F. USEABLE 42'-6" 21'-0" 893 S.F. 300 12'-2" 6'-4" 90 S.F. USEABLE 42'-6" 21'-0" 893 S.F. 301 10'-10" 792 S.F. TOTAL 2,590 S.F. TOTAL 2,590 S.F. TOTAL 2,590 S.F. 302 11'-2" 6'-4" 90 S.F. USEABLE 42'-6" 21'-0" 893 S.F. 303 12'-0" 893 S.F. TOTAL 2,590 S.F. USEABLE 4,500 PRIVATE 98 S.F. COMMON 1,788 S.F. 21250 MAIN STREET - LOT A 21240 MAIN STREET - LOT B SUMMARY OF OPEN SPACES	21250 IV			EN SPACE	21240 MAIN STREET (LOT B) - OPEN SPACE			
101	LINUT			ADEA	LINIT			ADEA
201 10'-6" 7'-0" 74 S.F. 201 11'-6" 7'-0" 81 S.F. 202 11'-2" 6'-4" 71 S.F. 202 10'-6" 7'-0" 74 S.F. 203 12'-0" 6'-4" 76 S.F. 203 12'-0" 4'-6" 54 S.F. 204 12'-4" 6'-4" 78 S.F. 204 11'-2" 6'-4" 71 S.F. 205 14'-10" 6'-4" 94 S.F. 301 11'-6" 7'-0" 81 S.F. 301 10'-10" 7'-0" 76 S.F. 302 9'-10" 7'-0" 69 S.F. 302 11'-2" 6'-4" 71 S.F. 303 12'-0" 4'-6" 54 S.F. 304 12'-4" 6'-4" 78 S.F. TOTAL PRIVATE OPEN SPACE 653 S.F. 305 14'-2" 6'-4" 79 S.F. USEABLE 42'-6" 21'-0" 893 S.F. TOTAL PRIVATE OPEN SPACE 53 S.F. 305 14'-2" 6'-4" 792 S.F. 305 14'-2" 6'-4" 792 S.F. 305 34 S.F. 305 35 S.F. 305 3			 					
202								+
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204								
205			+					
301 10'-10" 7'-0" 76 S.F. 302 9'-10" 7'-0" 69 S.F. 302 11'-2" 6'-4" 71 S.F. 303 12'-0" 4'-6" 54 S.F. 303 12'-0" 6'-4" 76 S.F. 303 11'-2" 6'-4" 71 S.F. 304 12'-4" 6'-4" 78 S.F. TOTAL PRIVATE OPEN SPACE 653 S.f. 305 14'-2" 6'-4" 90 S.F. USEABLE 42'-6" 21'-0" 893 S.F. TOTAL PRIVATE OPEN SPACE 874 S.F. COMMON 1,788 S.F. TOTAL PRIVATE OPEN SPACE 874 S.F. COMMON 1,788 S.F. TOTAL 2,590 S.F. TOTAL 3,334 S.F. TOTAL 2,590 S.F. TOTAL 3,334 S.F. TOTAL 2,590 S.F. TOTAL 3,334 S.F. TOTAL 3,334 S.F. TOTAL 15T PRIVATE 98 S.F. COMMON 924 S.F. COMMON 1,788 S.F. TOMMON 924 S.F. COMMON 1,788 S.F. COMMON 924 S.F. COMMON 1,788 S.F. TOTAL 15T PRIVATE 90 S.F. 15T PRIVATE 98 S.F. COMMON 924 S.F. COMMON 1,788 S.F. COMMON 924 S.F. COMMON 1,788 S.F. TOTAL 15T PRIVATE 98 S.F. COMMON 1,788 S.F. COMMON 924 S.F. COMMON 1,788 S.F. COMMON 924 S.F. USEABLE 893 S.F. USEABLE 792 S.F. USEABLE 893 S.F. TOTAL 2 ^{MD} PRIVATE 280 S.F. 380 PRIVATE 391 S.F. 380 PRIVATE 275 S.F. TOTAL 3 RD PRIVATE 275 S.F. TOTAL 3 RD PRIVATE 275 S.F.								-
302			<u> </u>					+
303			+					-
304 12'-4" 6'-4" 78 S.F. TOTAL PRIVATE OPEN SPACE 653 s.f. 305	302	11'-2"		71 S.F.	303	12'-0"	4'-6"	54 S.F.
305	303	12'-0"	6'-4"	76 S.F.	303	11'-2"	6′-4″	71 S.F.
1,788 S.F. 1,7	304	12'-4"	6'-4"	78 S.F.	TOTAL PRIV	ATE OPEN SP	ACE	653 s.f.
SEABLE	305	14'-2"	6'-4"	90 S.F.	USEABLE	42'-6"	21'-0"	893 S.F.
P24 S.F. TOTAL 2,590 S.F. TOTAL 3,334 S.F.	TOTAL PRIV	ATE OPEN SP	ACE	874 S.F.	COMMON			1,788 S.F.
TOTAL 2,590 S.F. TOTAL 3,334 S.F. 21250 MAIN STREET − LOT A 21240 MAIN STREET − LOT B SUMMARY OF OPEN SPACES SUMMARY OF OPEN SPACES FLOOR SPACE AREA 1 ST PRIVATE 90 S.F. 1 ST PRIVATE 98 S.F. COMMON 924 S.F. COMMON 1,788 S.F. 2 ND PRIVATE 393 S.F. 2 ND PRIVATE 280 S.F. 2 ND PRIVATE 393 S.F. USEABLE 893 S.F. 3 RD PRIVATE 391 S.F. 3 RD PRIVATE 275 S.F. 3 RD PRIVATE 391 S.F. TOTAL 3 RD FLOOR: 666 S.F.	USEABLE	49'-6"	16′-0″	792 S.F.				
21250 MAIN STREET - LOT A 21240 MAIN STREET - LOT B SUMMARY OF OPEN SPACES SUMMARY OF OPEN SPACES FLOOR	COMMON			924 S.F.				
SUMMARY OF OPEN SPACES FLOOR SPACE AREA FLOOR SPACE AREA 1 ST PRIVATE 90 S.F. 1 ST PRIVATE 98 S.F. COMMON 924 S.F. COMMON 1,788 S.F. 2 ND PRIVATE 393 S.F. 2 ND PRIVATE 280 S.F. USEABLE 792 S.F. USEABLE 893 S.F. 3 RD PRIVATE 275 S.F. 3 RD PRIVATE 275 S.F. TOTAL 3 RD FLOOR: 666 S.F.			TOTAL	2,590 S.F.			TOTAL	3,334 S.F.
FLOOR SPACE AREA FLOOR SPACE AREA 1ST PRIVATE 90 S.F. 1ST PRIVATE 98 S.F. COMMON 924 S.F. COMMON 1,788 S.F. TOTAL 1ST FLOOR: 2,900 S.F. 2ND PRIVATE 393 S.F. 2ND PRIVATE 280 S.F. USEABLE 792 S.F. USEABLE 893 S.F. 3RD PRIVATE 275 S.F. TOTAL 3RD FLOOR: 666 S.F.								
1ST PRIVATE 90 S.F. 1ST PRIVATE 98 S.F. COMMON 924 S.F. COMMON 1,788 S.F. TOTAL 1ST FLOOR: 2,900 S.F. 2ND PRIVATE 393 S.F. 2ND PRIVATE 280 S.F. USEABLE 792 S.F. USEABLE 893 S.F. TOTAL 2ND FLOOR: 2,358 S.F. 3RD PRIVATE 275 S.F. TOTAL 3RD FLOOR: 666 S.F.		<u> </u>						
COMMON 924 S.F. COMMON 1,788 S.F. TOTAL 1 ST FLOOR: 2,900 S.F. 2 ND PRIVATE 393 S.F. 2 ND PRIVATE 280 S.F. USEABLE 792 S.F. USEABLE 893 S.F. 3 RD PRIVATE 2,358 S.F. 3 RD PRIVATE 275 S.F. TOTAL 3 RD FLOOR: 666 S.F.								
TOTAL 1 ST FLOOR: 2,900 S.F. 2 ND PRIVATE 393 S.F. 2 ND PRIVATE 280 S.F. USEABLE 792 S.F. USEABLE 893 S.F. TOTAL 2 ND FLOOR: 2,358 S.F. 3 RD PRIVATE 275 S.F. TOTAL 3 RD FLOOR: 666 S.F.	T.,				T ₂ ,			
2 ND PRIVATE 393 S.F. 2 ND PRIVATE 280 S.F. USEABLE 792 S.F. USEABLE 893 S.F. TOTAL 2 ND FLOOR: 2,358 S.F. 3 RD PRIVATE 391 S.F. 3 RD PRIVATE 275 S.F. TOTAL 3 RD FLOOR: 666 S.F.		COM	MON	924 S.F.	<u> </u>			-
USEABLE 792 S.F. USEABLE 893 S.F. TOTAL 2 ND FLOOR: 2,358 S.F. 3 RD PRIVATE 391 S.F. 3 RD PRIVATE 275 S.F. TOTAL 3 RD FLOOR: 666 S.F.	- ND				- ND			
TOTAL 2 ND FLOOR: 2,358 S.F. 3RD PRIVATE 391 S.F. 3RD PRIVATE 275 S.F. TOTAL 3 RD FLOOR: 666 S.F.	2""				2110			
3RD PRIVATE 391 S.F. 3RD PRIVATE 275 S.F. TOTAL 3RD FLOOR: 666 S.F.	USEABLE		792 S.F.	<u> </u>				
TOTAL 3 RD FLOOR: 666 S.F.								-
	3 RD	PRI	/ATE	391 S.F.	3 RD			275 S.F.
TOTAL OPEN SPACE PROVIDED: 5,924 S.F.						TOTAL 3 RD	FLOOR:	666 S.F.
					TOTAL OPE	N SPACE PRO	OVIDED:	5,924 S.F.

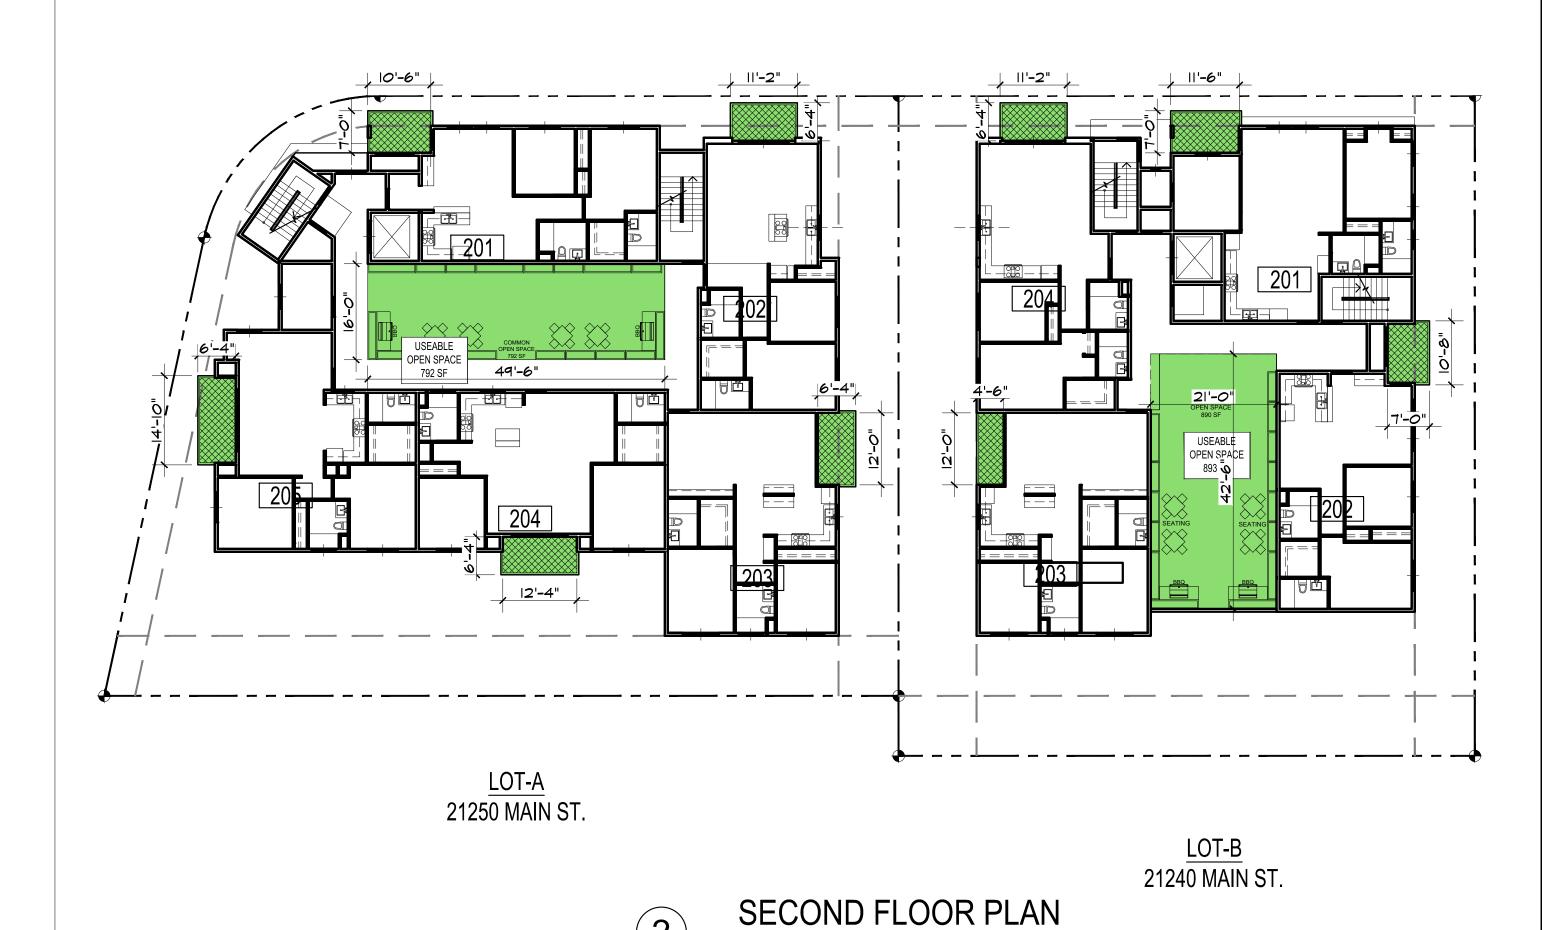

SCALE: 1/16" = 1'-0"

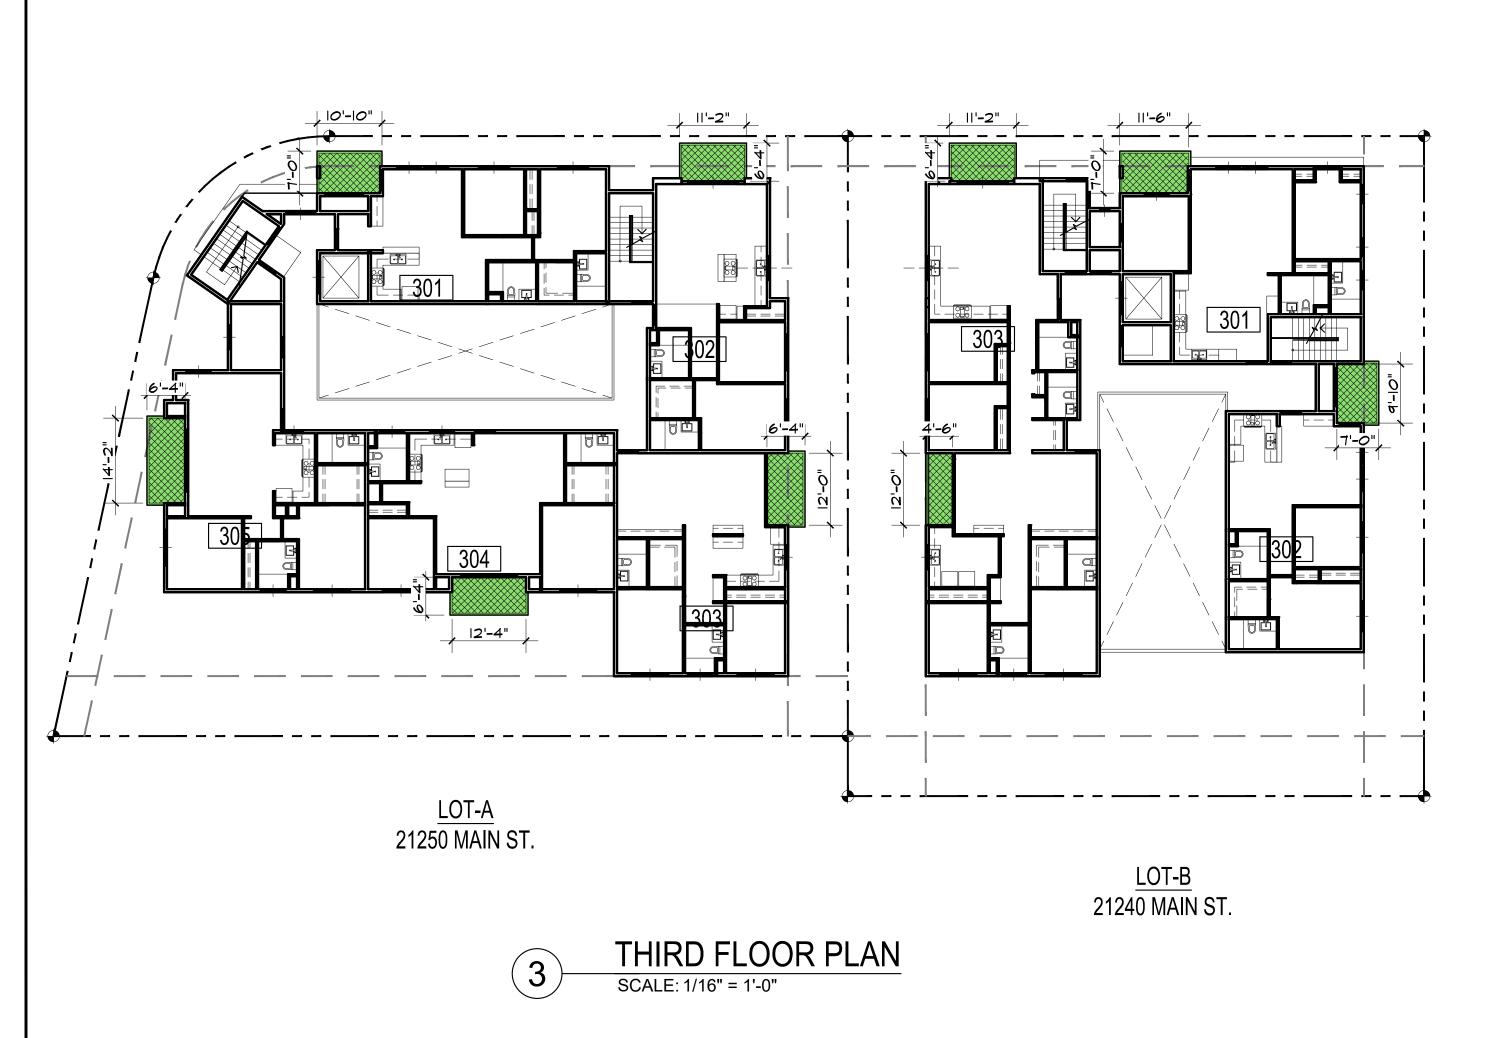

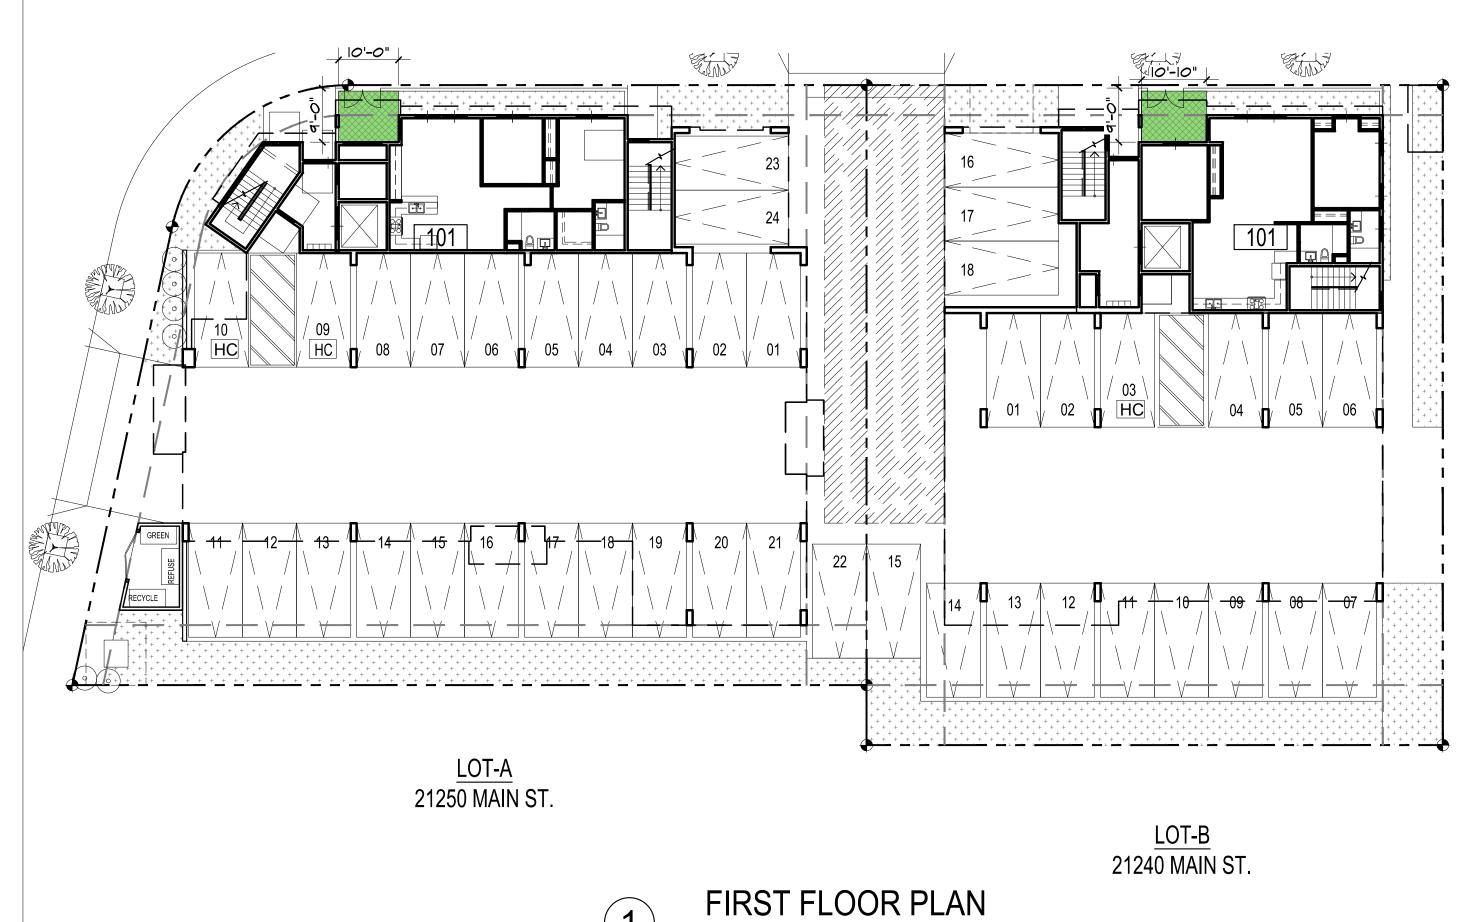

SCALE: 1/16" = 1'-0"

NO LO DESIGN STUDIO

2 1 7 3 L O M I T A B L V D . # 2 0 1 L O M I T A C A L I F O R N I A 9 0 7 1 7

Architect:

ART ASHAI, AIA
2173 LOMITA BLVD. #201
LOMITA CALIFORNIA 90717
PHONE: 424-263-5888
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Owner:

NANCY KIM

CARSON LOFIS
21240 MAIN STREET & 21250 MAIN STREET

PROJECT INFORMATION:


Project Title :

CARSON APARTMENTS

21240 Main Street Carson, CA 90745

21250 Main Street Carson, CA 90745

LEGAL DESCRIPTION APN: 7334-002-007 APN: 7334-002-008

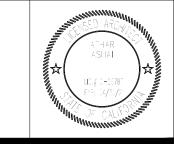



Rev.#	Date/Issue	Notes
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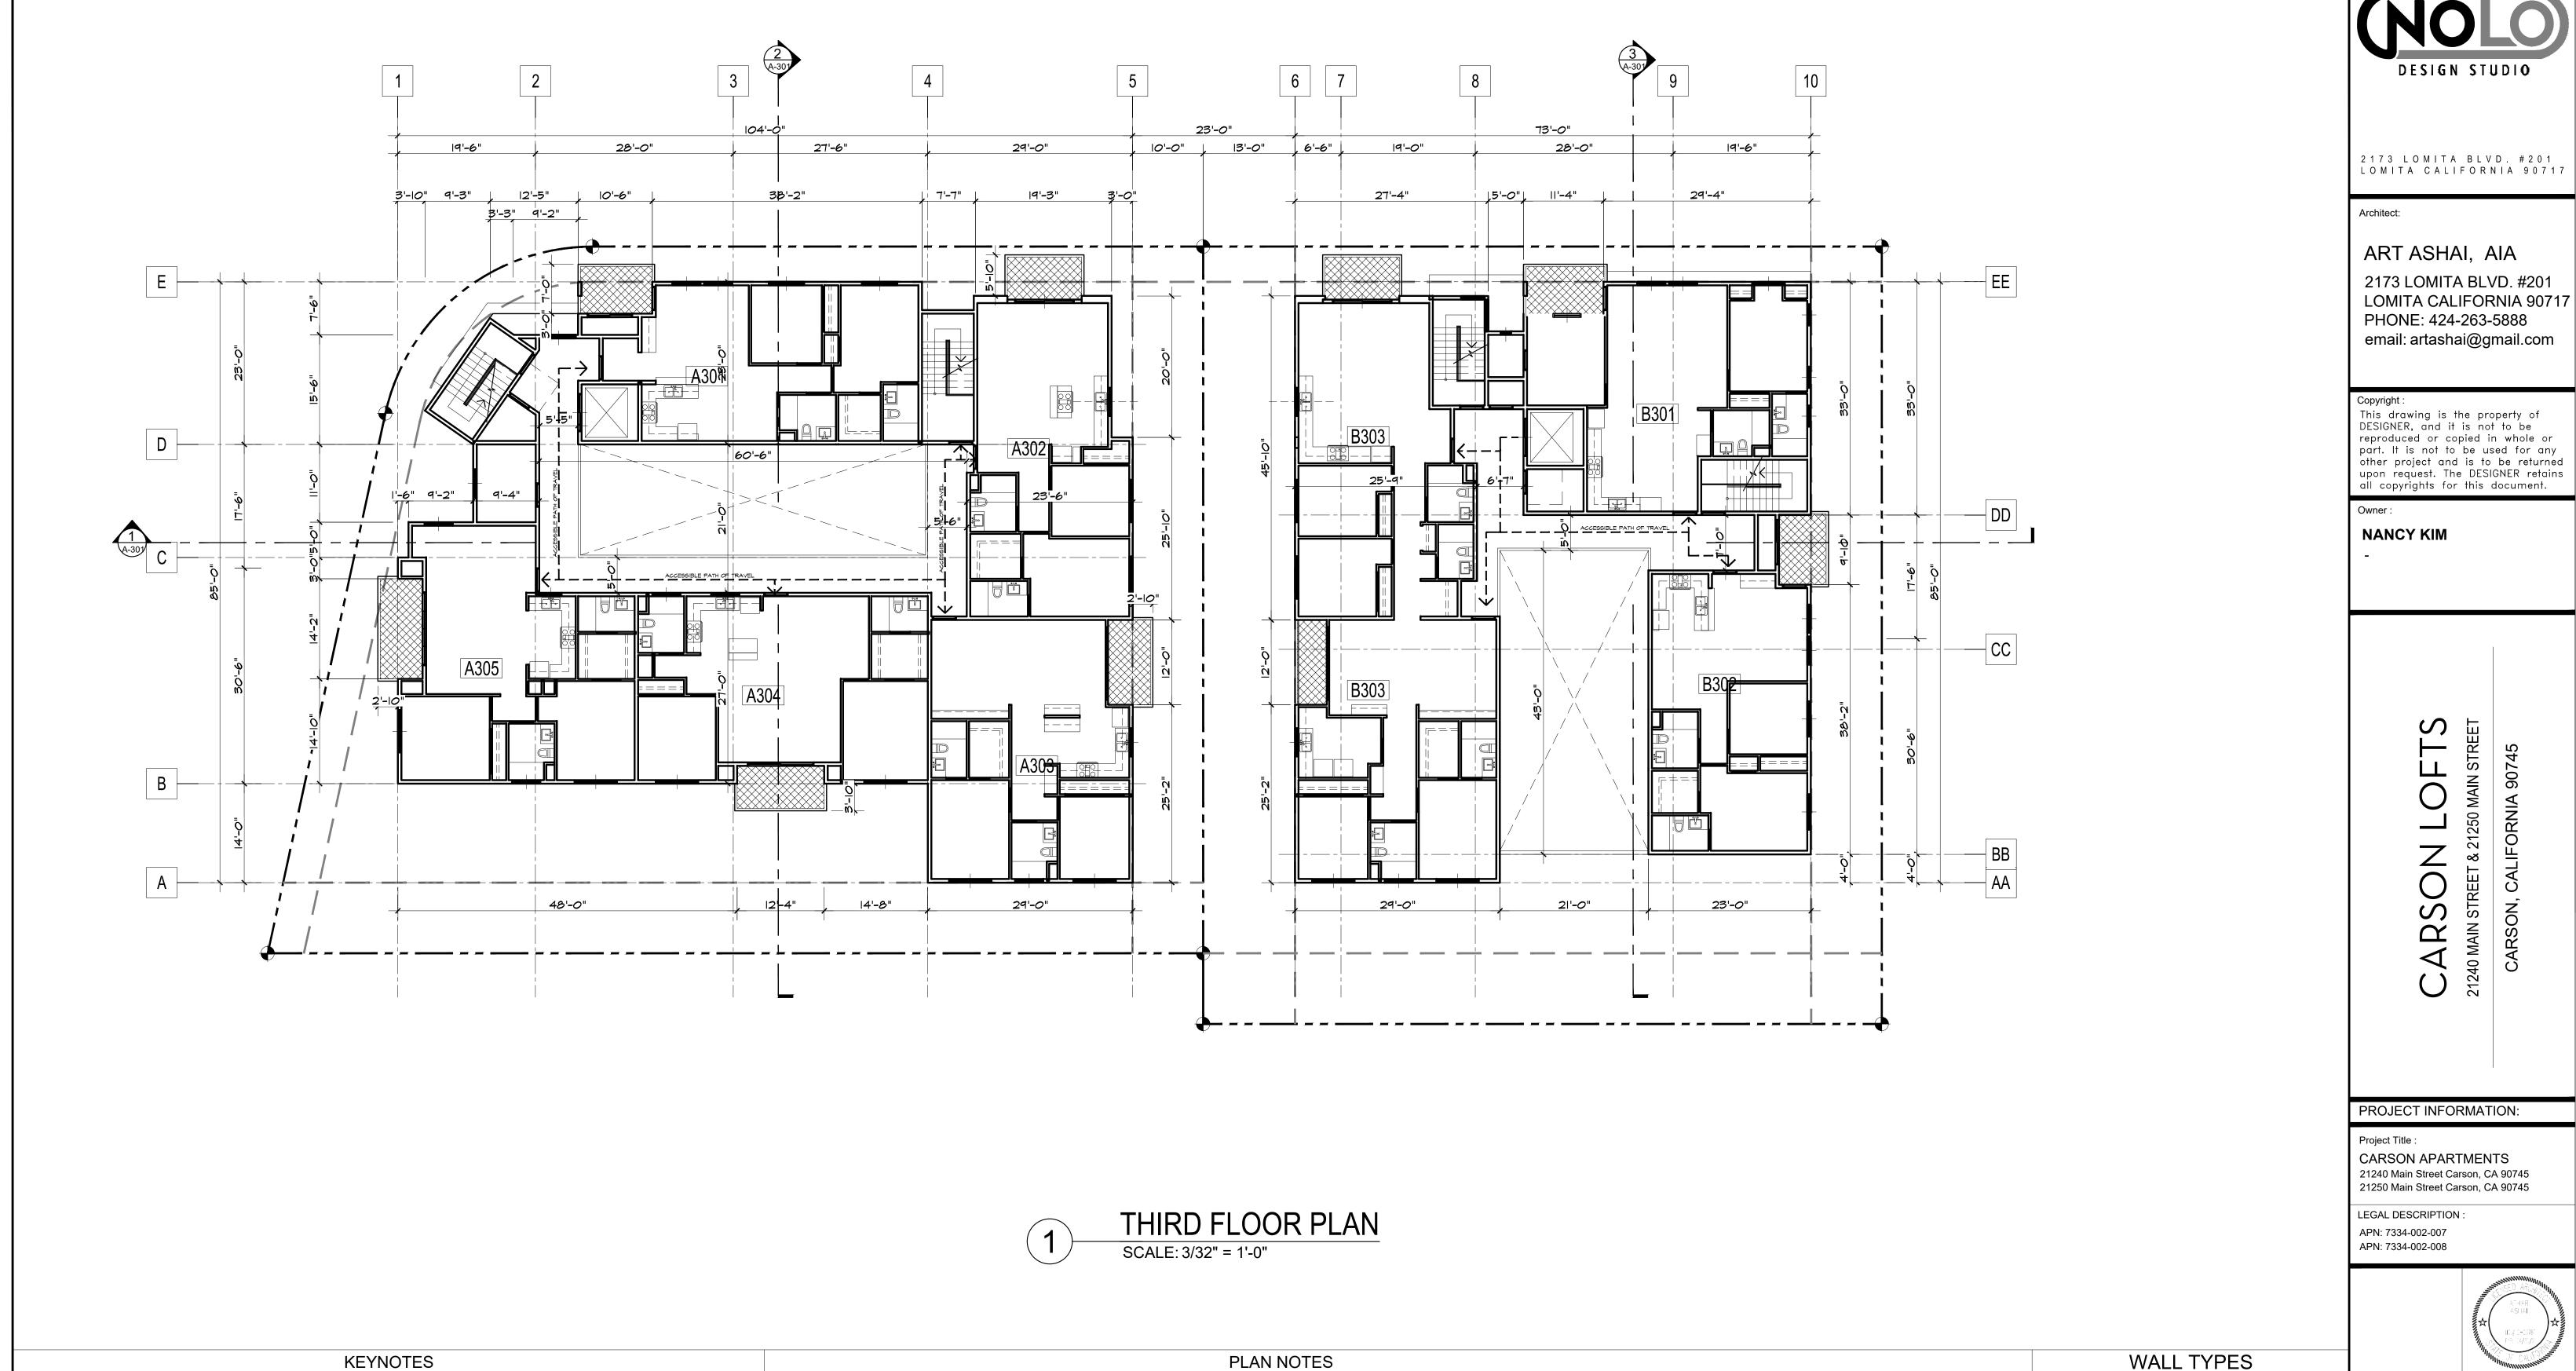
Sheet Title :

OPEN SPACE

Scale : AS NOTED	Job Number : J-1908
Date : Aug2021	Sheet Number :
Drawn: arkihaus	A-003
Check'd: CTV/RRJ	71000



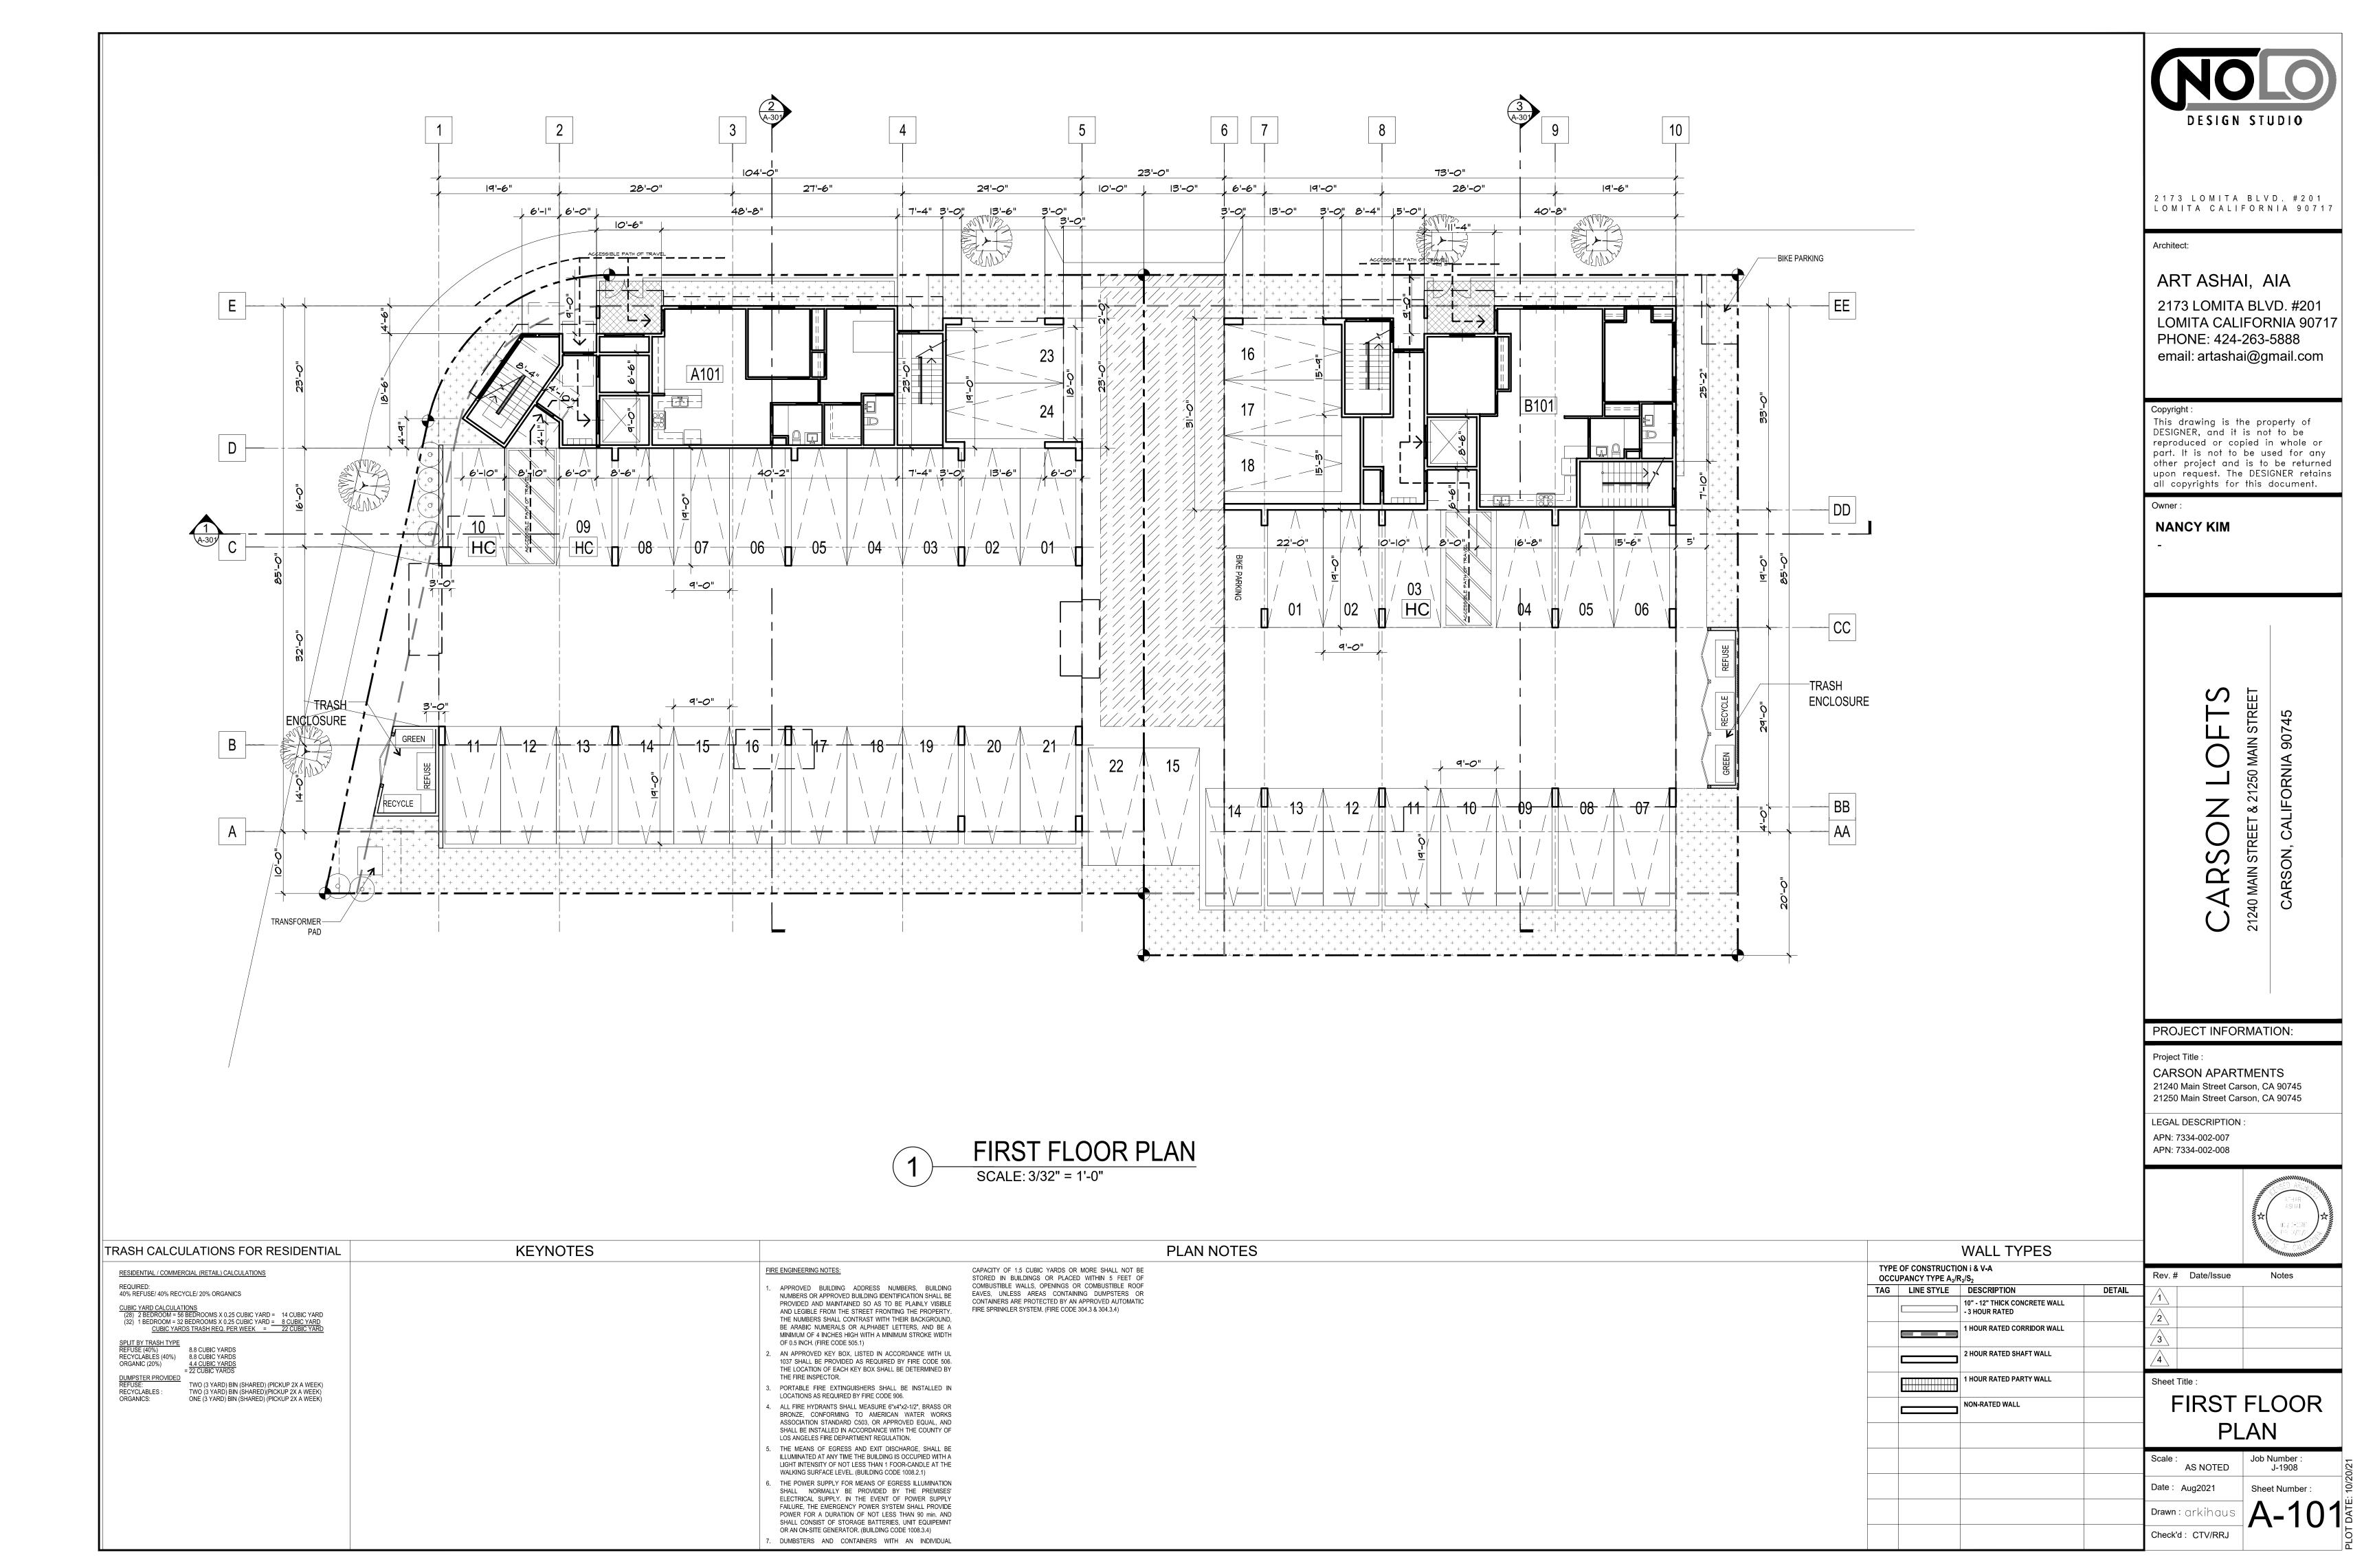

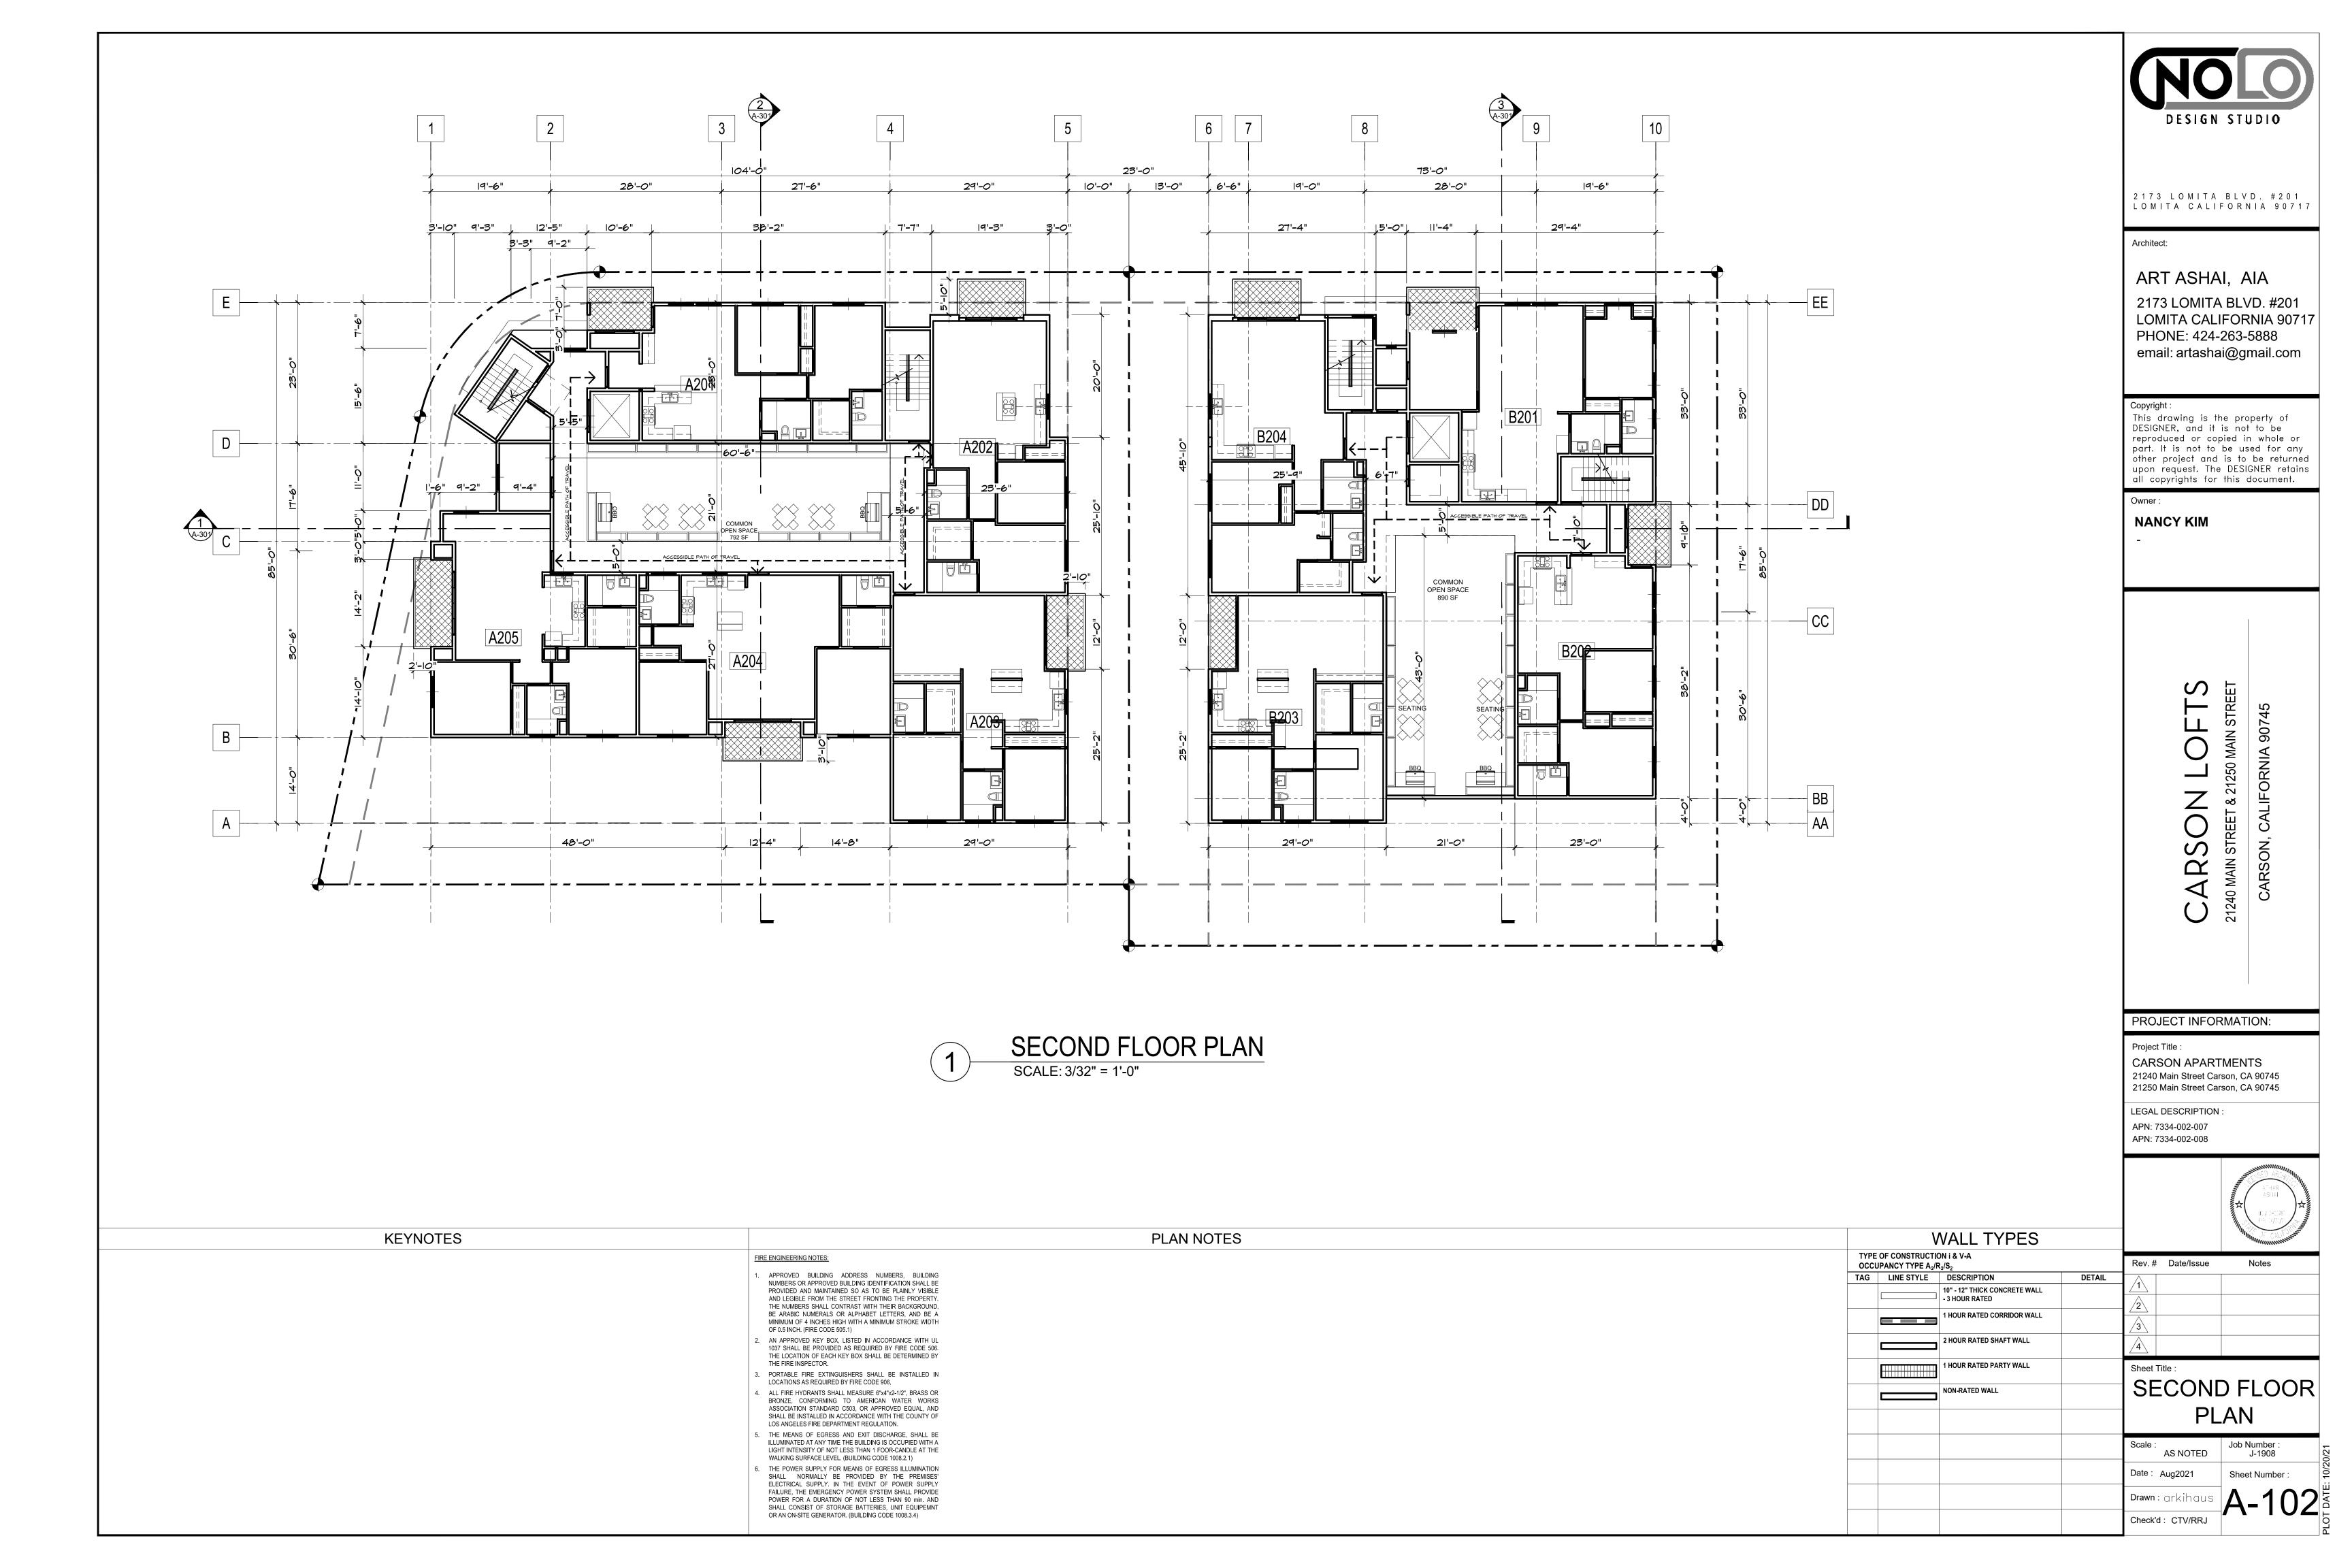

FIRE ENGINEERING NOTES:

OF 0.5 INCH. (FIRE CODE 505.1)

THE FIRE INSPECTOR.

APPROVED BUILDING ADDRESS NUMBERS, BUILDING NUMBERS OR APPROVED BUILDING IDENTIFICATION SHALL BE

PROVIDED AND MAINTAINED SO AS TO BE PLAINLY VISIBLE

MINIMUM OF 4 INCHES HIGH WITH A MINIMUM STROKE WIDTH

AN APPROVED KEY BOX, LISTED IN ACCORDANCE WITH UL

1037 SHALL BE PROVIDED AS REQUIRED BY FIRE CODE 506. THE LOCATION OF EACH KEY BOX SHALL BE DETERMINED BY

PORTABLE FIRE EXTINGUISHERS SHALL BE INSTALLED IN

ALL FIRE HYDRANTS SHALL MEASURE 6"x4"x2-1/2", BRASS OR BRONZE, CONFORMING TO AMERICAN WATER WORKS ASSOCIATION STANDARD C503, OR APPROVED EQUAL, AND

SHALL BE INSTALLED IN ACCORDANCE WITH THE COUNTY OF

5. THE MEANS OF EGRESS AND EXIT DISCHARGE, SHALL BE ILLUMINATED AT ANY TIME THE BUILDING IS OCCUPIED WITH A LIGHT INTENSITY OF NOT LESS THAN 1 FOOR-CANDLE AT THE

SHALL NORMALLY BE PROVIDED BY THE PREMISES' ELECTRICAL SUPPLY. IN THE EVENT OF POWER SUPPLY FAILURE, THE EMERGENCY POWER SYSTEM SHALL PROVIDE

POWER FOR A DURATION OF NOT LESS THAN 90 min. AND SHALL CONSIST OF STORAGE BATTERIES, UNIT EQUIPEMNT OR AN ON-SITE GENERATOR. (BUILDING CODE 1008.3.4)

WALKING SURFACE LEVEL. (BUILDING CODE 1008.2.1) THE POWER SUPPLY FOR MEANS OF EGRESS ILLUMINATION

LOCATIONS AS REQUIRED BY FIRE CODE 906.

LOS ANGELES FIRE DEPARTMENT REGULATION.

AND LEGIBLE FROM THE STREET FRONTING THE PROPERTY. THE NUMBERS SHALL CONTRAST WITH THEIR BACKGROUND, BE ARABIC NUMERALS OR ALPHABET LETTERS, AND BE A 21250 Main Street Carson, CA 90745 LEGAL DESCRIPTION APN: 7334-002-007 APN: 7334-002-008

21240 MAIN STREET

Project Title:

CARSON APARTMENTS 21240 Main Street Carson, CA 90745

DESIGN STUDIO

LOMITA CALIFORNIA 90717


email: artashai@gmail.com


Architect:


WALL TYPES TYPE OF CONSTRUCTION i & V-A Rev. # Date/Issue OCCUPANCY TYPE A₂/R₂/S₂ TAG LINE STYLE DESCRIPTION DETAIL 10" - 12" THICK CONCRETE WALL 1 HOUR RATED CORRIDOR WALL 2 HOUR RATED SHAFT WALL 1 HOUR RATED PARTY WALL Sheet Title : THIRD FLOOR NON-RATED WALL PLAN

AS NOTED J-1908 Date: Aug2021 Sheet Number: Drawn: arkihaus

Check'd: CTV/RRJ

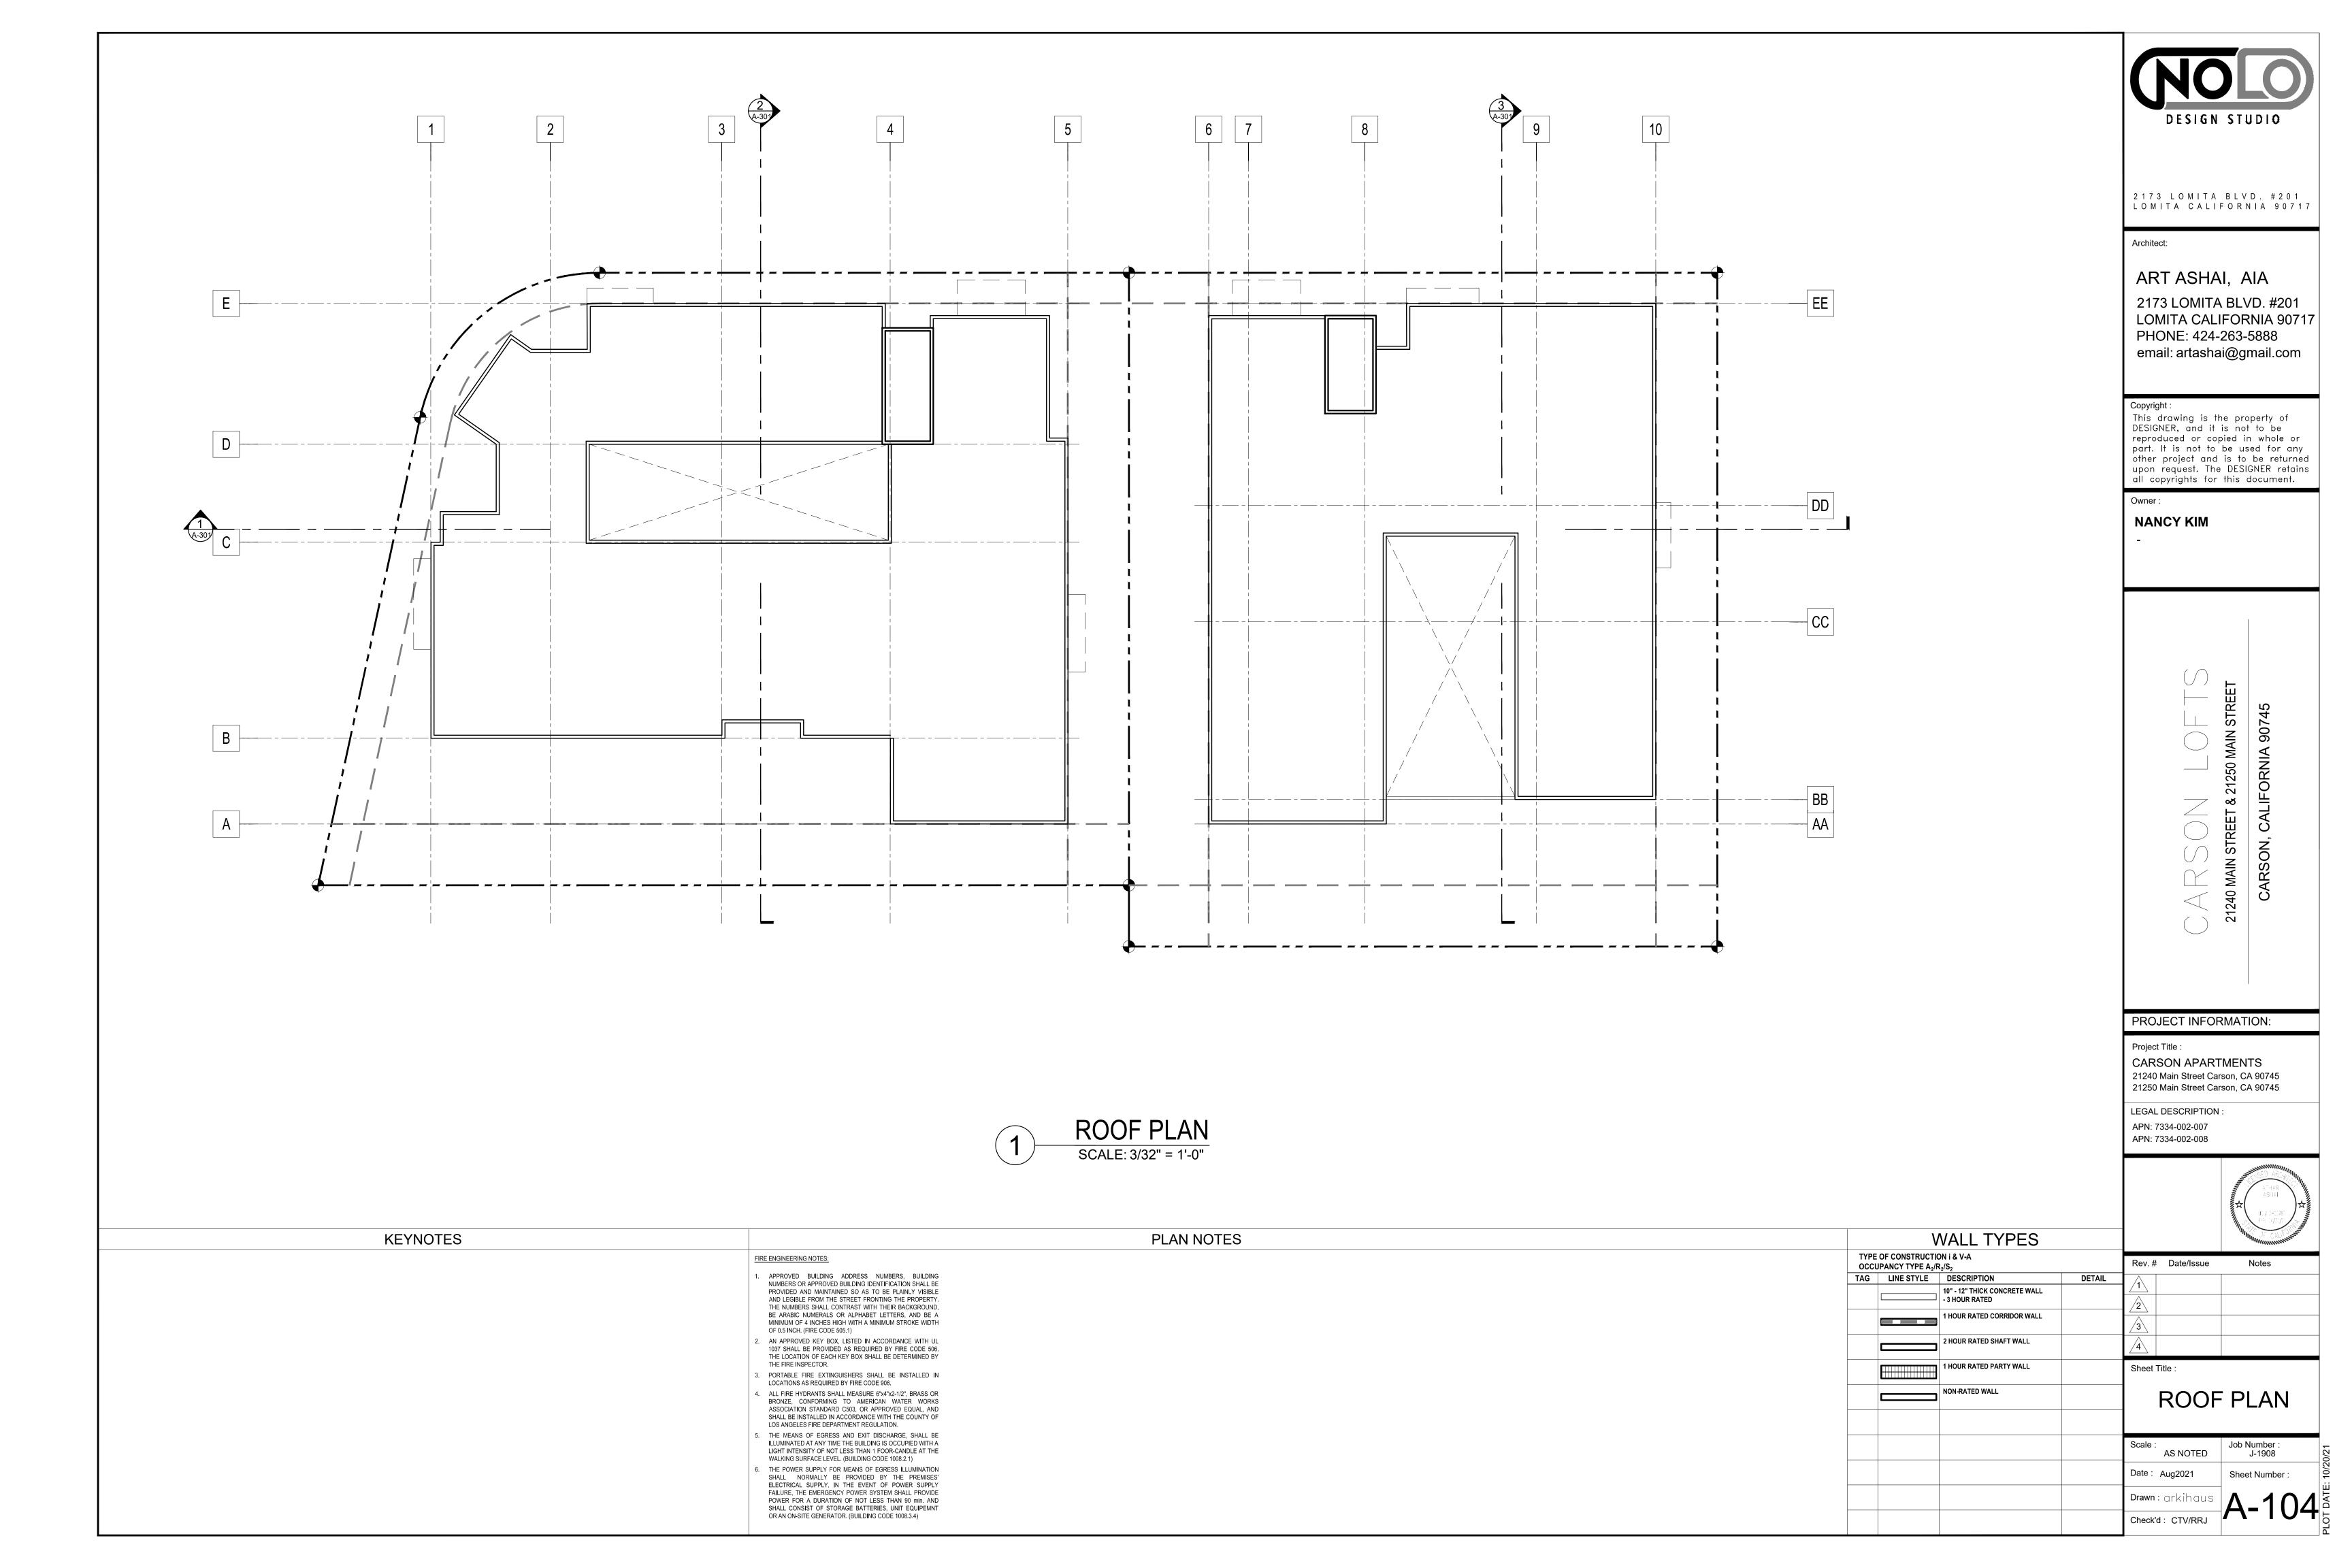


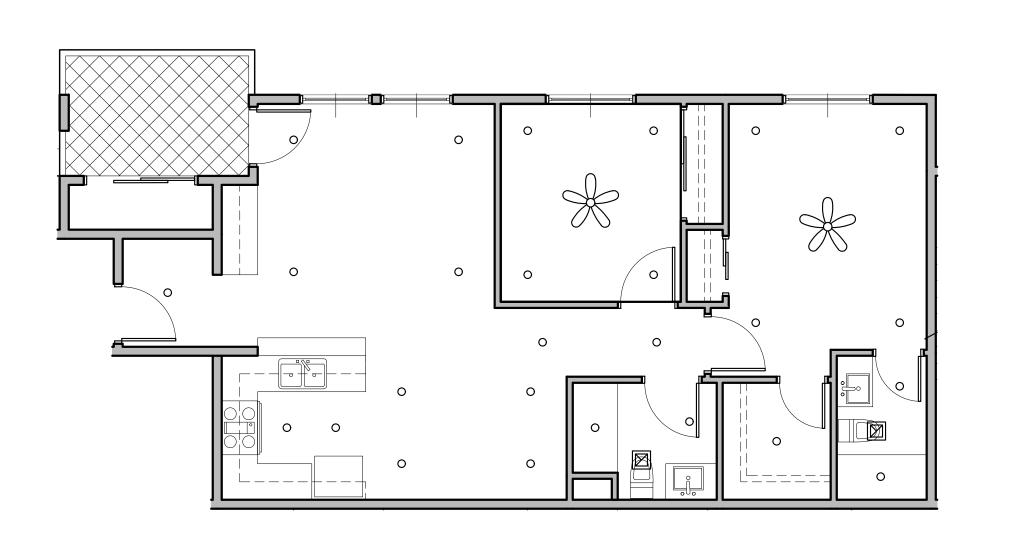


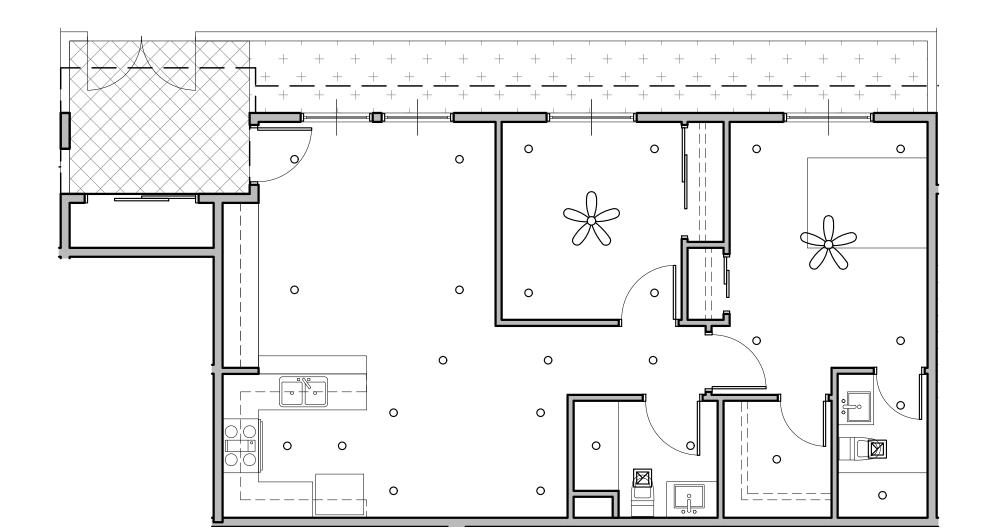

UNIT PLAN 201, 301 - REFLECTED CEILING PLAN



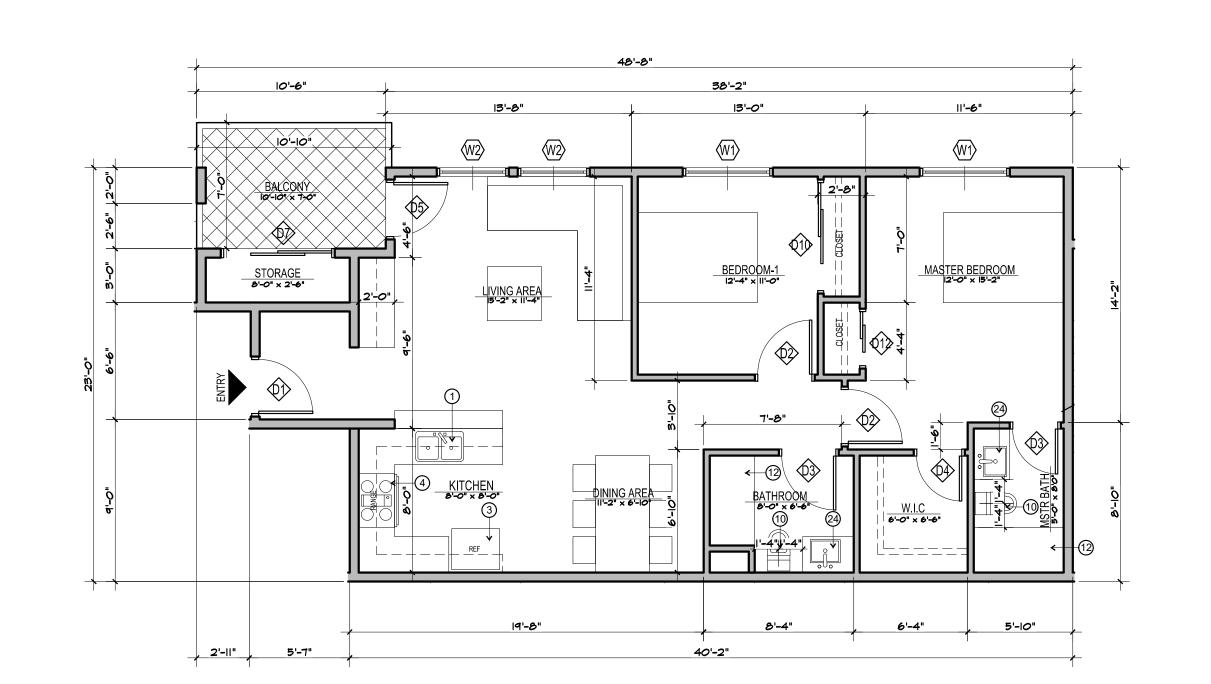

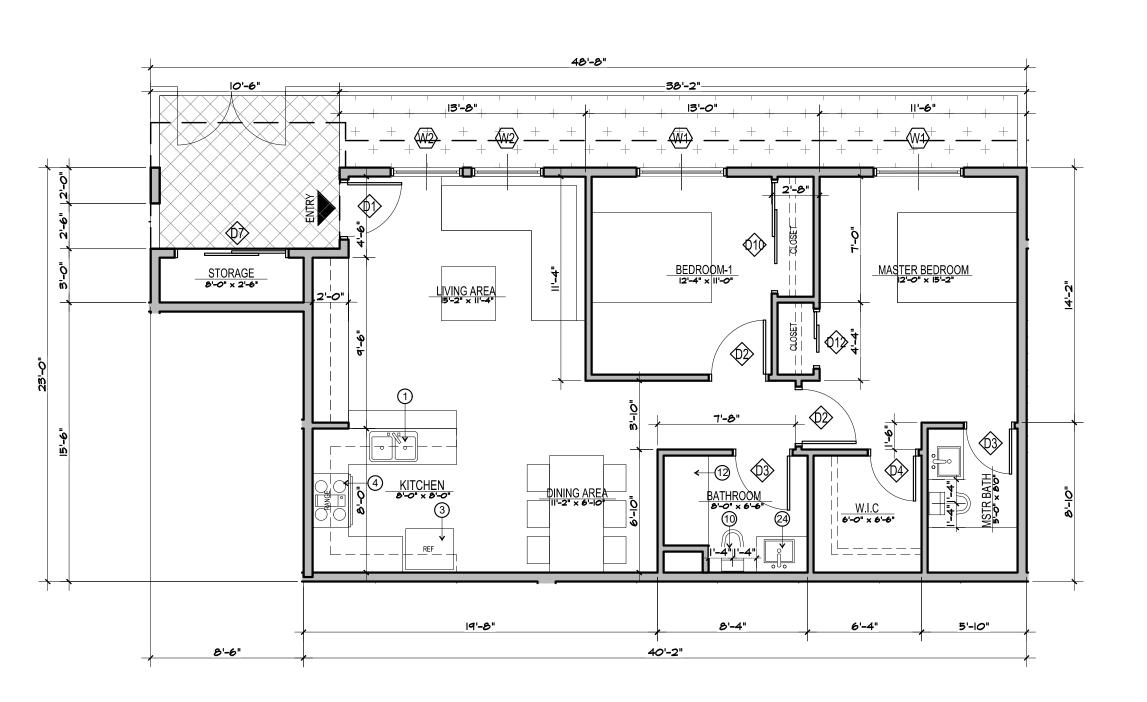

GENERAL NOTES

- DWELLING UNITS ACCESSIBILITY, REFER TO SHEET A-
- COMMON AN PUBLIC AREAS ACCESSIBILITY, REFER TO SHEETS A- AND AALL TUB/SHOWER COMBOS WILL BE UTILIZED FIBERGLASS.
 WALLS ARE PERMITTED TO BE OF NON-RATED CONSTRUCTION EXCEPTS AS GRAPHICALLY NOTED ON BUILI
- COMPOSITE FLOOR PLANS. UNITS SHALL HAVE AT LEAST A MINIMUM LEAKAGE OF 0.30 CFM50 PER SQUARE FOOT OF ENCLOSURE.
- WATER HEATER UNIT MODEL SEE PLUMBING SCHEDULE. RECESSED LIGHTING SHALL BE "BOXED IN" AT FIRE RATED FLOOR/CLG CONDITIONS DIMENSIONS ARE MEASURED FROM FACE OF STUD (FOS) UNLESS NOTED OTHERWISE.

ELEMENT	DESCRIPTION
TYPE A	5/8" GYPSUM BOAR - TAPE, TEXTURE AND PAINT - SATIN LEVEL FIN
TYPE B	5/8" GYPSUM BOAR - TAPE, TEXTURE AND PAINT - SEMI GLOSS LEVEL 4 FIN
TYPE C	EXTERIOR SOFFIT 5/8 " GYP BOARD TYPR X - TAPE, TEXTURE STUCCO FINISH
	LIMIT OF SOFFIT ABOVE - HEIGHT PER FLOOR PLAN. REFER TO DET 14 & 15/A-
1/2"	FLOOR LEVEL AT DOORS SHALL NOT BE MORE THAN $\frac{1}{2}$ INCH LOWER THAN THRESHOLD AT THE DOORWAY PER C.B.C. SECTION 1008.1.6 AND 1132A. 4.1
HS C	FLOOR MATERIAL FLUSH TRANSITION
A A	INTERIOR ELEVATION KEY
IVING ROOM CARPET 9'-0"	ROOM NAME — FLOOR FINISH — CEILING HEIGHT
(00)	DOOR NUMBER - REFER TO DOOR SCHEDULE
200	WINDOW TYPE - REFER TO WINDOW SCHEDULE
0	RECESSED LIGHT FIXTURE (AT AND IC RATED)
H	CEILING FAN
	SUPPLY AIR REGISTER
] →→	SUPPLY AIR SIDE WALL REGISTER
	RETURN AIR REGISTER
	RETURN AIR SIDE WALL REGISTER
	EXHAUST AIR REGISTER / FAN - ENERGY STAR COMPLIANT - SEE MECH
©D	SMOKE DETECTOR

UNIT PLAN KEYNOTES

DOUBLE BOWL SINK W WITH GARAGE DISPOSAL & HOLE FOR DISHWASHER AIR GAP. PROVIDE ADAPTABLE REQUIREMENTS WHERE NOTED/ REFER TO SCHEDULE OF FINISHES.

CARBON MONOXIDE DETECTOR

- UNDER-COUNTER +/ -- 24" WIDE DISHWASHER (BOSCH 24" ADA OR APPROVED EQUAL. ENERGY STAR CERTIFIED). PROVIDE ADAPTABLE REQUIREMENTS. REFER TO SCHEDULE OF FINISHES.
- REFRIGERATOR SPACE. PROVIDE COLD WATER STUB-OUT IN RECESSED WALL BOX FOR ICE MAKER. PROVIDE 1-HR RATED WALL RECESS WHERE OCCURS IN 1-HR RATED WALL ASSEMBLY. PROVIDE ADAPTABLE REQUIREMENTS. REFER TO SCHEDULE OF FINISHES.

WALL TYPE SYMBOL. - SEE SCHEDULE ON SHEET A-- AND A-

- FREE STANDING RANGE AND OVER THE RANGE MICROWAVE (BOTH ENERGY STAR CERTIFIED) VERIFY AND INSTALL APPLIANCES PER MANUFACTURER'S REQUIREMENTS. PROVIDE ADAPTABLE REQUIREMENTS. PROVIDE
- (5) 24" DEEP BASE CABINET WITH COUNTERTOP
- 6) 12" DEEP UPPER CABINET

3/16" = 1'-0"

- 7) ENERGY STAR WASHER AND DRYER STACKED 8 VOID SPACE, FILL IN WITH INSULATION
- 9 ULTRA-LOW FLUSH TOILET REFER TO DETAIL FOR ACCESSIBILITY
- (10) 32" x 60" TUB/SHOWER VERIFY UNIT DIMENSIONS WITH MANUFACTURER PRIOR TO FRAMING
- RECESSED MEDICINE CABINET. PROVIDE 1- HR RATED WALL RECESS WHERE OCCURS IN 1 -HR RATED WALL FUTURE 36" GRAB BAR. PROVIDE SOLID BLOCKING CONCEALED WITHIN WALL CENTERED ON BAR LOCATION
- 3) FUTURE 42" GRAB BAR. PROVIDE SOLID BLOCKING CONCEALED WITHIN WALL CENTERED ON BAR LOCATION
- 4) ELECTRIC PANEL REFER TO ELECTRICAL DRAWINGS FOR SOME INFORMATION
- STUD BAY AT EACH END & CENTER OF POLE FOR POLE HARDWARE. VERIFY SHELF BRACKETS & PROVIDE CONCEALED 2x BLOCKING ACCORDINGLY.
- CEILING MOUNTED HORIZONTAL FAN COIL UNIT. (SEE MECHANICAL PLANS) VERIFY UNIT DIMENSIONS AND CLEARANCE REQUIREMENTS PRIOR TO FRAMING AND SETTING DROPPED CEILING HEIGHT. PROVIDE MINIMUM REQUIRED MANUFACTURE ACCESS PANEL COMPATIBLE WITH F.C.U. PAINT PANEL TO MATCH CEILING.
- METAL THRESHOLD. FLOOR LEVEL CHANGES GREATER THAN 1 AT DOORWAYS SHALL BE BEVELED OR SLOPE NOT GREATER THAN ONE UNIT VERTICAL IN TWO UNITS HORIZONTAL (50% SLOPE). REFER TO DETAILS AT ENTRY DOOR AT BALCONY SLIDING DOOR
- 19) UNIT DOOR BELL AT +48"AFF SEE ELEC
- (20) ACCESSIBLE COMPLIANT LAVATORY
- (21) UNIT SIGNAGE
- 22) WATER SUB METER AT HIGH LEVEL INSIDE CEILING SPACE WITH CEILING ACCESS SEE PLUMBING DUAL REMOTE WATER METER DISPLAY. MOUNT HT. AT 4' - 0". ABOVE FINISH FLOOR TO TOP OF DISPLAY
- 25) ENERGY STAR TANKLESS WATER HEATER. SEE PLUMBING DRAWINGS. VERIFY REQUIRED CLEARANCES WITH MFR PRIOR TO FRAMING
- 26) SMOKE DETECTOR
- 27) CARBON MONOXIDE DETECTOR 28) 42" HIGH GUARD RAIL - REFER TO EXTERIOR ELEVATIONS.
- (29) EXTERIOR LOW WALL REFER TO EXTERIOR ELEVATION
- 30) 1HR RATED SHAFT CONTRACTOR TO VERIFY WITH MECHANICAL DRAWINGS
- (31) EXTERIOR EXHAUST LOUVER SEE MECHANICAL
- (32) GUTTER

SCALE

3/16" = 1'-0"

- (33) SCUPPER
- (34) CEILING BREAK
- (35) 2" WIDE PVC SOFFIT VENT SEE DETAIL
- (36) NOT USED



2173 LOMITA BLVD. #201 LOMITA CALIFORNIA 90717

ART ASHAI, AIA

2173 LOMITA BLVD. #201 LOMITA CALIFORNIA 90717 PHONE: 424-263-5888

email: artashai@gmail.com

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NANCY KIM

& 21250 21240 MAIN STREE

PROJECT INFORMATION:

21250 Main Street Carson, CA 90745

CARSON APARTMENTS 21240 Main Street Carson, CA 90745

LEGAL DESCRIPTION APN: 7334-002-007

APN: 7334-002-008




Rev.#	Date/Issue	Notes
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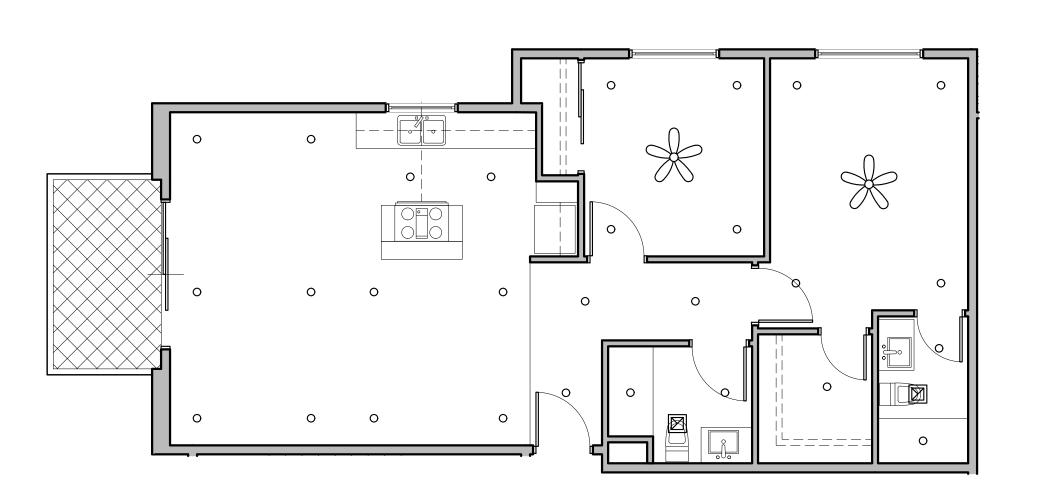
BUILDING A-UNIT PLANS

AS NOTED J-1908 Date: Aug2021 Drawn: arkihaus Check'd: CTV/RRJ


SCALE
3/16" = 1'-0"

O3 UNIT PLAN 101 - FLOOR PLAN UNIT PLAN 201, 301 - FLOOR PLAN




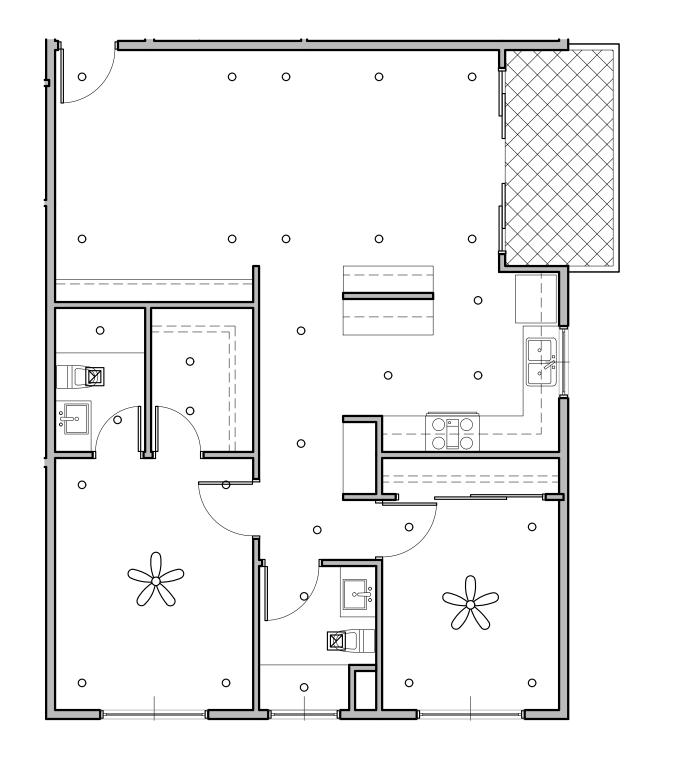


UNIT PLAN 203, 303 - REFLECTED CEILING PLAN

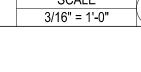

UNIT PLAN 202, 302 - REFLECTED CEILING PLAN

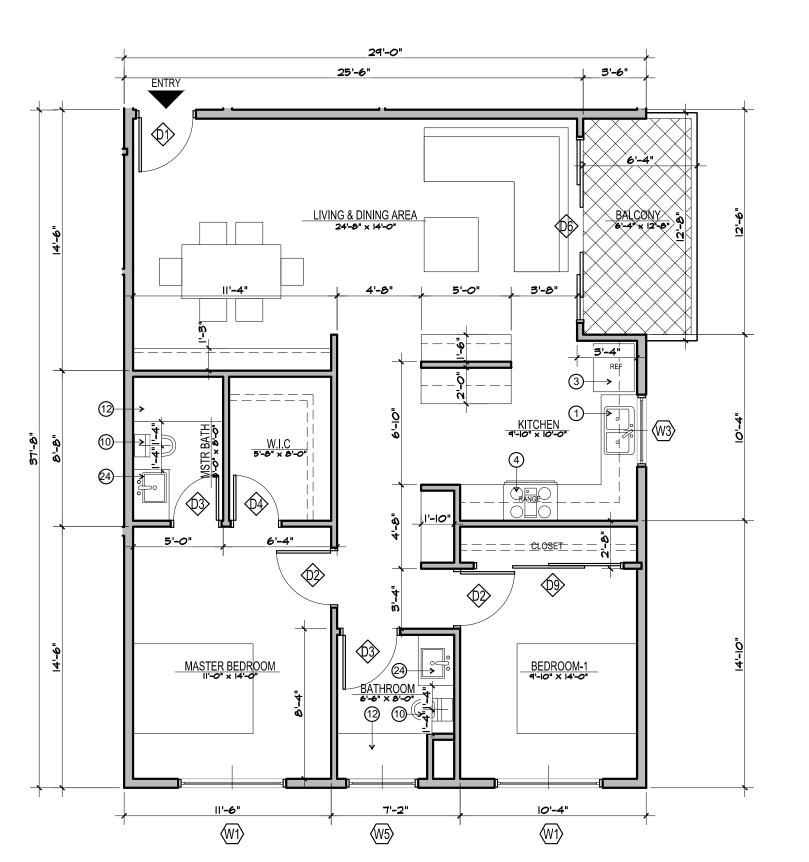

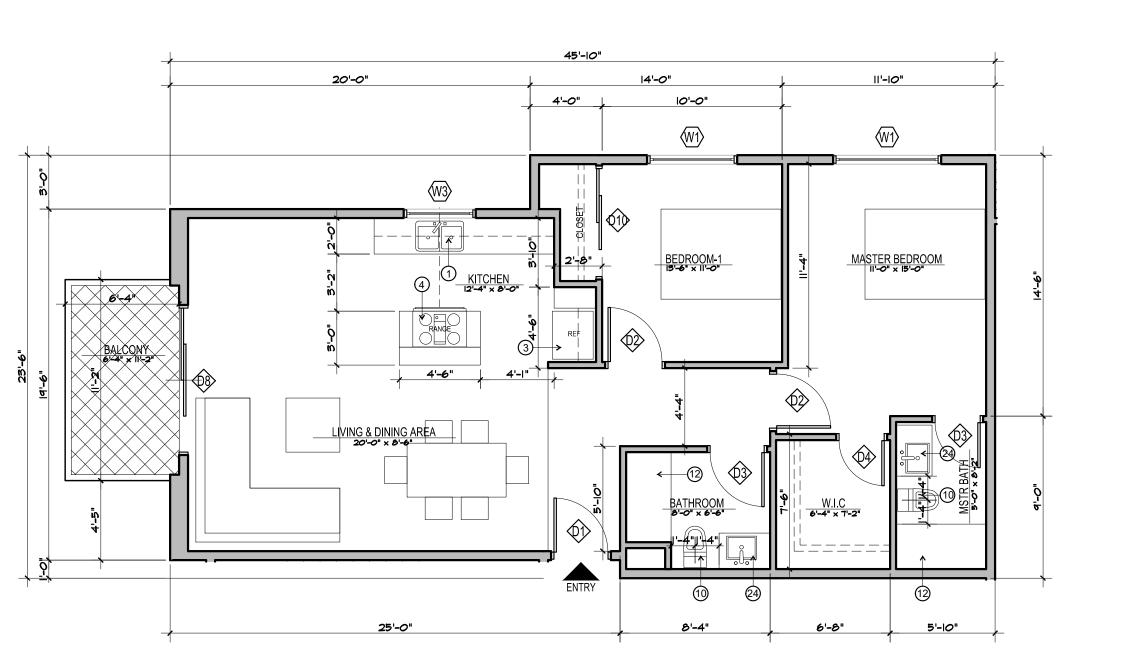

GENERAL NOTES

- DWELLING UNITS ACCESSIBILITY, REFER TO SHEET A-
- COMMON AN PUBLIC AREAS ACCESSIBILITY, REFER TO SHEETS A- AND A-
- ALL TUB/SHOWER COMBOS WILL BE UTILIZED FIBERGLASS. WALLS ARE PERMITTED TO BE OF NON-RATED CONSTRUCTION EXCEPTS AS GRAPHICALLY NOTED ON BUIL COMPOSITE FLOOR PLANS.
- UNITS SHALL HAVE AT LEAST A MINIMUM LEAKAGE OF 0.30 CFM50 PER SQUARE FOOT OF ENCLOSURE. WATER HEATER UNIT MODEL SEE PLUMBING SCHEDULE.
- RECESSED LIGHTING SHALL BE "BOXED IN" AT FIRE RATED FLOOR/CLG CONDITIONS 8. DIMENSIONS ARE MEASURED FROM FACE OF STUD (FOS) UNLESS NOTED OTHERWISE.

UNIT PLAN LEGEND

5/8" GYPSUM BOAR - TAPE, TEXTURE AND PAINT -SATIN LEVEL FIN 5/8" GYPSUM BOAR - TAPE, TEXTURE AND PAINT -SEMI GLOSS LEVEL 4 FIN EXTERIOR SOFFIT 5/8 " GYP BOARD TYPR X - TAPE, TEXTURE STUCCO FINISH LIMIT OF SOFFIT ABOVE - HEIGHT PER FLOOR PLAN. REFER TO FLOOR LEVEL AT DOORS SHALL NOT BE MORE THAN $\frac{1}{2}$ INCH LOWER THAN FLOOR MATERIAL FLUSH TRANSITION INTERIOR ELEVATION KEY LIVING ROOM ROOM NAME CARPET FLOOR FINISH
9'-0" CEILING HEIGHT DOOR NUMBER - REFER TO DOOR SCHEDULE WINDOW TYPE - REFER TO WINDOW SCHEDULE RECESSED LIGHT FIXTURE (AT AND IC RATED) SUPPLY AIR REGISTER SUPPLY AIR SIDE WALL REGISTER RETURN AIR REGISTER RETURN AIR SIDE WALL REGISTER EXHAUST AIR REGISTER / FAN - ENERGY STAR COMPLIANT - SEE MECH SMOKE DETECTOR CARBON MONOXIDE DETECTOR WALL TYPE SYMBOL. - SEE SCHEDULE ON SHEET A- AND A-

UNIT PLAN KEYNOTES

- DOUBLE BOWL SINK W WITH GARAGE DISPOSAL & HOLE FOR DISHWASHER AIR GAP. PROVIDE ADAPTABLE REQUIREMENTS WHERE NOTED/ REFER TO SCHEDULE OF FINISHES.
- UNDER-COUNTER +/ $\,-$ 24" WIDE DISHWASHER (BOSCH 24" ADA OR APPROVED EQUAL. ENERGY STAR CERTIFIED). PROVIDE ADAPTABLE REQUIREMENTS. REFER TO SCHEDULE OF FINISHES.
- REFRIGERATOR SPACE. PROVIDE COLD WATER STUB-OUT IN RECESSED WALL BOX FOR ICE MAKER. PROVIDE 1-HR RATED WALL RECESS WHERE OCCURS IN 1-HR RATED WALL ASSEMBLY. PROVIDE ADAPTABLE REQUIREMENTS. REFER TO SCHEDULE OF FINISHES.
- FREE STANDING RANGE AND OVER THE RANGE MICROWAVE (BOTH ENERGY STAR CERTIFIED) VERIFY AND INSTALL APPLIANCES PER MANUFACTURER'S REQUIREMENTS. PROVIDE ADAPTABLE REQUIREMENTS. PROVIDE
- (5) 24" DEEP BASE CABINET WITH COUNTERTOP
- 6 12" DEEP UPPER CABINET

3/16" = 1'-0"

- (7) ENERGY STAR WASHER AND DRYER STACKED 8 VOID SPACE, FILL IN WITH INSULATION
- (9) ULTRA-LOW FLUSH TOILET REFER TO DETAIL FOR ACCESSIBILITY
- (10) 32" x 60" TUB/SHOWER VERIFY UNIT DIMENSIONS WITH MANUFACTURER PRIOR TO FRAMING
- RECESSED MEDICINE CABINET. PROVIDE 1- HR RATED WALL RECESS WHERE OCCURS IN 1 -HR RATED WALL
- FUTURE 36" GRAB BAR. PROVIDE SOLID BLOCKING CONCEALED WITHIN WALL CENTERED ON BAR LOCATION
- (13) FUTURE 42" GRAB BAR. PROVIDE SOLID BLOCKING CONCEALED WITHIN WALL CENTERED ON BAR LOCATION
- 14) ELECTRIC PANEL REFER TO ELECTRICAL DRAWINGS FOR SOME INFORMATION
- STUD BAY AT EACH END & CENTER OF POLE FOR POLE HARDWARE. VERIFY SHELF BRACKETS & PROVIDE CONCEALED 2x BLOCKING ACCORDINGLY.
- CEILING MOUNTED HORIZONTAL FAN COIL UNIT. (SEE MECHANICAL PLANS) VERIFY UNIT DIMENSIONS AND CLEARANCE REQUIREMENTS PRIOR TO FRAMING AND SETTING DROPPED CEILING HEIGHT. PROVIDE MINIMUM REQUIRED MANUFACTURE ACCESS PANEL COMPATIBLE WITH F.C.U. PAINT PANEL TO MATCH CEILING.
- 8 METAL THRESHOLD. FLOOR LEVEL CHANGES GREATER THAN ‡" AT DOORWAYS SHALL BE BEVELED OR SLOPE NOT GREATER THAN ONE UNIT VERTICAL IN TWO UNITS HORIZONTAL (50% SLOPE). REFER TO DETAILS AT ENTRY DOOR AT BALCONY SLIDING DOOF
- 19) UNIT DOOR BELL AT +48"AFF SEE ELEC
- (20) ACCESSIBLE COMPLIANT LAVATORY
- (21) UNIT SIGNAGE
- 22) WATER SUB METER AT HIGH LEVEL INSIDE CEILING SPACE WITH CEILING ACCESS SEE PLUMBING DUAL REMOTE WATER METER DISPLAY. MOUNT HT. AT 4' - 0". ABOVE FINISH FLOOR TO TOP OF DISPLAY
- (24) 15" MIN. BREADBOARD
- 25) ENERGY STAR TANKLESS WATER HEATER. SEE PLUMBING DRAWINGS. VERIFY REQUIRED CLEARANCES WITH MFR PRIOR TO FRAMING
- (26) SMOKE DETECTOR
- (27) CARBON MONOXIDE DETECTOR
- (28) 42" HIGH GUARD RAIL REFER TO EXTERIOR ELEVATIONS. (29) EXTERIOR LOW WALL - REFER TO EXTERIOR ELEVATION
- (30) 1HR RATED SHAFT CONTRACTOR TO VERIFY WITH MECHANICAL DRAWINGS
- (31) EXTERIOR EXHAUST LOUVER SEE MECHANICAL (32) GUTTER
- (33) SCUPPER
- (34) CEILING BREAK
- (35) 2" WIDE PVC SOFFIT VENT SEE DETAIL
- (36) NOT USED



2173 LOMITA BLVD. #201

LOMITA CALIFORNIA 90717

Architect:

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NANCY KIM

STREET

∘ŏ 21240 MAIN STREE

PROJECT INFORMATION:


CARSON APARTMENTS

21240 Main Street Carson, CA 90745

21250 Main Street Carson, CA 90745

LEGAL DESCRIPTION APN: 7334-002-007

APN: 7334-002-008

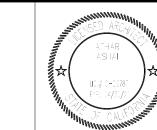

Rev.#	Date/Issue	Notes	
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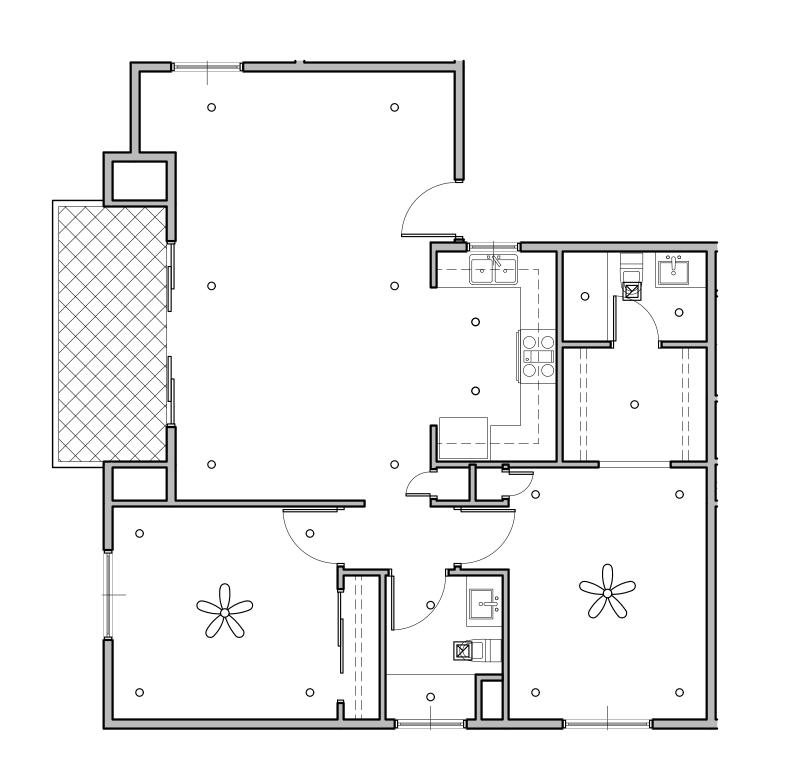
BUILDING A-UNIT PLANS


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UNIT PLAN 203, 303 - FLOOR PLAN


UNIT PLAN 202, 302 - FLOOR PLAN


SCALE



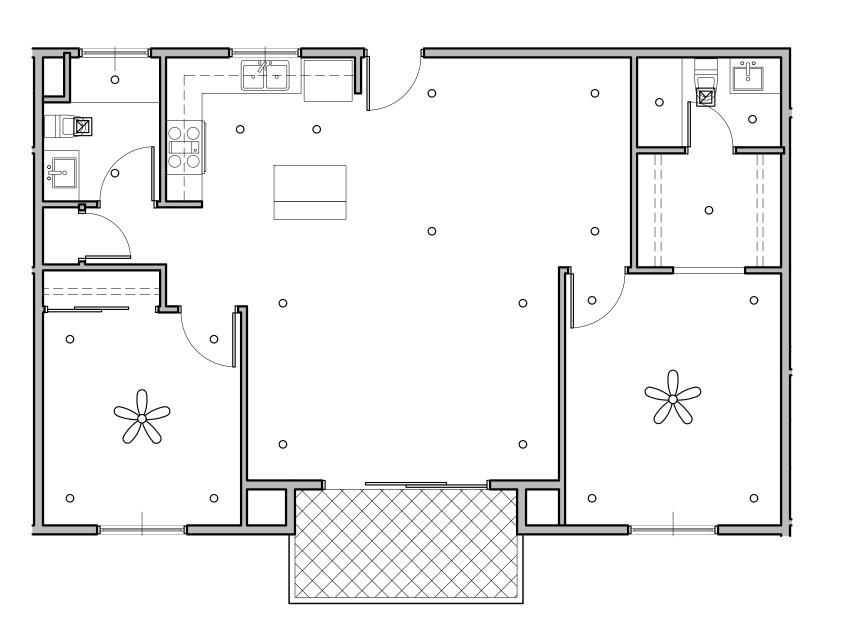

UNIT PLAN 205, 305 - REFLECTED CEILING PLAN

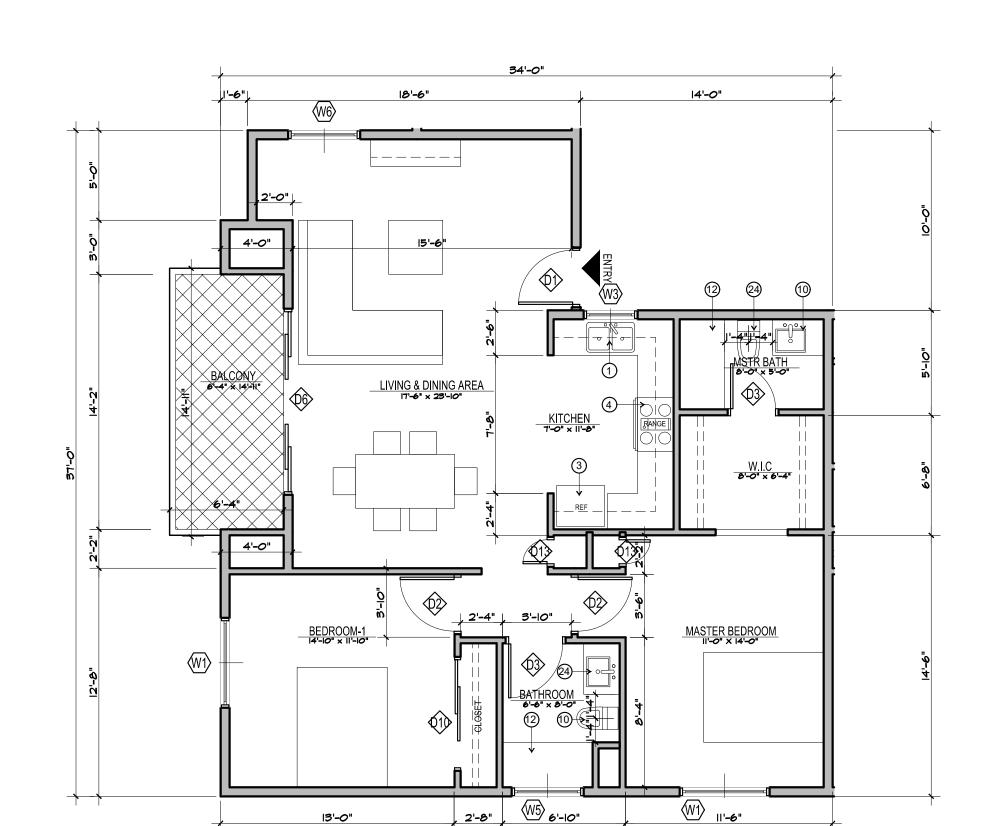

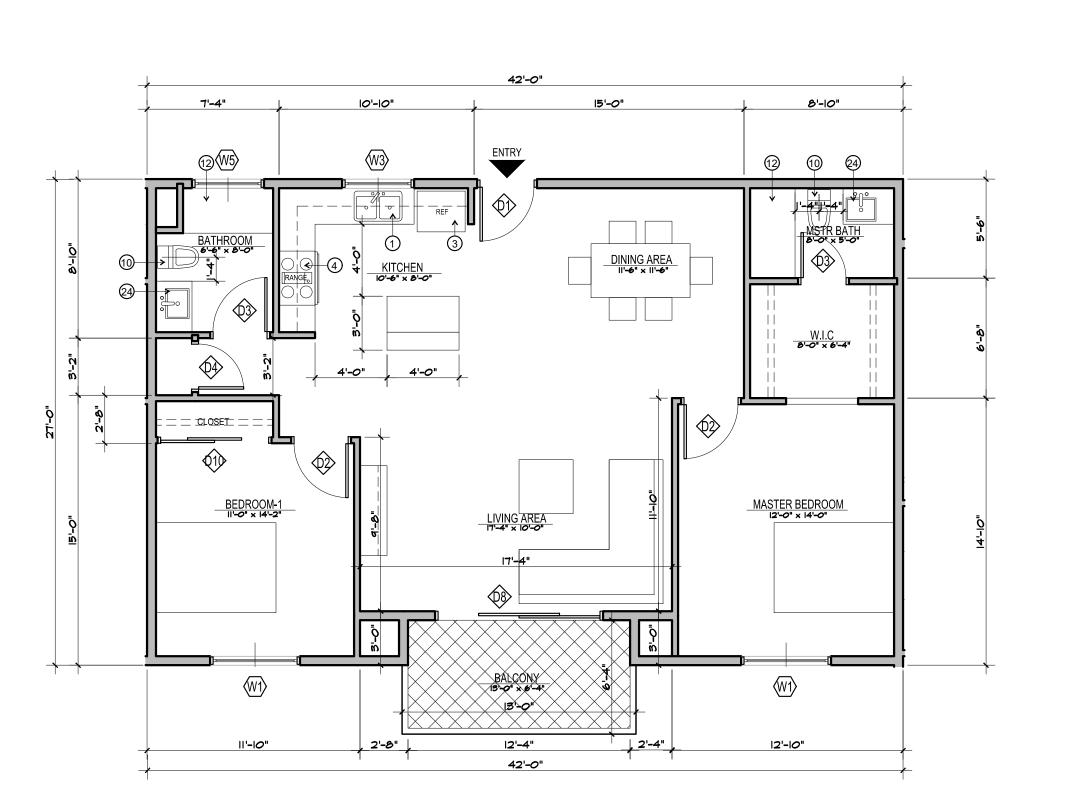

UNIT PLAN 204, 304 - REFLECTED CEILING PLAN

GENERAL NOTES

- 1. DWELLING UNITS ACCESSIBILITY, REFER TO SHEET A-
- . DWELLING UNITS ACCESSIBILITY, REFER TO SHEET A. COMMON AN PUBLIC AREAS ACCESSIBILITY, REFER TO SHEETS A- AND A-
- ALL TUB/SHOWER COMBOS WILL BE UTILIZED FIBERGLASS.
 WALLS ARE PERMITTED TO BE OF NON-RATED CONSTRUCTION EXCEPTS AS GRAPHICALLY NOTED ON BUILD GOVERNOUS FLOOR BY AND.
- COMPOSITE FLOOR PLANS.
 UNITS SHALL HAVE AT LEAST A MINIMUM LEAKAGE OF 0.30 CFM50 PER SQUARE FOOT OF ENCLOSURE.
- 6. WATER HEATER UNIT MODEL SEE PLUMBING SCHEDULE.
 7. RECESSED LIGHTING SHALL BE "BOXED IN" AT FIRE RATED FLOOR/CLG CONDITIONS
 8. DIMENSIONS ARE MEASURED FROM FACE OF STUD (FOS) UNLESS NOTED OTHERWISE.

UNIT PLAN LEGEND

ELEMENT	DESCRIPTION
TYPE A	5/8" GYPSUM BOAR - TAPE, TEXTURE AND PAINT - SATIN LEVEL FIN
TYPE B	5/8" GYPSUM BOAR - TAPE, TEXTURE AND PAINT - SEMI GLOSS LEVEL 4 FIN
TYPE C	EXTERIOR SOFFIT 5/8 " GYP BOARD TYPR X - TAPE, TEXTURE STUCCO FINISH
	LIMIT OF SOFFIT ABOVE - HEIGHT PER FLOOR PLAN. REFER TO DET 14 & 15/A
1/2"	FLOOR LEVEL AT DOORS SHALL NOT BE MORE THAN $\frac{1}{2}$ INCH LOWER THAN THRESHOLD AT THE DOORWAY PER C.B.C. SECTION 1008.1.6 AND 1132A. 4.1
HS C	FLOOR MATERIAL FLUSH TRANSITION
A A A	INTERIOR ELEVATION KEY
LIVING ROOM CARPET 9' - 0"	ROOM NAME FLOOR FINISH CEILING HEIGHT
(00)	DOOR NUMBER - REFER TO DOOR SCHEDULE
<u></u>	WINDOW TYPE - REFER TO WINDOW SCHEDULE
0	RECESSED LIGHT FIXTURE (AT AND IC RATED)
H	CEILING FAN
	SUPPLY AIR REGISTER
□ →→	SUPPLY AIR SIDE WALL REGISTER
	RETURN AIR REGISTER
	RETURN AIR SIDE WALL REGISTER
	EXHAUST AIR REGISTER / FAN - ENERGY STAR COMPLIANT - SEE MECH
<u>s</u>	SMOKE DETECTOR
<u>©</u>	CARBON MONOXIDE DETECTOR
(WA)	WALL TYPE SYMBOL SEE SCHEDULE ON SHEET A- AND A-

UNIT PLAN KEYNOTES

- 1 DOUBLE BOWL SINK W WITH GARAGE DISPOSAL & HOLE FOR DISHWASHER AIR GAP. PROVIDE ADAPTABLE REQUIREMENTS WHERE NOTED/REFER TO SCHEDULE OF FINISHES.
- 2 UNDER-COUNTER +/ 24" WIDE DISHWASHER (BOSCH 24" ADA OR APPROVED EQUAL. ENERGY STAR CERTIFIED). PROVIDE ADAPTABLE REQUIREMENTS. REFER TO SCHEDULE OF FINISHES.
- REFER TO SCHEDULE OF FINISHES.

 REFRIGERATOR SPACE. PROVIDE COLD WATER STUB-OUT IN RECESSED WALL BOX FOR ICE MAKER. PROVIDE
- 1-HR RATED WALL RECESS WHERE OCCURS IN 1-HR RATED WALL ASSEMBLY. PROVIDE ADAPTABLE REQUIREMENTS. REFER TO SCHEDULE OF FINISHES.
- FREE STANDING RANGE AND OVER THE RANGE MICROWAVE (BOTH ENERGY STAR CERTIFIED) -- VERIFY AND INSTALL APPLIANCES PER MANUFACTURER'S REQUIREMENTS. PROVIDE ADAPTABLE REQUIREMENTS. PROVIDE 15" BREADBOARD EA SIDE.
- (5) 24" DEEP BASE CABINET WITH COUNTERTOP
- 6 12" DEEP UPPER CABINET

3/16" = 1'-0"

- 7 ENERGY STAR WASHER AND DRYER STACKED
- VOID SPACE, FILL IN WITH INSULATION
 ULTRA-LOW FLUSH TOILET REFER TO DETAIL
- REQUIREMENTS
- (10) 32" x 60" TUB/SHOWER VERIFY UNIT DIMENSIONS WITH MANUFACTURER PRIOR TO FRAMING
- 11 RECESSED MEDICINE CABINET. PROVIDE 1- HR RATED WALL RECESS WHERE OCCURS IN 1 -HR RATED WALL ASSEMBLY
 (12) FUTURE 36" GRAB BAR. PROVIDE SOLID BLOCKING CONCEALED WITHIN WALL CENTERED ON BAR LOCATION
- (13) FUTURE 42" GRAB BAR. PROVIDE SOLID BLOCKING CONCEALED WITHIN WALL CENTERED ON BAR LOCATION
- (14) ELECTRIC PANEL REFER TO ELECTRICAL DRAWINGS FOR SOME INFORMATION POLE AND SHELF. LOCATE POLE 66" ABOVE FINISH FLOOR. PROVIDE 2x6 BLOCKING WITHIN
- 15) STUD BAY AT EACH END & CENTER OF POLE FOR POLE HARDWARE. VERIFY SHELF BRACKETS & PROVIDE
- (16) GRAB BAR
- (7) CEILING MOUNTED HORIZONTAL FAN COIL UNIT. (SEE MECHANICAL PLANS) VERIFY UNIT DIMENSIONS AND CLEARANCE REQUIREMENTS PRIOR TO FRAMING AND SETTING DROPPED CEILING HEIGHT. PROVIDE MINIMUM REQUIRED MANUFACTURE ACCESS PANEL COMPATIBLE WITH F.C.U. PAINT PANEL TO MATCH CEILING.
- METAL THRESHOLD. FLOOR LEVEL CHANGES GREATER THAN 4" AT DOORWAYS SHALL BE BEVELED OR SLOPED NOT GREATER THAN ONE UNIT VERTICAL IN TWO UNITS HORIZONTAL (50% SLOPE). REFER TO DETAILS AT ENTRY DOOR AT BALCONY SLIDING DOOR

 21240 Main Street Carson, CA 90745
- (19) UNIT DOOR BELL AT +48"AFF SEE ELEC
- 20 ACCESSIBLE COMPLIANT LAVATORY
- 21 UNIT SIGNAGE
- 22) WATER SUB METER AT HIGH LEVEL INSIDE CEILING SPACE WITH CEILING ACCESS SEE PLUMBING
- DUAL REMOTE WATER METER DISPLAY. MOUNT HT. AT 4' 0". ABOVE FINISH FLOOR TO TOP OF DISPLAY
 15" MIN. BREADBOARD
- 25 ENERGY STAR TANKLESS WATER HEATER. SEE PLUMBING DRAWINGS.
- VERIFY REQUIRED CLI
 (26) SMOKE DETECTOR
- 27 CARBON MONOXIDE DETECTOR
- 42" HIGH GUARD RAIL REFER TO EXTERIOR ELEVATIONS.
 EXTERIOR LOW WALL REFER TO EXTERIOR ELEVATION
- (30) 1HR RATED SHAFT CONTRACTOR TO VERIFY WITH MECHANICAL DRAWINGS
- (31) EXTERIOR EXHAUST LOUVER SEE MECHANICAL
- 32 GUTTER
- 33 SCUPPER
 34 CEILING BREAK

SCALE

- (35) 2" WIDE PVC SOFFIT VENT SEE DETAIL
- 36) NOT USED



2173 LOMITA BLVD. #201 LOMITA CALIFORNIA 90717

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/ner :

NANCY KIM

21240 MAIN STREET & 21250 MAIN STREET

PROJECT INFORMATION:

CARSON APARTMENTS
21240 Main Street Carson, CA 90745

LEGAL DESCRIPTION
APN: 7334-002-007

APN: 7334-002-008



Rev.#	Date/Issue	Notes	
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Sheet Title :
BUILDING A-

Scale:
AS NOTED

Date: Aug2021

Drawn: grkihgus


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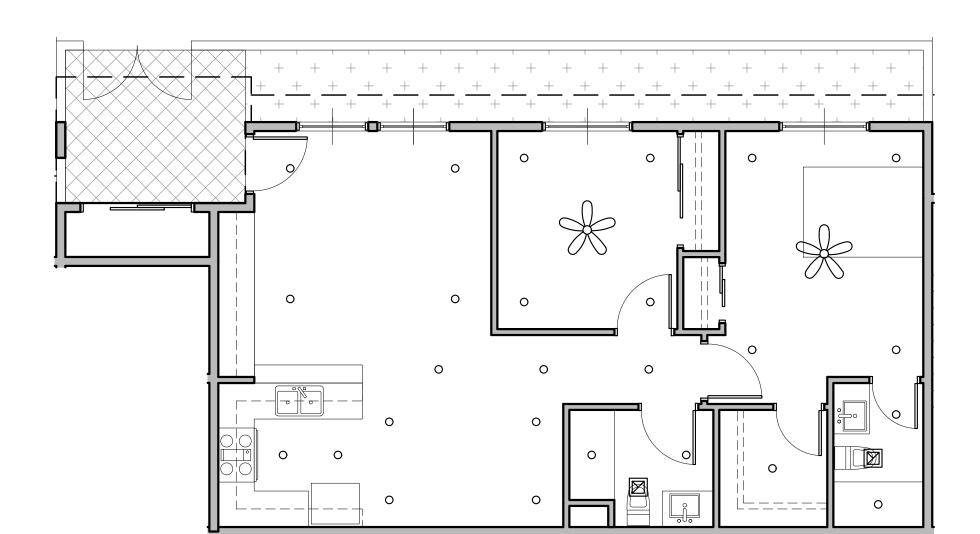
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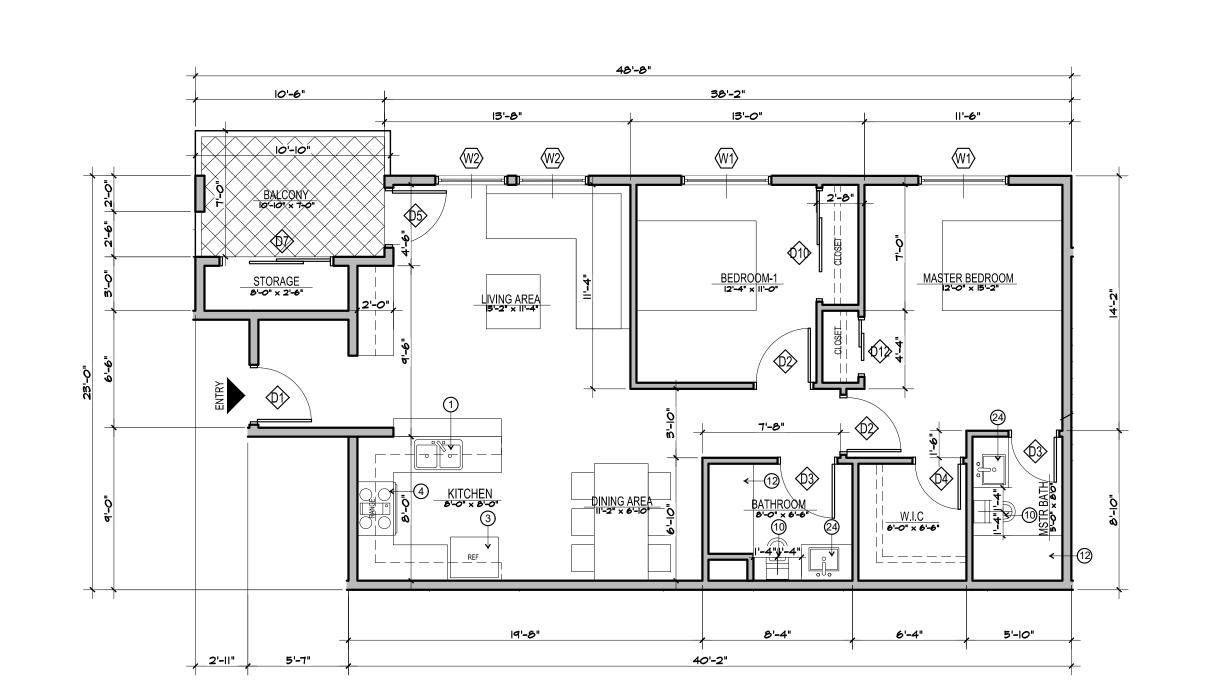
UNIT PLANS






UNIT PLAN 201, 301 - REFLECTED CEILING PLAN

UNIT PLAN 101 - REFLECTED CEILING PLAN

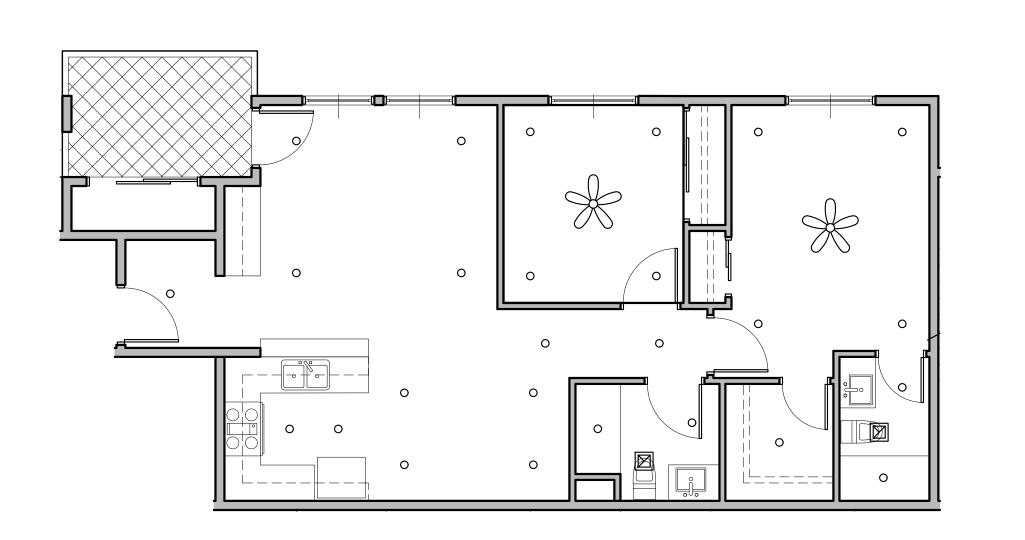

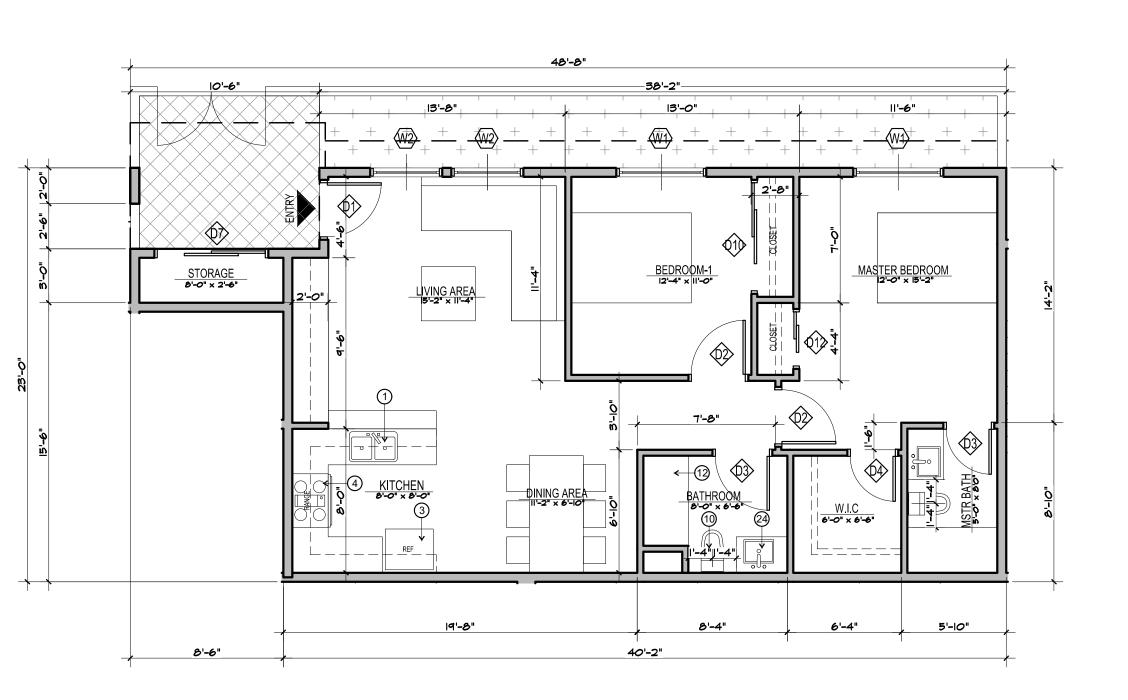

GENERAL NOTES

- COMMON AN PUBLIC AREAS ACCESSIBILITY, REFER TO SHEETS A- AND A-
- ALL TUB/SHOWER COMBOS WILL BE UTILIZED FIBERGLASS. . WALLS ARE PERMITTED TO BE OF NON-RATED CONSTRUCTION EXCEPTS AS GRAPHICALLY NOTED ON BUI COMPOSITE FLOOR PLANS.
- UNITS SHALL HAVE AT LEAST A MINIMUM LEAKAGE OF 0.30 CFM50 PER SQUARE FOOT OF ENCLOSURE.
 WATER HEATER UNIT MODEL SEE PLUMBING SCHEDULE.
- RECESSED LIGHTING SHALL BE "BOXED IN" AT FIRE RATED FLOOR/CLG CONDITIONS 3. DIMENSIONS ARE MEASURED FROM FACE OF STUD (FOS) UNLESS NOTED OTHERWISE.

ELEMENT	DESCRIPTION
TYPE A	5/8" GYPSUM BOAR - TAPE, TEXTURE AND PAINT - SATIN LEVEL FIN
TYPE B	5/8" GYPSUM BOAR - TAPE, TEXTURE AND PAINT - SEMI GLOSS LEVEL 4 FIN
TYPE C	EXTERIOR SOFFIT 5/8 " GYP BOARD TYPR X - TAPE, TEXTURE STUCCO FINISH
	LIMIT OF SOFFIT ABOVE - HEIGHT PER FLOOR PLAN. REFER TO DET 14 & 15/A
1/2"	FLOOR LEVEL AT DOORS SHALL NOT BE MORE THAN $\frac{1}{2}$ INCH LOWER THAN THRESHOLD AT THE DOORWAY PER C.B.C. SECTION 1008.1.6 AND 1132A. 4.1
HS C	FLOOR MATERIAL FLUSH TRANSITION
A A A	INTERIOR ELEVATION KEY
LIVING ROOM CARPET 9'-0"	ROOM NAME FLOOR FINISH CEILING HEIGHT
00>	DOOR NUMBER - REFER TO DOOR SCHEDULE
00	WINDOW TYPE - REFER TO WINDOW SCHEDULE
0	RECESSED LIGHT FIXTURE (AT AND IC RATED)
	CEILING FAN
	SUPPLY AIR REGISTER
□ →→	SUPPLY AIR SIDE WALL REGISTER
	RETURN AIR REGISTER
	RETURN AIR SIDE WALL REGISTER
	EXHAUST AIR REGISTER / FAN - ENERGY STAR COMPLIANT - SEE MECH
©	SMOKE DETECTOR

UNIT PLAN KEYNOTES

DOUBLE BOWL SINK W WITH GARAGE DISPOSAL & HOLE FOR DISHWASHER AIR GAP. PROVIDE ADAPTABLE REQUIREMENTS WHERE NOTED/REFER TO SCHEDULE OF FINISHES.

CARBON MONOXIDE DETECTOR

- UNDER-COUNTER $\pm 1/2$ WIDE DISHWASHER (BOSCH 24" ADA OR APPROVED EQUAL. ENERGY STAR CERTIFIED). PROVIDE ADAPTABLE REQUIREMENTS. REFER TO SCHEDULE OF FINISHES.
- REFRIGERATOR SPACE. PROVIDE COLD WATER STUB-OUT IN RECESSED WALL BOX FOR ICE MAKER. PROVIDE

WALL TYPE SYMBOL. - SEE SCHEDULE ON SHEET A- AND A-

- 1-HR RATED WALL RECESS WHERE OCCURS IN 1-HR RATED WALL ASSEMBLY. PROVIDE ADAPTABLE REQUIREMENTS. REFER TO SCHEDULE OF FINISHES. FREE STANDING RANGE AND OVER THE RANGE MICROWAVE (BOTH ENERGY STAR CERTIFIED) -- VERIFY AND
- INSTALL APPLIANCES PER MANUFACTURER'S REQUIREMENTS. PROVIDE ADAPTABLE REQUIREMENTS. PROVIDE
- 5 24" DEEP BASE CABINET WITH COUNTERTOP
- 6 12" DEEP UPPER CABINET
- 7) ENERGY STAR WASHER AND DRYER STACKED 8 VOID SPACE, FILL IN WITH INSULATION
- ULTRA-LOW FLUSH TOILET REFER TO DETAIL FOR ACCESSIBILITY REQUIREMENTS
- 10) 32" x 60" TUB/SHOWER VERIFY UNIT DIMENSIONS WITH MANUFACTURER
- RECESSED MEDICINE CABINET. PROVIDE 1- HR RATED WALL RECESS WHERE OCCURS IN 1 -HR RATED WALL
- FUTURE 36" GRAB BAR. PROVIDE SOLID BLOCKING CONCEALED WITHIN WALL CENTERED ON BAR LOCATION FUTURE 42" GRAB BAR. PROVIDE SOLID BLOCKING CONCEALED WITHIN WALL CENTERED ON BAR LOCATION
- 4) ELECTRIC PANEL REFER TO ELECTRICAL DRAWINGS FOR SOME INFORMATION POLE AND SHELF. LOCATE POLE 66" ABOVE FINISH FLOOR. PROVIDE 2x6 BLOCKING WITHIN
-) STUD BAY AT EACH END & CENTER OF POLE FOR POLE HARDWARE. VERIFY SHELF BRACKETS & PROVIDE

SCALE

3/16" = 1'-0"

- CEILING MOUNTED HORIZONTAL FAN COIL UNIT. (SEE MECHANICAL PLANS) VERIFY UNIT DIMENSIONS AND CLEARANCE REQUIREMENTS PRIOR TO FRAMING AND SETTING DROPPED CEILING HEIGHT. PROVIDE MINIMUM REQUIRED MANUFACTURE ACCESS PANEL COMPATIBLE WITH F.C.U. PAINT PANEL TO MATCH CEILING.
- METAL THRESHOLD. FLOOR LEVEL CHANGES GREATER THAN 1/4" AT DOORWAYS SHALL BE BEVELED OR SLOP NOT GREATER THAN ONE UNIT VERTICAL IN TWO UNITS HORIZONTAL (50% SLOPE). REFER TO DETAILS AT ENTRY DOOR
- (19) UNIT DOOR BELL AT +48"AFF SEE ELEC
- (20) ACCESSIBLE COMPLIANT LAVATORY
- (21) UNIT SIGNAGE
- (22) WATER SUB METER AT HIGH LEVEL INSIDE CEILING SPACE WITH CEILING ACCESS SEE PLUMBING
- 23) DUAL REMOTE WATER METER DISPLAY. MOUNT HT. AT 4' 0". ABOVE FINISH FLOOR TO TOP OF DISPLAY (24) 15" MIN. BREADBOARD
- 25) ENERGY STAR TANKLESS WATER HEATER. SEE PLUMBING DRAWINGS. VERIFY REQUIRED CLEARANCES WITH MFR PRIOR TO FRAMING
- 26) SMOKE DETECTOR
- (27) CARBON MONOXIDE DETECTOR
- (28) 42" HIGH GUARD RAIL REFER TO EXTERIOR ELEVATIONS. (29) EXTERIOR LOW WALL - REFER TO EXTERIOR ELEVATION
- (30) 1HR RATED SHAFT CONTRACTOR TO VERIFY WITH MECHANICAL DRAWINGS
- (31) EXTERIOR EXHAUST LOUVER SEE MECHANICAL
- (32) GUTTER
- (33) SCUPPER
- (34) CEILING BREAK
- (35) 2" WIDE PVC SOFFIT VENT SEE DETAIL
- (36) NOT USED



Architect:

2173 LOMITA BLVD. #201 LOMITA CALIFORNIA 90717

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NANCY KIM


MAIN STREET & 21250 21240 MAIN STREE

PROJECT INFORMATION:

CARSON APARTMENTS

21240 Main Street Carson, CA 90745 21250 Main Street Carson, CA 90745

LEGAL DESCRIPTION APN: 7334-002-007 APN: 7334-002-008

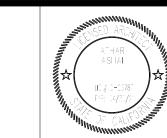

Rev.#	# Date/Issue	Notes	
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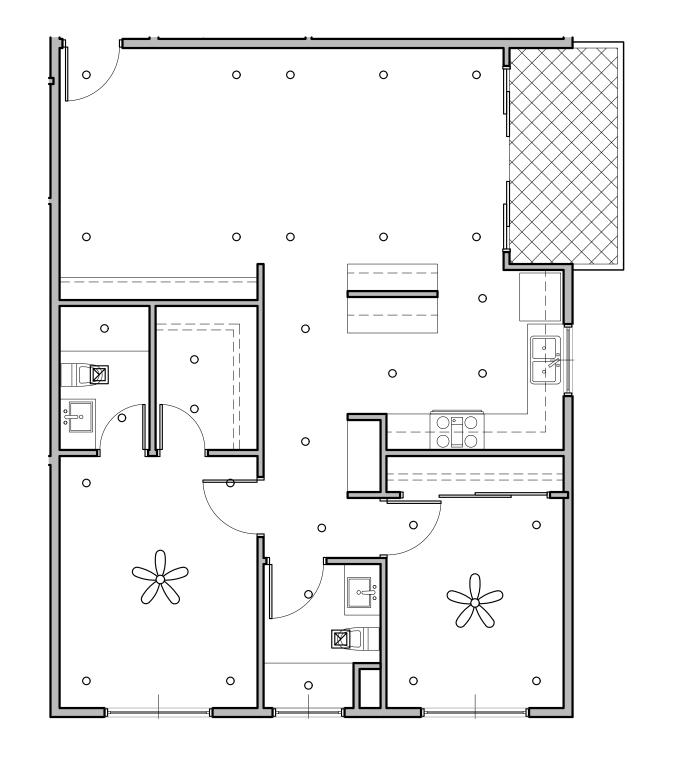
BUILDING B-UNIT PLANS


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UNIT PLAN 201, 301 - FLOOR PLAN

UNIT PLAN 101 - FLOOR PLAN


SCALE 3/16" = 1'-0"



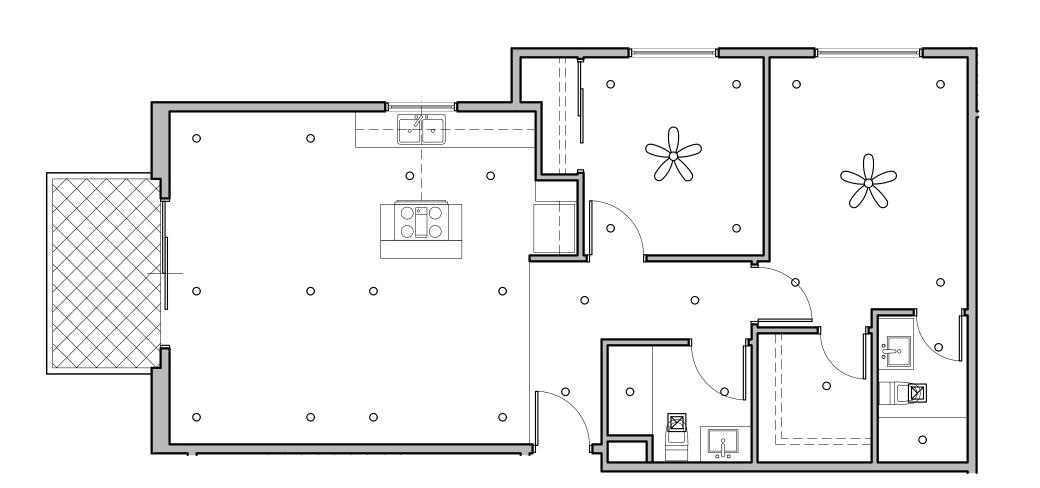


UNIT PLAN 203 - REFLECTED CEILING PLAN

UNIT PLAN 203 - FLOOR PLAN

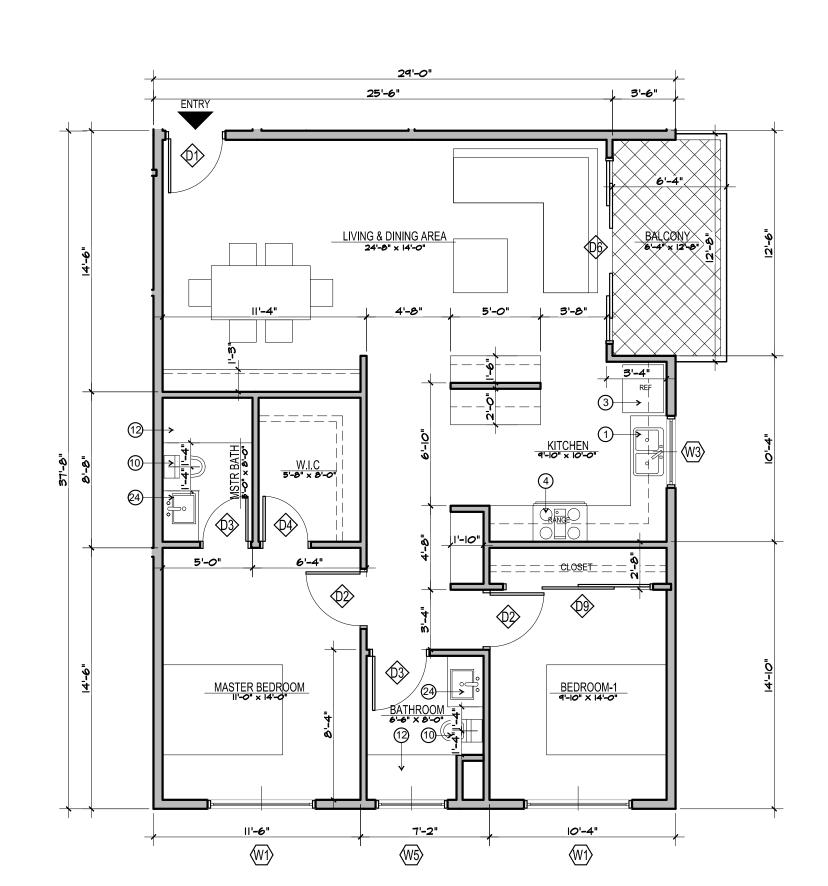

UNIT PLAN 202, 302 - REFLECTED CEILING PLAN

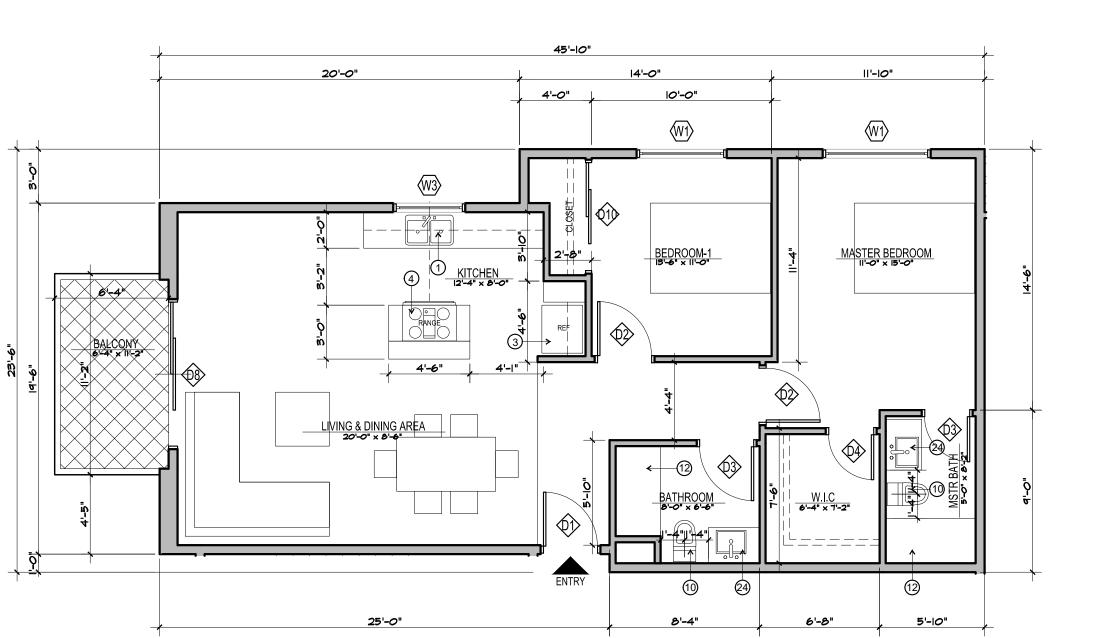

GENERAL NOTES

- DWELLING UNITS ACCESSIBILITY, REFER TO SHEET A-
- COMMON AN PUBLIC AREAS ACCESSIBILITY, REFER TO SHEETS A- AND AALL TUB/SHOWER COMBOS WILL BE UTILIZED FIBERGLASS.
- WALLS ARE PERMITTED TO BE OF NON-RATED CONSTRUCTION EXCEPTS AS GRAPHICALLY NOTED ON BUIL COMPOSITE FLOOR PLANS. UNITS SHALL HAVE AT LEAST A MINIMUM LEAKAGE OF 0.30 CFM50 PER SQUARE FOOT OF ENCLOSURE.
- WATER HEATER UNIT MODEL SEE PLUMBING SCHEDULE. RECESSED LIGHTING SHALL BE "BOXED IN" AT FIRE RATED FLOOR/CLG CONDITIONS DIMENSIONS ARE MEASURED FROM FACE OF STUD (FOS) UNLESS NOTED OTHERWISE.

NIT PL	AN LEGEND
ELEMENT	DESCRIPTION
TYPE A	5/8" GYPSUM BOAR - TAPE, TEXTURE AND PAINT - SATIN LEVEL FIN
TYPE B	5/8" GYPSUM BOAR - TAPE, TEXTURE AND PAINT - SEMI GLOSS LEVEL 4 FIN
TYPE C	EXTERIOR SOFFIT 5/8 " GYP BOARD TYPR X - TAPE, TEXTURE STUCCO FINISH
	LIMIT OF SOFFIT ABOVE - HEIGHT PER FLOOR PLAN. REFER TO DET 14 & 15/A
1 / 2"	FLOOR LEVEL AT DOORS SHALL NOT BE MORE THAN $\frac{1}{2}$ INCH LOWER THAN THRESHOLD AT THE DOORWAY PER C.B.C. SECTION 1008.1.6 AND 1132A. 4.1
HS C	FLOOR MATERIAL FLUSH TRANSITION
$A \bigoplus_{\Delta} A$	INTERIOR ELEVATION KEY
IVING ROOM CARPET 9' - 0"	ROOM NAME — FLOOR FINISH — CEILING HEIGHT
(00)	DOOR NUMBER - REFER TO DOOR SCHEDULE
	WINDOW TYPE - REFER TO WINDOW SCHEDULE
0	RECESSED LIGHT FIXTURE (AT AND IC RATED)
	CEILING FAN
\boxtimes	SUPPLY AIR REGISTER
	SUPPLY AIR SIDE WALL REGISTER
	RETURN AIR REGISTER
	RETURN AIR SIDE WALL REGISTER
	EXHAUST AIR REGISTER / FAN - ENERGY STAR COMPLIANT - SEE MECH
(SD)	SMOKE DETECTOR
<u> </u>	CARBON MONOXIDE DETECTOR

UNIT PLAN KEYNOTES

- DOUBLE BOWL SINK W WITH GARAGE DISPOSAL & HOLE FOR DISHWASHER AIR GAP. PROVIDE ADAPTABLE REQUIREMENTS WHERE NOTED/ REFER TO SCHEDULE OF FINISHES.
- UNDER-COUNTER +/ 24" WIDE DISHWASHER (BOSCH 24" ADA OR APPROVED EQUAL. ENERGY STAR CERTIFIED). PROVIDE ADAPTABLE REQUIREMENTS. REFER TO SCHEDULE OF FINISHES.
- REFRIGERATOR SPACE. PROVIDE COLD WATER STUB-OUT IN RECESSED WALL BOX FOR ICE MAKER. PROVIDE 1-HR RATED WALL RECESS WHERE OCCURS IN 1-HR RATED WALL ASSEMBLY. PROVIDE ADAPTABLE REQUIREMENTS. REFER TO SCHEDULE OF FINISHES.

WALL TYPE SYMBOL. - SEE SCHEDULE ON SHEET A- AND A-

- FREE STANDING RANGE AND OVER THE RANGE MICROWAVE (BOTH ENERGY STAR CERTIFIED) -- VERIFY AND INSTALL APPLIANCES PER MANUFACTURER'S REQUIREMENTS. PROVIDE ADAPTABLE REQUIREMENTS. PROVIDE
- (5) 24" DEEP BASE CABINET WITH COUNTERTOP
- 6) 12" DEEP UPPER CABINET

3/16" = 1'-0"

- 7) ENERGY STAR WASHER AND DRYER STACKED 8 VOID SPACE, FILL IN WITH INSULATION
- (9) ULTRA-LOW FLUSH TOILET REFER TO DETAIL FOR ACCESSIBILITY
- (10) 32" x 60" TUB/SHOWER VERIFY UNIT DIMENSIONS WITH MANUFACTURER PRIOR TO FRAMING
- RECESSED MEDICINE CABINET. PROVIDE 1- HR RATED WALL RECESS WHERE OCCURS IN 1 -HR RATED WALL
- FUTURE 36" GRAB BAR. PROVIDE SOLID BLOCKING CONCEALED WITHIN WALL CENTERED ON BAR LOCATION (13) FUTURE 42" GRAB BAR. PROVIDE SOLID BLOCKING CONCEALED WITHIN WALL CENTERED ON BAR LOCATION
- 14) ELECTRIC PANEL REFER TO ELECTRICAL DRAWINGS FOR SOME INFORMATION
- STUD BAY AT EACH END & CENTER OF POLE FOR POLE HARDWARE. VERIFY SHELF BRACKETS & PROVIDE
- CONCEALED 2x BLOCKING ACCORDINGLY.
 - CEILING MOUNTED HORIZONTAL FAN COIL UNIT. (SEE MECHANICAL PLANS) VERIFY UNIT DIMENSIONS AND CLEARANCE REQUIREMENTS PRIOR TO FRAMING AND SETTING DROPPED CEILING HEIGHT. PROVIDE MINIMUM REQUIRED MANUFACTURE ACCESS PANEL COMPATIBLE WITH F.C.U. PAINT PANEL TO MATCH CEILING.
 - 8 METAL THRESHOLD. FLOOR LEVEL CHANGES GREATER THAN $\frac{1}{4}$ " AT DOORWAYS SHALL BE BEVELED OR SLOPE NOT GREATER THAN ONE UNIT VERTICAL IN TWO UNITS HORIZONTAL (50% SLOPE). REFER TO DETAILS AT ENTRY DOOR AT BALCONY SLIDING DOOR AT ENTRY DOOR AT BALCONY SLIDING DOOR
 - (19) UNIT DOOR BELL AT +48"AFF SEE ELEC
- (20) ACCESSIBLE COMPLIANT LAVATORY
- (21) UNIT SIGNAGE
- (22) WATER SUB METER AT HIGH LEVEL INSIDE CEILING SPACE WITH CEILING ACCESS SEE PLUMBING DUAL REMOTE WATER METER DISPLAY. MOUNT HT. AT 4' - 0". ABOVE FINISH FLOOR TO TOP OF DISPLAY
- (24) 15" MIN. BREADBOARD
- ENERGY STAR TANKLESS WATER HEATER. SEE PLUMBING DRAWINGS. VERIFY REQUIRED CLEARANCES WITH MFR PRIOR TO FRAMING
- (26) SMOKE DETECTOR
- (27) CARBON MONOXIDE DETECTOR
- 28) 42" HIGH GUARD RAIL REFER TO EXTERIOR ELEVATIONS. (29) EXTERIOR LOW WALL - REFER TO EXTERIOR ELEVATION
- (30) 1HR RATED SHAFT CONTRACTOR TO VERIFY WITH MECHANICAL DRAWINGS
- (31) EXTERIOR EXHAUST LOUVER SEE MECHANICAL
- (32) GUTTER
- (33) SCUPPER
- (34) CEILING BREAK
- (35) 2" WIDE PVC SOFFIT VENT SEE DETAIL
- (36) NOT USED

SCALE

3/16" = 1'-0"



2173 LOMITA BLVD. #201 LOMITA CALIFORNIA 90717

Architect:

ART ASHAI, AIA 2173 LOMITA BLVD. #201

LOMITA CALIFORNIA 90717 PHONE: 424-263-5888 email: artashai@gmail.com

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NANCY KIM

MAIN STREET 8 21250 21240 MAIN STREE


PROJECT INFORMATION:

21250 Main Street Carson, CA 90745

CARSON APARTMENTS 21240 Main Street Carson, CA 90745

LEGAL DESCRIPTION

APN: 7334-002-007 APN: 7334-002-008

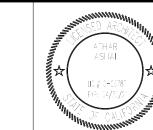

Rev.#	Date/Issue	Notes	
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BUILDING B-UNIT PLANS

AS NOTED J-1908 Date: Aug2021 Sheet Number: Drawn: arkihaus Check'd: CTV/RRJ

UNIT PLAN 202, 302 - FLOOR PLAN



GENERAL NOTES

- DWELLING UNITS ACCESSIBILITY, REFER TO SHEET A-
- COMMON AN PUBLIC AREAS ACCESSIBILITY, REFER TO SHEETS A- AND A-
- ALL TUB/SHOWER COMBOS WILL BE UTILIZED FIBERGLASS.
 WALLS ARE PERMITTED TO BE OF NON-RATED CONSTRUCTION EXCEPTS AS GRAPHICALLY NOTED ON BUIL
- COMPOSITE FLOOR PLANS. 5. UNITS SHALL HAVE AT LEAST A MINIMUM LEAKAGE OF 0.30 CFM50 PER SQUARE FOOT OF ENCLOSURE.
- 6. WATER HEATER UNIT MODEL SEE PLUMBING SCHEDULE. RECESSED LIGHTING SHALL BE "BOXED IN" AT FIRE RATED FLOOR/CLG CONDITIONS 8. DIMENSIONS ARE MEASURED FROM FACE OF STUD (FOS) UNLESS NOTED OTHERWISE.

NIT PL	AN LEGEND	
ELEMENT	DESCRIPTION	
YPE A	5/8" GYPSUM BOAR - TAPE, TEXTURE AND PAINT - SATIN LEVEL FIN	2 1 7 3 LOMITA BLVD. # 2 0 1
ТҮРЕ В	5/8" GYPSUM BOAR - TAPE, TEXTURE AND PAINT - SEMI GLOSS LEVEL 4 FIN	LOMITA CALIFORNIA 90717
YPE C	EXTERIOR SOFFIT 5/8 " GYP BOARD TYPR X - TAPE, TEXTURE STUCCO FINISH	Architect:
	LIMIT OF SOFFIT ABOVE - HEIGHT PER FLOOR PLAN. REFER TO DET 14 & 15/A-	Ardinect.
1 / 2"	FLOOR LEVEL AT DOORS SHALL NOT BE MORE THAN $\frac{1}{2}$ INCH LOWER THAN THRESHOLD AT THE DOORWAY PER C.B.C. SECTION 1008.1.6 AND 1132A. 4.1	ART ASHAI, AIA
HS C	FLOOR MATERIAL FLUSH TRANSITION	2173 LOMITA BLVD. #201
Å A	INTERIOR ELEVATION KEY	LOMITA CALIFORNIA 90717 PHONE: 424-263-5888
ING ROOM CARPET 9'-0"	ROOM NAME FLOOR FINISH CEILING HEIGHT	email: artashai@gmail.com
00	DOOR NUMBER - REFER TO DOOR SCHEDULE	
	WINDOW TYPE - REFER TO WINDOW SCHEDULE	Copyright:
0	RECESSED LIGHT FIXTURE (AT AND IC RATED)	This drawing is the property of DESIGNER, and it is not to be reproduced or copied in whole or
H	CEILING FAN	part. It is not to be used for any other project and is to be returned upon request. The DESIGNER retains all copyrights for this document.
\boxtimes	SUPPLY AIR REGISTER	Owner:
 →→	SUPPLY AIR SIDE WALL REGISTER	NANCY KIM
	RETURN AIR REGISTER	-
	RETURN AIR SIDE WALL REGISTER	
	EXHAUST AIR REGISTER / FAN - ENERGY STAR COMPLIANT - SEE MECH	
(SD)	SMOKE DETECTOR	
<u>©</u>	CARBON MONOXIDE DETECTOR	
(WA)	WALL TYPE SYMBOL SEE SCHEDULE ON SHEET A AND A	

UNIT PLAN KEYNOTES

- DOUBLE BOWL SINK W WITH GARAGE DISPOSAL & HOLE FOR DISHWASHER AIR GAP. PROVIDE ADAPTABLE REQUIREMENTS WHERE NOTED/ REFER TO SCHEDULE OF FINISHES.
- UNDER-COUNTER +/ 24" WIDE DISHWASHER (BOSCH 24" ADA OR APPROVED EQUAL. ENERGY STAR CERTIFIED). PROVIDE ADAPTABLE REQUIREMENTS. REFER TO SCHEDULE OF FINISHES.
- REFRIGERATOR SPACE. PROVIDE COLD WATER STUB-OUT IN RECESSED WALL BOX FOR ICE MAKER. PROVIDE
- 1-HR RATED WALL RECESS WHERE OCCURS IN 1-HR RATED WALL ASSEMBLY. PROVIDE ADAPTABLE REQUIREMENTS. REFER TO SCHEDULE OF FINISHES.

FREE STANDING RANGE AND OVER THE RANGE MICROWAVE (BOTH ENERGY STAR CERTIFIED) - VERIFY AND INSTALL APPLIANCES PER MANUFACTURER'S REQUIREMENTS. PROVIDE ADAPTABLE REQUIREMENTS. PROVIDE

- 5 24" DEEP BASE CABINET WITH COUNTERTOP 6 12" DEEP UPPER CABINET
- (7) ENERGY STAR WASHER AND DRYER -- STACKED
- (8) VOID SPACE, FILL IN WITH INSULATION 9 ULTRA-LOW FLUSH TOILET - REFER TO DETAIL FOR ACCESSIBILITY REQUIREMENTS
- (10) 32" x 60" TUB/SHOWER VERIFY UNIT DIMENSIONS WITH MANUFACTURER
- PRIOR TO FRAMING RECESSED MEDICINE CABINET. PROVIDE 1- HR RATED WALL RECESS WHERE OCCURS IN 1-HR RATED WALL
- FUTURE 36" GRAB BAR. PROVIDE SOLID BLOCKING CONCEALED WITHIN WALL CENTERED ON BAR LOCATION
- FUTURE 42" GRAB BAR. PROVIDE SOLID BLOCKING CONCEALED WITHIN WALL CENTERED ON BAR LOCATION
- (14) ELECTRIC PANEL REFER TO ELECTRICAL DRAWINGS FOR SOME INFORMATION POLE AND SHELF. LOCATE POLE 66" ABOVE FINISH FLOOR. PROVIDE 2x6 BLOCKING WITHIN
- 5) STUD BAY AT EACH END & CENTER OF POLE FOR POLE HARDWARE. VERIFY SHELF BRACKETS & PROVIDE CONCEALED 2x BLOCKING ACCORDINGLY.

- 7) CEILING MOUNTED HORIZONTAL FAN COIL UNIT. (SEE MECHANICAL PLANS) VERIFY UNIT DIMENSIONS AND CLEARANCE REQUIREMENTS PRIOR TO FRAMING AND SETTING DROPPED CEILING HEIGHT. PROVIDE MINIMUM
- REQUIRED MANUFACTURE ACCESS PANEL COMPATIBLE WITH F.C.U. PAINT PANEL TO MATCH CEILING. 18) METAL THRESHOLD. FLOOR LEVEL CHANGES GREATER THAN 4" AT DOORWAYS SHALL BE BEVELED OR SLOPE NOT GREATER THAN ONE UNIT VERTICAL IN TWO UNITS
 HORIZONTAL (50% SLOPE). REFER TO DETAILS AT ENTRY DOOR AT BALCONY SLIDING DOOR
- (19) UNIT DOOR BELL AT +48"AFF SEE ELEC
- (20) ACCESSIBLE COMPLIANT LAVATORY
- (21) UNIT SIGNAGE
- (22) WATER SUB METER AT HIGH LEVEL INSIDE CEILING SPACE WITH CEILING ACCESS SEE PLUMBING 23) DUAL REMOTE WATER METER DISPLAY. MOUNT HT. AT 4' - 0". ABOVE FINISH FLOOR TO TOP OF DISPLAY
- (24) 15" MIN. BREADBOARD
- (25) ENERGY STAR TANKLESS WATER HEATER. SEE PLUMBING DRAWINGS. VERIFY REQUIRED CLEARANCES WITH MFR PRIOR TO FRAMING
- (26) SMOKE DETECTOR
- (27) CARBON MONOXIDE DETECTOR
- (28) 42" HIGH GUARD RAIL REFER TO EXTERIOR ELEVATIONS.
- (29) EXTERIOR LOW WALL REFER TO EXTERIOR ELEVATION (30) 1HR RATED SHAFT - CONTRACTOR TO VERIFY WITH MECHANICAL DRAWINGS
- (31) EXTERIOR EXHAUST LOUVER SEE MECHANICAL
- 32) GUTTER
- 33) SCUPPER
- (34) CEILING BREAK
- (35) 2" WIDE PVC SOFFIT VENT SEE DETAIL
- (36) NOT USED



MAIN STREET & 21250 21240 MAIN STREE


PROJECT INFORMATION:

21250 Main Street Carson, CA 90745

CARSON APARTMENTS 21240 Main Street Carson, CA 90745

LEGAL DESCRIPTION APN: 7334-002-007


APN: 7334-002-008

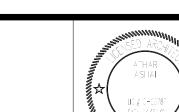


Rev.#	Date/Issue	Notes	
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Sheet Title : **BUILDING B-UNIT PLANS**

Scale : AS NOTED	Job Number : J-1908
Date: Aug2021	Sheet Number :
Drawn: arkihaus	Δ-123
Check'd: CTV/RRJ	



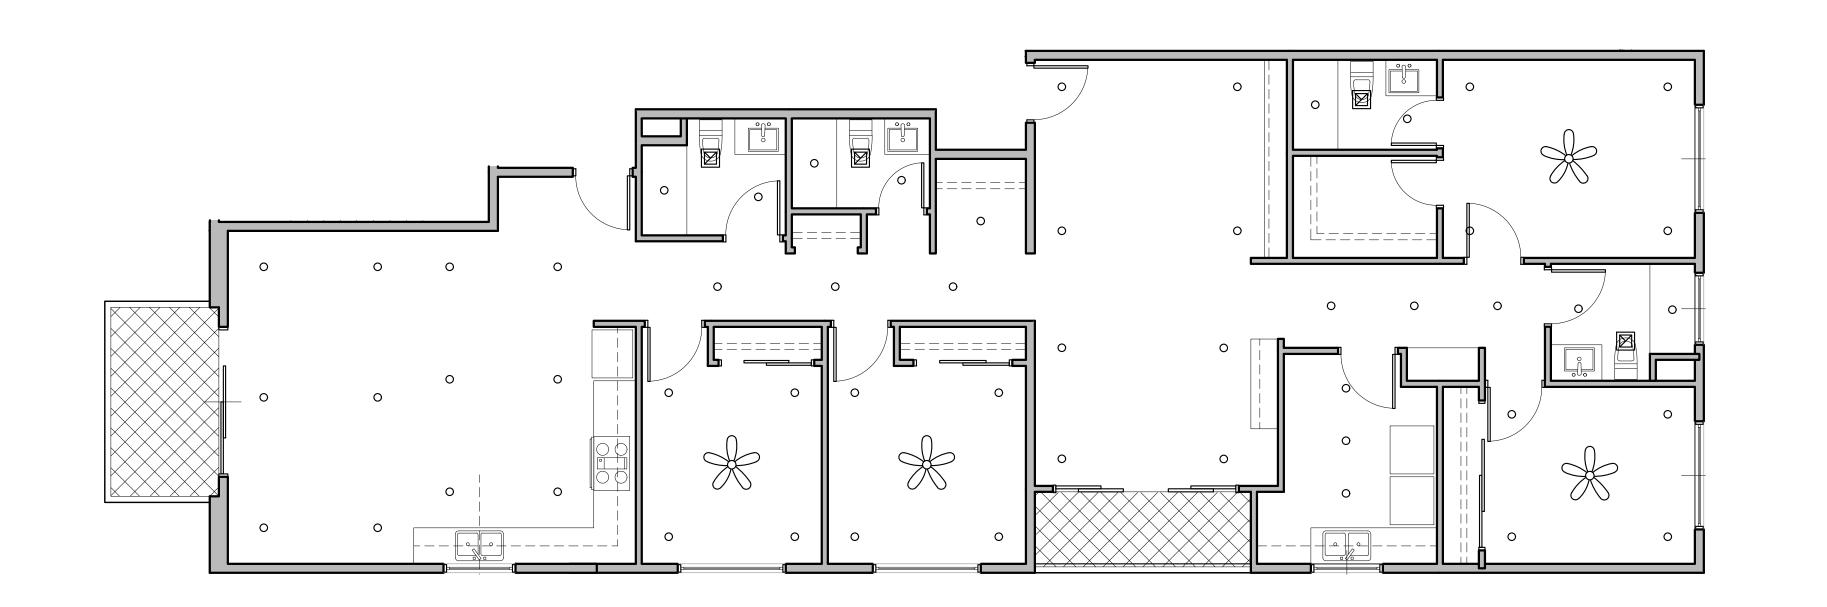

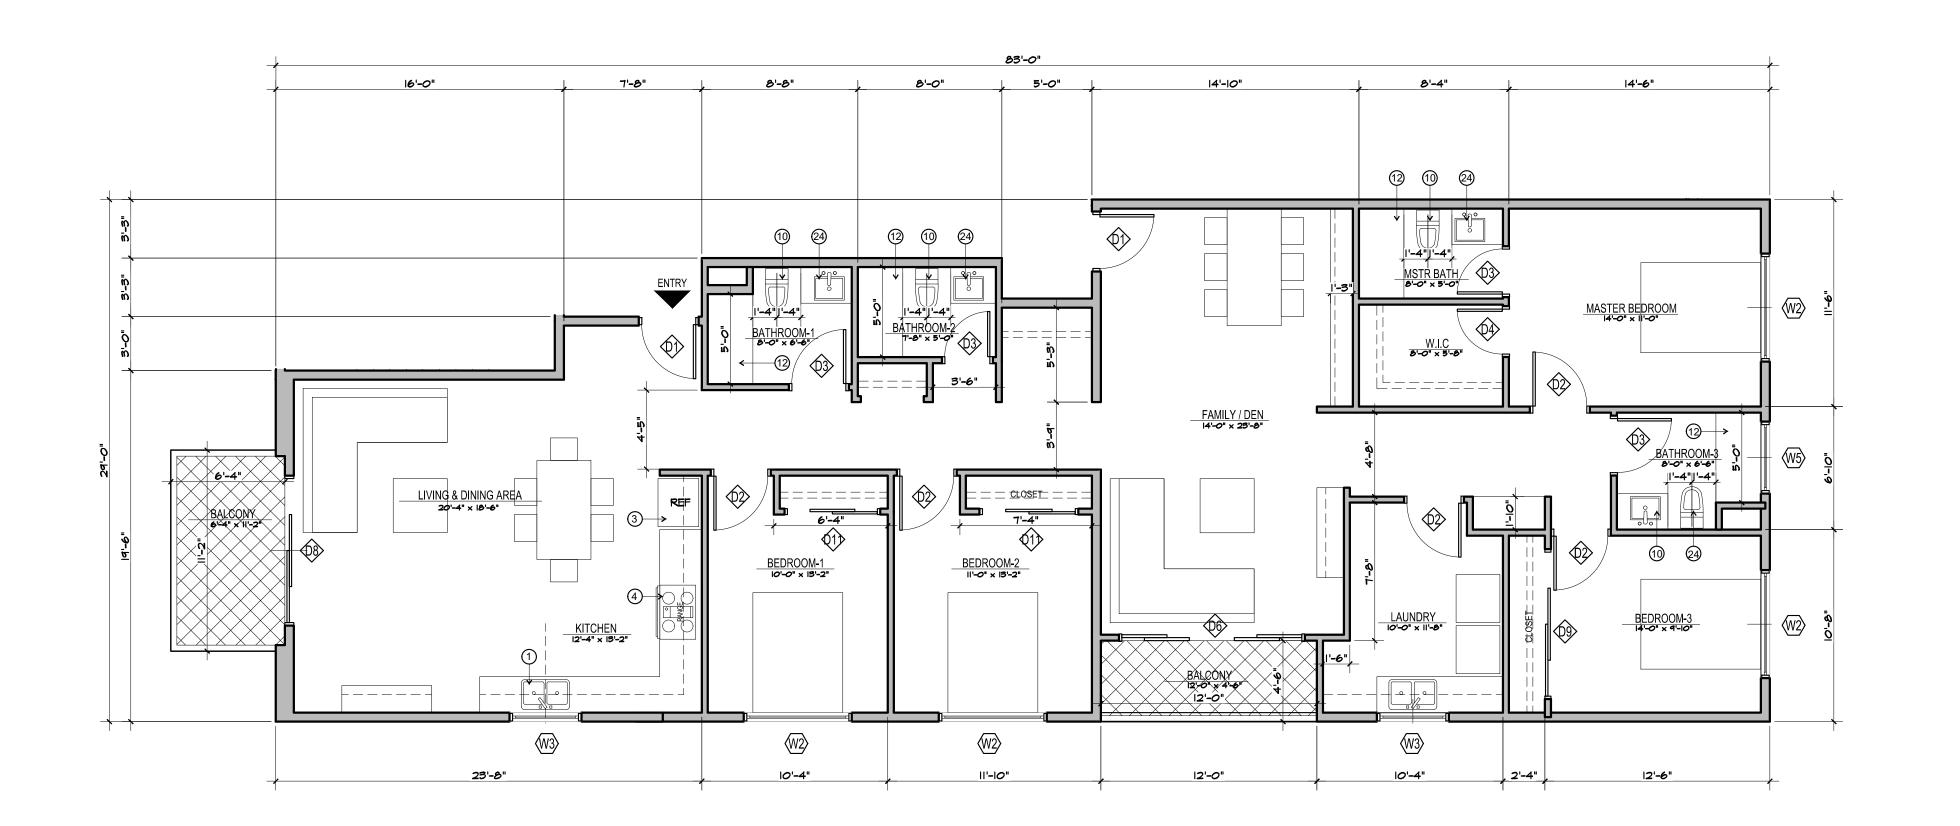

GENERAL NOTES

- DWELLING UNITS ACCESSIBILITY, REFER TO SHEET A-
- COMMON AN PUBLIC AREAS ACCESSIBILITY, REFER TO SHEETS A- AND A-
- 3. ALL TUB/SHOWER COMBOS WILL BE UTILIZED FIBERGLASS. . WALLS ARE PERMITTED TO BE OF NON-RATED CONSTRUCTION EXCEPTS AS GRAPHICALLY NOTED ON BUI
- COMPOSITE FLOOR PLANS.

 5. UNITS SHALL HAVE AT LEAST A MINIMUM LEAKAGE OF 0.30 CFM50 PER SQUARE FOOT OF ENCLOSURE.

 6. WATER HEATER UNIT MODEL SEE PLUMBING SCHEDULE.
- RECESSED LIGHTING SHALL BE "BOXED IN" AT FIRE RATED FLOOR/CLG CONDITIONS 8. DIMENSIONS ARE MEASURED FROM FACE OF STUD (FOS) UNLESS NOTED OTHERWISE.

LIMIT DI ANTI ECEND

ELEMENT	DESCRIPTION
TYPE A	5/8" GYPSUM BOAR - TAPE, TEXTURE AND PAINT - SATIN LEVEL FIN
TYPE B	5/8" GYPSUM BOAR - TAPE, TEXTURE AND PAINT - SEMI GLOSS LEVEL 4 FIN
TYPE C	EXTERIOR SOFFIT 5/8 " GYP BOARD TYPR X - TAPE, TEXTURE STUCCO FINISH
	LIMIT OF SOFFIT ABOVE - HEIGHT PER FLOOR PLAN. REFER TO DET 14 & 15/A-
1/2"	FLOOR LEVEL AT DOORS SHALL NOT BE MORE THAN \$\frac{1}{2}\$ INCH LOWER THAN THRESHOLD AT THE DOORWAY PER C.B.C. SECTION 1008.1.6 AND 1132A. 4.1
HS C	FLOOR MATERIAL FLUSH TRANSITION
A Â A	INTERIOR ELEVATION KEY
IVING ROOM — CARPET —	ROOM NAME FLOOR FINISH
9' - 0"	CEILING HEIGHT
00	DOOR NUMBER - REFER TO DOOR SCHEDULE
200	WINDOW TYPE - REFER TO WINDOW SCHEDULE
0	RECESSED LIGHT FIXTURE (AT AND IC RATED)
	CEILING FAN
	SUPPLY AIR REGISTER
] →→	SUPPLY AIR SIDE WALL REGISTER
	RETURN AIR REGISTER
	RETURN AIR SIDE WALL REGISTER
	EXHAUST AIR REGISTER / FAN - ENERGY STAR COMPLIANT - SEE MECH
SD	SMOKE DETECTOR
©	CARBON MONOXIDE DETECTOR
$\overline{}$	WALL TYPE OWNER, OFF COLIFFIES ON CUEFT A AND A

UNIT PLAN KEYNOTES

- DOUBLE BOWL SINK W WITH GARAGE DISPOSAL & HOLE FOR DISHWASHER AIR GAP. PROVIDE ADAPTABLE REQUIREMENTS WHERE NOTED/REFER TO SCHEDULE OF FINISHES.
- UNDER-COUNTER +/ 24" WIDE DISHWASHER (BOSCH 24" ADA OR APPROVED EQUAL. ENERGY STAR CERTIFIED). PROVIDE ADAPTABLE REQUIREMENTS.
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WALL TYPE SYMBOL. - SEE SCHEDULE ON SHEET A-- AND A--

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- (5) 24" DEEP BASE CABINET WITH COUNTERTOP
- 6 12" DEEP UPPER CABINET 7) ENERGY STAR WASHER AND DRYER -- STACKED
- 8 VOID SPACE, FILL IN WITH INSULATION
- 9 ULTRA-LOW FLUSH TOILET REFER TO DETAIL FOR ACCESSIBILITY REQUIREMENTS
- (10) 32" x 60" TUB/SHOWER VERIFY UNIT DIMENSIONS WITH MANUFACTURER
- RECESSED MEDICINE CABINET. PROVIDE 1- HR RATED WALL RECESS WHERE OCCURS IN 1 -HR RATED WALL
- FUTURE 36" GRAB BAR. PROVIDE SOLID BLOCKING CONCEALED WITHIN WALL CENTERED ON BAR LOCATION 13) FUTURE 42" GRAB BAR. PROVIDE SOLID BLOCKING CONCEALED WITHIN WALL CENTERED ON BAR LOCATION
- (14) ELECTRIC PANEL REFER TO ELECTRICAL DRAWINGS FOR SOME INFORMATION POLE AND SHELF. LOCATE POLE 66" ABOVE FINISH FLOOR. PROVIDE 2x6 BLOCKING WITHIN
- 5) STUD BAY AT EACH END & CENTER OF POLE FOR POLE HARDWARE. VERIFY SHELF BRACKETS & PROVIDE
- CEILING MOUNTED HORIZONTAL FAN COIL UNIT. (SEE MECHANICAL PLANS) VERIFY UNIT DIMENSIONS AND CLEARANCE REQUIREMENTS PRIOR TO FRAMING AND SETTING DROPPED CEILING HEIGHT. PROVIDE MINIMUM REQUIRED MANUFACTURE ACCESS PANEL COMPATIBLE WITH F.C.U. PAINT PANEL TO MATCH CEILING.
- 18) METAL THRESHOLD. FLOOR LEVEL CHANGES GREATER THAN 4" AT DOORWAYS SHALL BE BEVELED OR SLOPE NOT GREATER THAN ONE UNIT VERTICAL IN TWO UNITS
 HORIZONTAL (50% SLOPE). REFER TO DETAILS AT ENTRY DOOR AT BALCONY SLIDING DOOR
- 19 UNIT DOOR BELL AT +48"AFF SEE ELEC (20) ACCESSIBLE COMPLIANT LAVATORY
- (21) UNIT SIGNAGE
- (22) WATER SUB METER AT HIGH LEVEL INSIDE CEILING SPACE WITH CEILING ACCESS SEE PLUMBING (23) DUAL REMOTE WATER METER DISPLAY. MOUNT HT. AT 4' - 0". ABOVE FINISH FLOOR TO TOP OF DISPLAY
- (24) 15" MIN. BREADBOARD
- (25) ENERGY STAR TANKLESS WATER HEATER. SEE PLUMBING DRAWINGS. VERIFY REQUIRED CLEARANCES WITH MFR PRIOR TO FRAMING
- (26) SMOKE DETECTOR
- (27) CARBON MONOXIDE DETECTOR
- (28) 42" HIGH GUARD RAIL REFER TO EXTERIOR ELEVATIONS.
- 29 EXTERIOR LOW WALL REFER TO EXTERIOR ELEVATION
- (30) 1HR RATED SHAFT CONTRACTOR TO VERIFY WITH MECHANICAL DRAWINGS (31) EXTERIOR EXHAUST LOUVER - SEE MECHANICAL
- 32) GUTTER

SCALE 3/16" = 1'-0"

- (33) SCUPPER
- (34) CEILING BREAK
- (35) 2" WIDE PVC SOFFIT VENT SEE DETAIL
- (36) NOT USED



2173 LOMITA BLVD. #201 LOMITA CALIFORNIA 90717

Architect:

ART ASHAI, AIA

2173 LOMITA BLVD. #201 LOMITA CALIFORNIA 90717 PHONE: 424-263-5888 email: artashai@gmail.com

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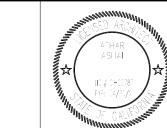
PROJECT INFORMATION:

21250 Main Street Carson, CA 90745

CARSON APARTMENTS 21240 Main Street Carson, CA 90745

LEGAL DESCRIPTION APN: 7334-002-007

APN: 7334-002-008



Rev.#	Date/Issue	Notes	
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Sheet Title:

BUILDING B-UNIT PLANS

	Scale : AS NOTED	Job Number : J-1908	0/21
	Date: Aug2021	Sheet Number :	: 10/2
	Drawn: arkihaus	A-124	DATE
ı	Check'd: CTV/RRJ		LOT

UNIT PLAN 303 - FLOOR PLAN



21250 Main Street Carson, CA 90745 LEGAL DESCRIPTION APN: 7334-002-007 APN: 7334-002-008 Sheet Title: AS NOTED Date: Aug2021 Drawn: arkihaus Check'd: CTV/RRJ

DESIGN STUDIO

2 1 7 3 LOMITA BLVD. # 2 0 1 LOMITA CALIFORNIA 9 0 7 1 7

Architect:

ART ASHAI, AIA 2173 LOMITA BLVD. #201 LOMITA CALIFORNIA 90717

PHONE: 424-263-5888 email: artashai@gmail.com


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21240 MAIN STREET & 21250 MAIN STREET

PROJECT INFORMATION:

Project Title: CARSON APARTMENTS 21240 Main Street Carson, CA 90745



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ELEVATIONS

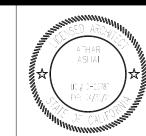Job Number : J-1908 Sheet Number:

2173 LOMITA BLVD. #201 LOMITA CALIFORNIA 90717

Architect:

ART ASHAI, AIA

2173 LOMITA BLVD. #201 LOMITA CALIFORNIA 90717 PHONE: 424-263-5888 email: artashai@gmail.com

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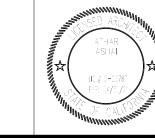
CARSON LOFTS
21240 MAIN STREET & 21250 MAIN STREET

PROJECT INFORMATION:

Project Title : CARSON A

CARSON APARTMENTS 21240 Main Street Carson, CA 90745 21250 Main Street Carson, CA 90745

LEGAL DESCRIPTION APN: 7334-002-007 APN: 7334-002-008



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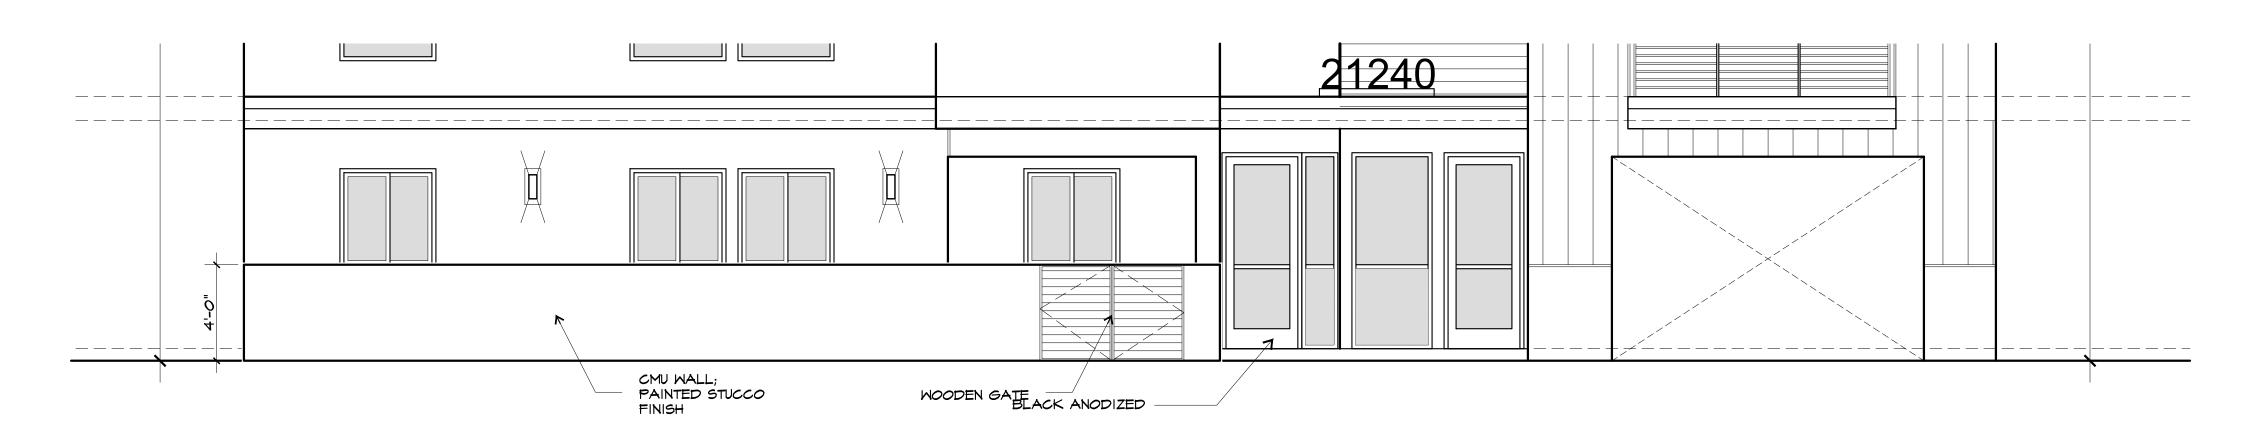
BLOW-UP ELEVATIONS

Scale : AS NOTED	Job Number : J-1908
Date: May 2021	Sheet Number :
Drawn: arkihaus	A-201.1
Check'd: CTV/RRJ	

BLOWLIP FLEVATION (21250 MAIN STREET)


2 BLOW-UP ELEVATION (21250 MAIN STREET)

SCALE: 1/4" = 1'-0"



BLOW-UP ELEVATION (21240 MAIN STREET)

SCALE: 1/4" = 1'-0"

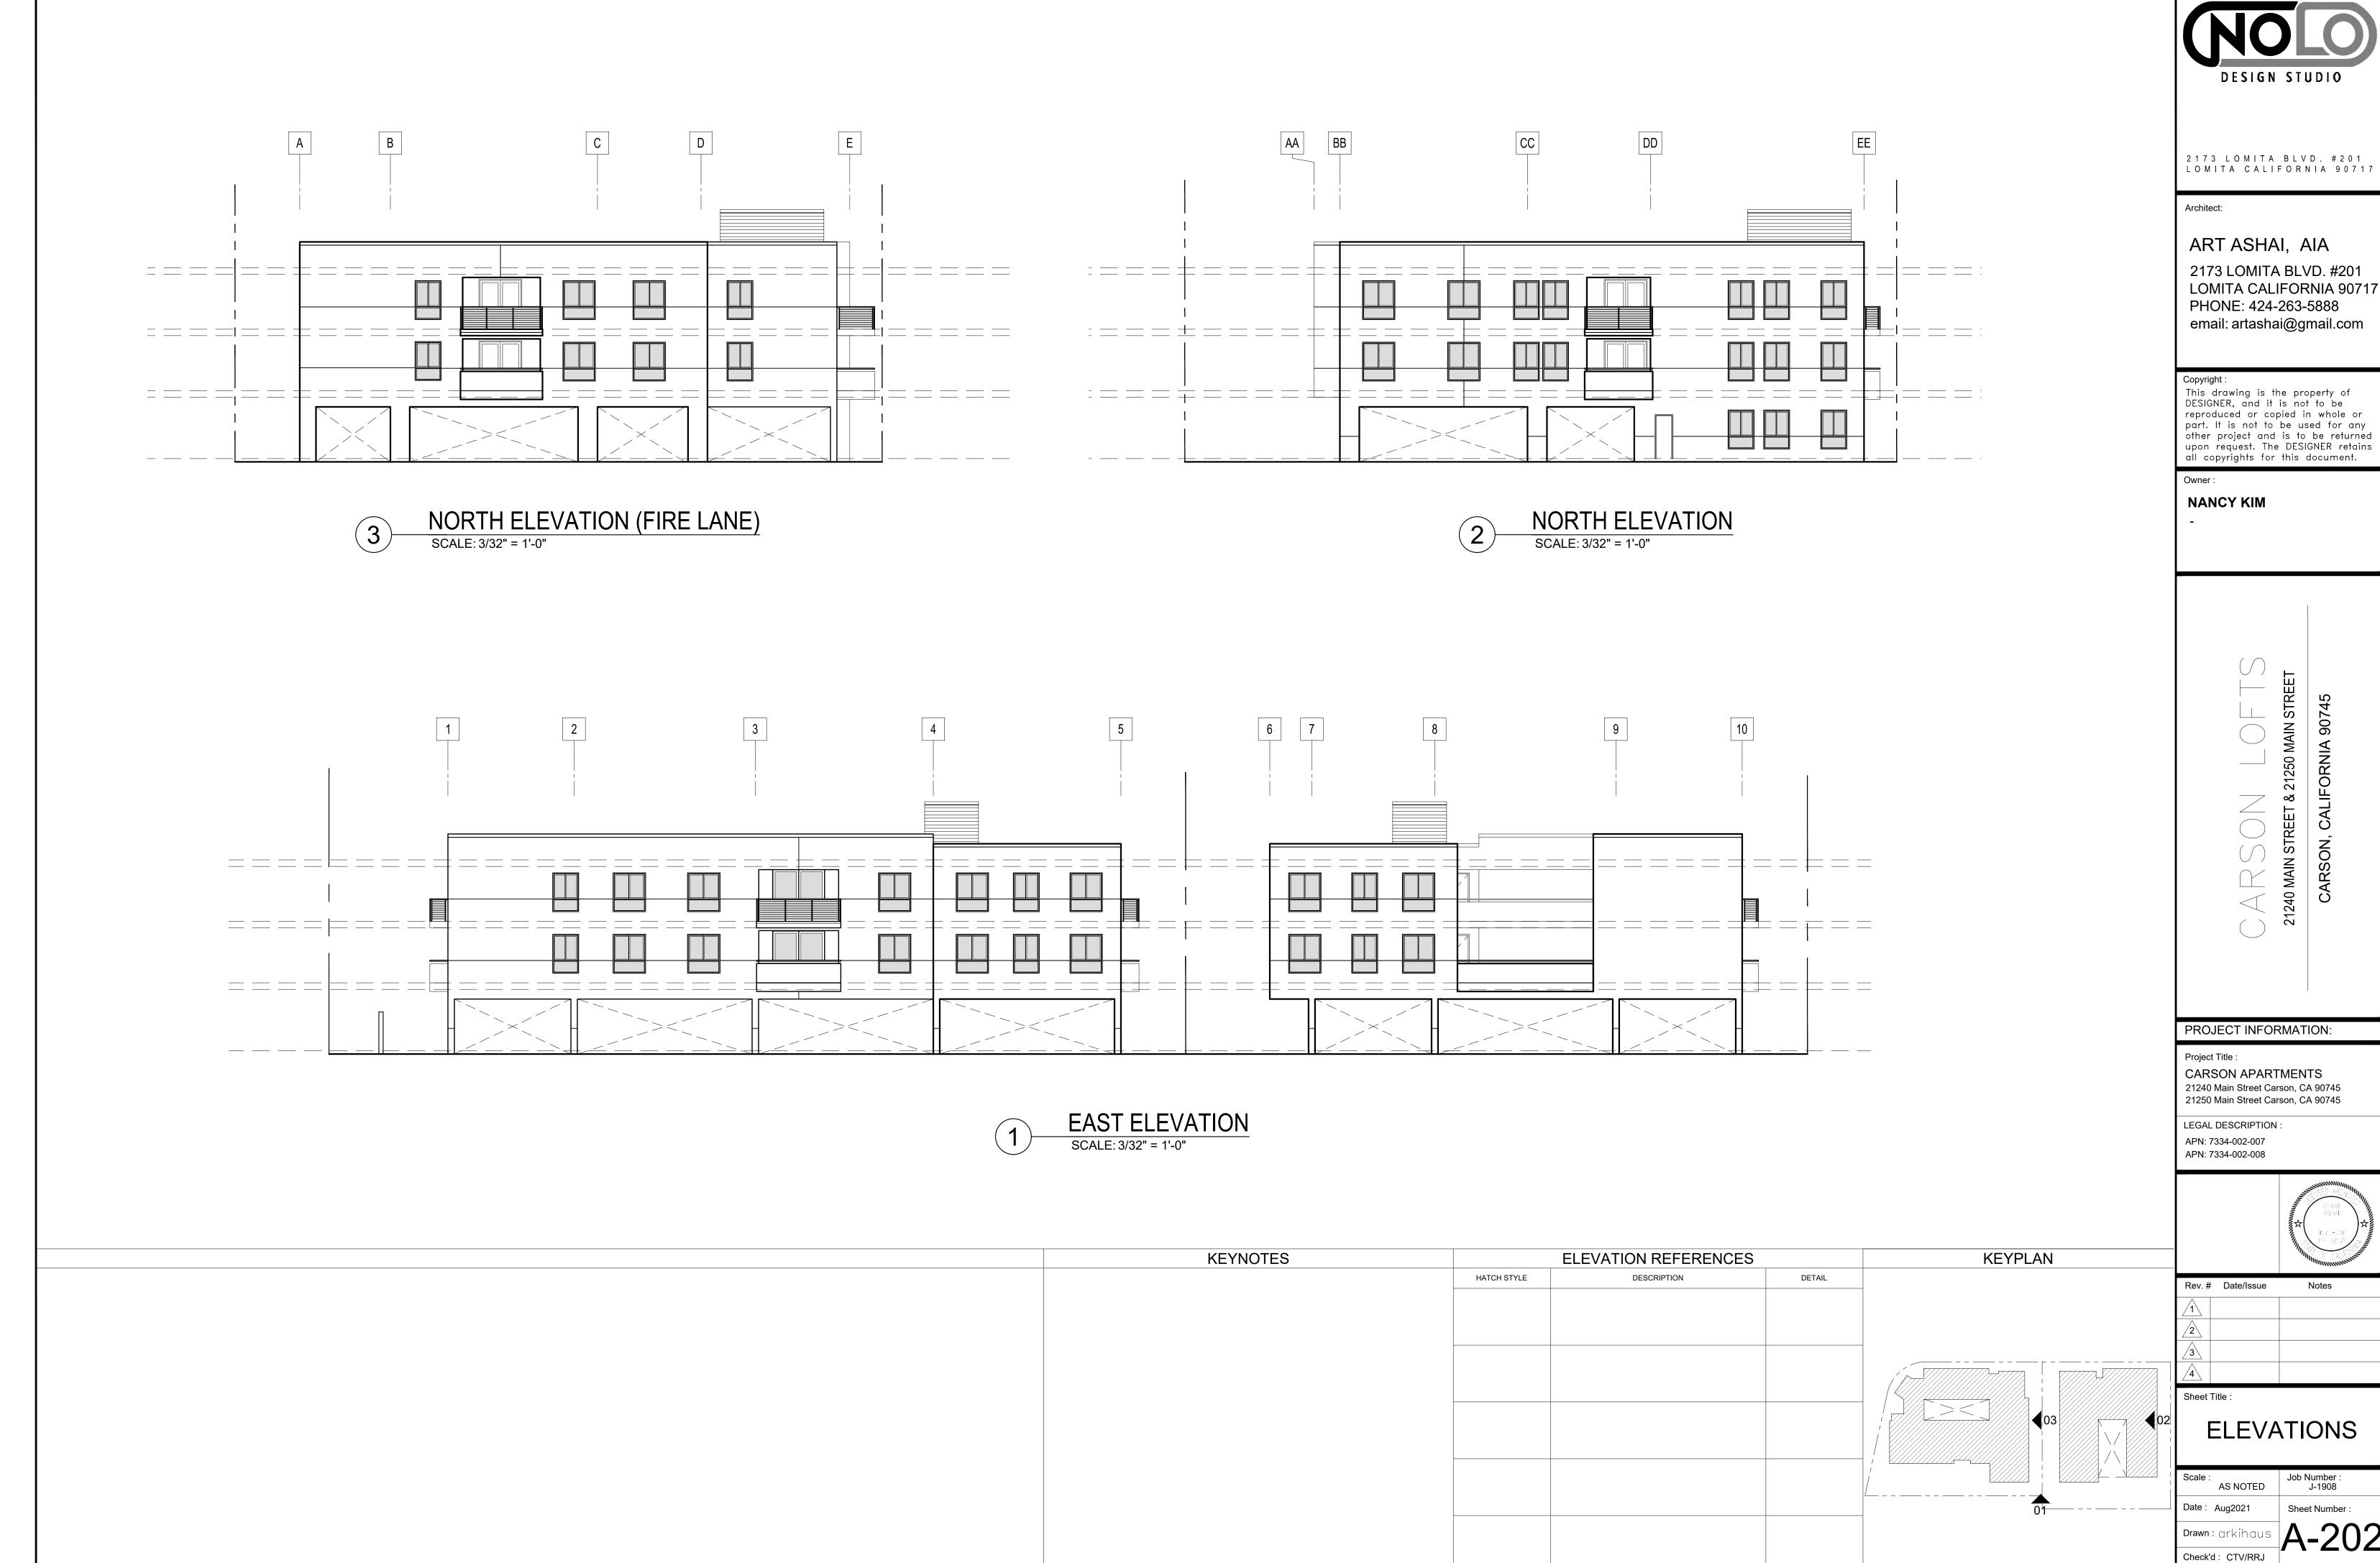




ART ASHAI, AIA

2173 LOMITA BLVD. #201 LOMITA CALIFORNIA 90717 PHONE: 424-263-5888

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ELEVATIONS

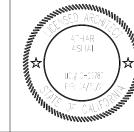Scale : AS NOTED	Job Number : J-1908	0/21
Date : Aug2021	Sheet Number :	: 10/20/2
Drawn: arkihaus	A-202	DATE
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2 1 7 3 L O M I T A B L V D . # 2 0 1 L O M I T A C A L I F O R N I A 9 0 7 1 7

Architect:

ART ASHAI, AIA 2173 LOMITA BLVD. #201 LOMITA CALIFORNIA 90717

PHONE: 424-263-5888 email: artashai@gmail.com

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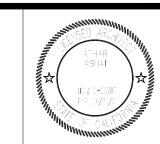




PROJECT INFORMATION:

CARSON APARTMENTS 21240 Main Street Carson, CA 90745 21250 Main Street Carson, CA 90745

LEGAL DESCRIPTION : APN: 7334-002-007 APN: 7334-002-008



Rev.#	: Date/Issue	Notes
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RENDERINGS


AS NOTED	J-1908
Date: Aug2021	Sheet Number :
Drawn: arkihaus	A-202.1
Check'd : CTV/RR I	






SOUTHWEST RENDERING

NORTHWEST RENDERING

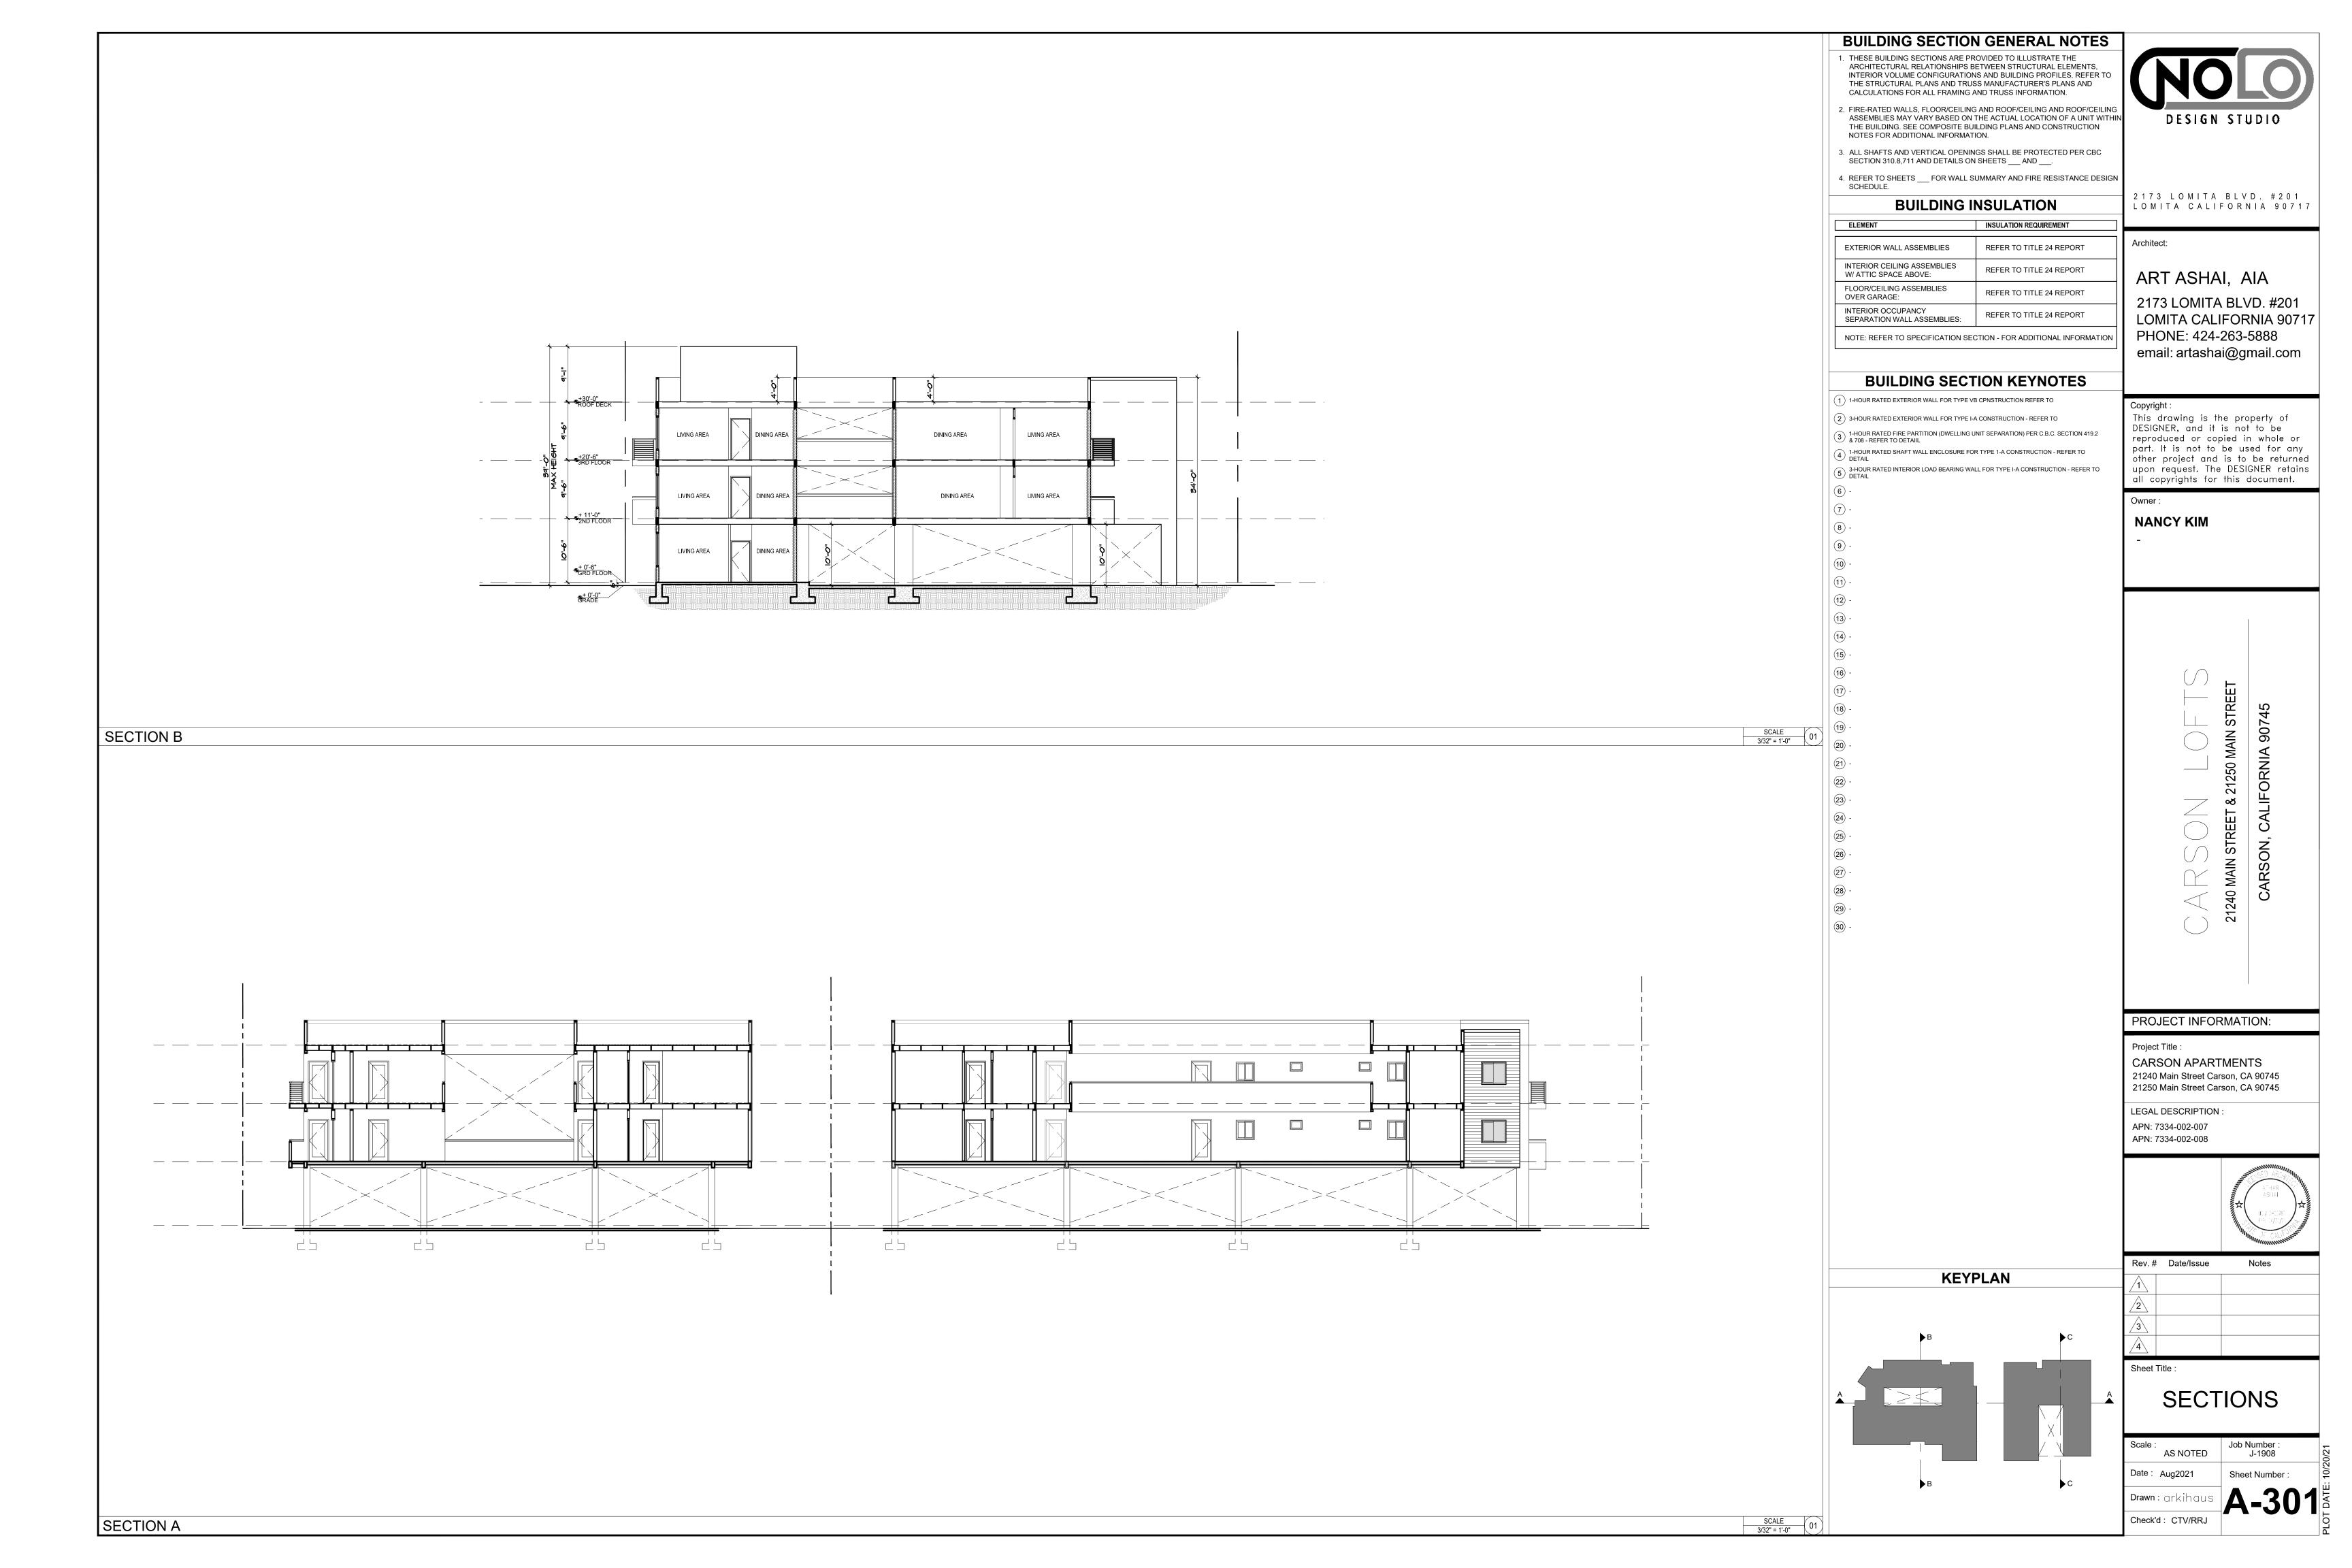

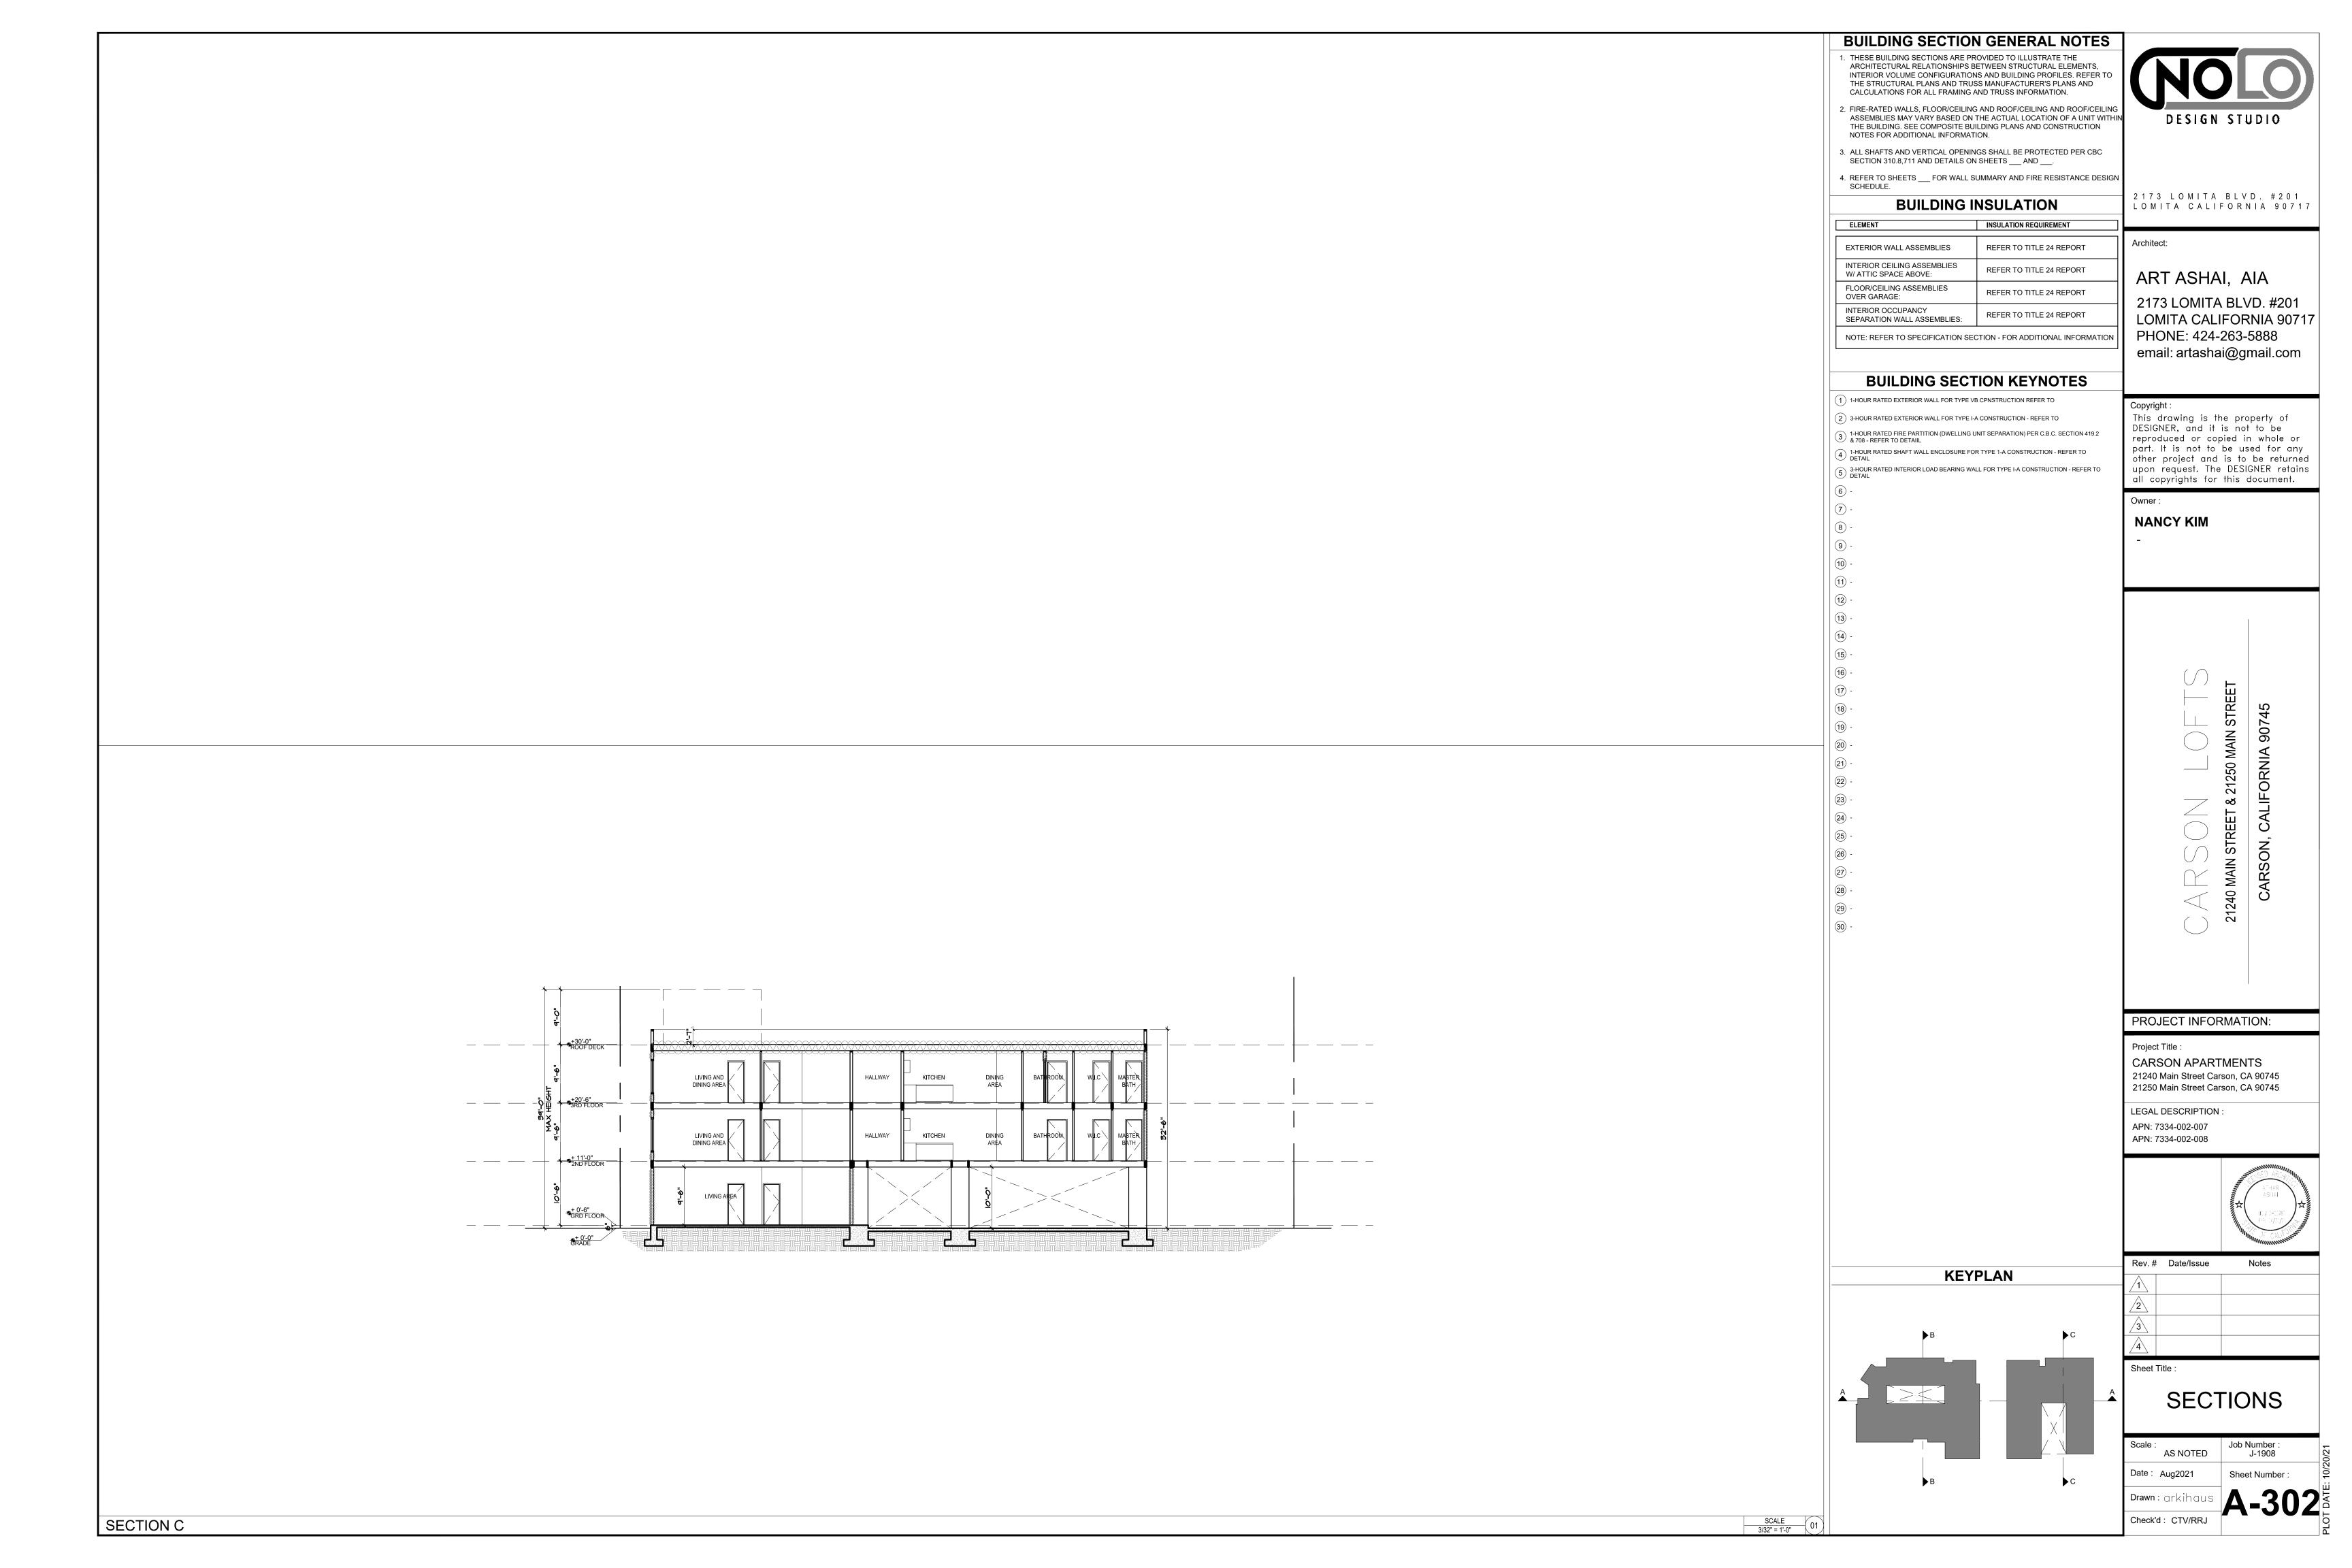

GENERAL NOTES:

- 1. ALL GRADING AND CONSTRUCTION SHALL CONFORM TO APPENDIX CHAPTER 33 AND CHAPTER 71 (LATEST EDITION) OF THE LOS ANGELES COUNTY BUILDING CODE UNLESS SPECIFICALLY NOTED ON THESE PLANS.
- 2. ANY MODIFICATIONS OF OR CHANGES TO APPROVED GRADING PLANS MUST BE APPROVED BY THE BUILDING OFFICIAL.
- 3. NO GRADING SHALL BE STARTED WITHOUT FIRST NOTIFYING THE BUILDING OFFICIAL. A PRE-GRADING MEETING AT THE SITE IS REQUIRED BEFORE THE START OF THE GRADING WITH THE FOLLOWING PEOPLE PRESENT: OWNER, GRADING CONTRACTOR, DESIGN CIVIL ENGINEER, SOILS ENGINEER, GEOLOGIST, COUNTY GRADING INSPECTOR(S) OR THEIR REPRESENTATIVES, AND WHEN REQUIRED THE ARCHEOLOGIST OR OTHER JURISDICTIONAL AGENCIES. PERMITTE OR HIS AGENT ARE RESPONSIBLE FOR ARRANGING PRE-GRADE MEETING AND MUST NOTIFY THE BUILDING OFFICIAL AT LEAST TWO BUSINESS DAYS PRIOR TO PROPOSED PRE-GRADE MEETING.
- 4. APPROVAL OF THESE PLANS REFLECT SOLELY THE REVIEW OF PLANS IN ACCORDANCE WITH THE LOS ANGELES COUNTY BUILDING CODE AND DOES NOT REFLECT ANY POSITION BY THE COUNTY OF LOS ANGELES OR THE DEPARTMENT OF PUBLIC WORKS REGARDING THE STATUS OF ANY TITLE ISSUES RELATING TO THE LAND ON WHICH THE IMPROVEMENTS MAY BE CONSTRUCTED. ANY DISPUTES RELATING TO TITLE ARE SOLELY A PRIVATE MATTER NOT INVOLVING THE COUNTY OF LOS ANGELES OR THE DEPARTMENT OF PUBLIC WORKS.
- 5. ALL GRADING AND CONSTRUCTION ACTIVITIES SHALL COMPLY WITH LOS ANGELES COUNTY CODE, TITLE 12, SECTION 2.12.030 THAT CONTROLS AND RESTRICTS NOISE FROM THE USE OF CONSTRUCTION AND GRADING EQUIPMENT FROM THE HOURS OF 8:00 PM TO 6:30 AM, AND ON SUNDAYS AND HOLIDAYS. (MORE RESTRICTIVE CONSTRUCTION ACTIVITY TIMES MAY GOVERN, AS REQUIRED BY THE DEPARTMENT OF REGIONAL PLANNING AND SHOULD BE SHOWN ON THE GRADING PLANS WHEN APPLICABLE.)
- 6. CALIFORNIA PUBLIC RESOURCES CODE (SECTION 5097.98) AND HEALTH AND SAFETY CODE (SECTION 7050.5) ADDRESS THE DISCOVERY AND DISPOSITION OF HUMAN REMAINS. IN THE EVENT OF DISCOVERY OR RECOGNITION OF ANY HUMAN REMAINS IN ANY LOCATION OTHER THAN A DEDICATED CEMETERY, THE LAW REQUIRES THAT GRADING IMMEDIATELY STOPS AND NO FURTHER EXCAVATION OR DISTURBANCE OF THE SITE, OR ANY NEARBY AREA WHERE HUMAN REMAINS MAY BE LOCATED, OCCUR UNTIL THE FOLLOWING HAS BEEN MEASURES HAVE BEEN TAKEN:

a. THE COUNTY CORONER HAS BEEN INFORMED AND HAS DETERMINED THAT NO INVESTIGATION OF THE CAUSE OF DEATH IS REQUIRED, AND

b. IF THE REMAINS ARE OF NATIVE AMERICAN ORIGIN, THE DESCENDANTS FROM THE DECEASED NATIVE AMERICANS HAVE MADE A RECOMMENDATION FOR THE MEANS OF TREATING OR DISPOSING, WITH APPROPRIATE DIGNITY, OF THE HUMAN REMAINS AND ANY ASSOCIATED GRAVE GOODS.

- 7. THE LOCATION AND PROTECTION OF ALL UTILITIES IS THE RESPONSIBILITY OF THE PERMITTEE.
- 8. ALL EXPORT OF MATERIAL FROM THE SITE MUST GO TO A PERMITTED SITE APPROVED BY THE BUILDING OFFICIAL OR A LEGAL DUMPSITE. RECEIPTS FOR ACCEPTANCE OF EXCESS MATERIAL BY A DUMPSITE ARE REQUIRED AND MUST BE PROVIDED TO THE BUILDING OFFICIAL UPON REQUEST.
- 9. A COPY OF THE GRADING PERMIT AND APPROVED GRADING PLANS MUST BE IN THE POSSESSION OF A RESPONSIBLE PERSON AND AVAILABLE AT THE SITE AT ALL TIMES.
- 10. SITE BOUNDARIES, EASEMENTS, DRAINAGE DEVICES, RESTRICTED USE AREAS SHALL BE LOCATED PER CONSTRUCTION STAKING BY FIELD ENGINEER OR LICENSED SURVEYOR. PRIOR TO GRADING, AS REQUESTED BY THE BUILDING OFFICIAL, ALL PROPERTY LINES, EASEMENTS, AND RESTRICTED USE AREAS SHALL BE STAKED.
- 11. NO GRADING OR CONSTRUCTION SHALL OCCUR WITHIN THE PROTECTED ZONE OF ANY OAK TREE AS REQUIRED PER TITLE CHAPTER 22.56 OF THE LOS ANGELES COUNTY ZONING CODE. THE PROTECTED ZONE SHALL MEAN THAT AREA WITHIN THE DRIP LINE OF AN OAK TREE EXTENDING THERE FROM A POINT AT LEAST FIVE FEET OUTSIDE THE DRIP LINE, OR 15 FEET FROM THE TRUNK(S) OF A TREE, WHICHEVER IS GREATER.
- 12. THE STANDARD RETAINING WALL DETAILS SHOWN ON THE GRADING PLANS ARE FOR REFERENCE ONLY. STANDARD RETAINING WALLS ARE NOT CHECKED, PERMITTED, OR INSPECTED PER THE GRADING PERMIT. A SEPARATE RETAINING WALL PERMIT IS REQUIRED FOR ALL STANDARD RETAINING WALLS.

NOTE: THIS NOTE ONLY APPLIES TO STANDARD RETAINING WALLS. GEOGRID FABRIC AND SEGMENTAL RETAINING WALLS DO NOT REQUIRE A SEPARATE RETAINING WALL PERMIT. DETAILS AND CONSTRUCTION NOTES FOR ALL GEOGRID WALLS MUST BE ON THE GRADING PLAN.

- 13. A PREVENTIVE PROGRAM TO PROTECT THE SLOPES FROM POTENTIAL DAMAGE FROM BURROWING RODENTS IS REQUIRED PER SECTION 3307.6 OF THE LOS ANGELES COUNTY BUILDING CODE. OWNER IS TO INSPECT SLOPES PERIODICALLY FOR EVIDENCE OF BURROWING RODENTS AND A FIRST EVIDENCE OF THEIR EXISTENCE SHALL EMPLOY AN EXTERMINATOR FOR THEIR REMOVAL.
- 14. IF GRADING AUTHORIZED BY THIS PLAN IS TO EXTEND THROUGH THE RAINY SEASON, NOVEMBER 1 THROUGH APRIL 15 OF THE FOLLOWING YEAR, SEPARATE UPDATED PLANS FOR EROSION CONTROL MUST BE SUBMITTED PRIOR TO OCTOBER PER SECTION 3319.3 OF THE LOS ANGELES COUNTY BUILDING CODE.
- 15. TRANSFER OF RESPONSIBILITY: IF THE CIVIL ENGINEER, THE SOILS ENGINEER, OR THE ENGINEERING GEOLOGIST OF RECORD IS CHANGED DURING GRADING, THE WORK SHALL BE STOPPED UNTIL THE REPLACEMENT HAS AGREED IN WRITING TO ACCEPT THEIR RESPONSIBILITY WITHIN THE AREA OF TECHNICAL COMPETENCE FOR APPROVAL UPON COMPLETION OF THE WORK. IT SHALL BE THE DUTY OF THE PERMITTEE TO NOTIFY THE BUILDING OFFICIAL IN WRITING OF SUCH CHANGE PRIOR TO THE RECOMMENCEMENT OF SUCH GRADING.

INSPECTION NOTES:

16. THE PERMITTEE OR HIS AGENT SHALL NOTIFY THE BUILDING OFFICIAL AT LEAST ONE WORKING DAY IN ADVANCE OF REQUIRED INSPECTIONS AT FOLLOWING STAGES OF THE WORK. (SECTION 3317 OF THE BUILDING CODE.)

(a) <u>INITIAL.</u> WHEN THE SITE HAS BEEN CLEARED OF VEGETATION AND UNAPPROVED FILL HAS BEEN SCARIFIED, BENCHED OR OTHERWISE PREPARED FOR FILL. FILL SHALL NOT BE PLACED PRIOR TO THIS INSPECTION. NOTE: PRIOR TO ANY CONSTRUCTION ACTIVITIES, INCLUDING GRADING, ALL STORM WATER POLLUTION PREVENTION MEASURES INCLUDING EROSION CONTROL DEVICES WHICH CONTAIN SEDIMENTS MUST BE INSTALLED.

(b) <u>ROUGH.</u> WHEN APPROXIMATE FINAL ELEVATIONS HAVE BEEN ESTABLISHED; DRAINAGE TERRACES, SWALES AND BERMS INSTALLED AT THE TOP OF THE SLOPE; AND THE STATEMENTS REQUIRED IN THIS SECTION HAVE BEEN RECEIVED.

(c) <u>FINAL</u>. WHEN GRADING HAS BEEN COMPLETED; ALL DRAINAGE DEVICES INSTALLED; SLOPE PLANTING ESTABLISHED, IRRIGATION SYSTEMS INSTALLED AND THE AS-BUILT PLANS, REQUIRED STATEMENTS, AND REPORTS HAVE BEEN SUBMITTED AND APPROVED.

- 17. IN ADDITION TO THE INSPECTION REQUIRED OF THE BUILDING OFFICIAL FOR REGULAR GRADING, REPORTS AND STATEMENTS SHALL BE SUBMITTED TO THE BUILDING OFFICIAL IN ACCORDANCE WITH SECTIONS 3317 AND 3318 OF THE LOS ANGELES COUNTY BUILDING CODE.
- 18. ALL GRADED SITES MUST HAVE DRAINAGE SWALES, BERMS, AND OTHER DRAINAGE DEVICES INSTALLED PRIOR TO ROUGH GRADING APPROVAL PER SECTION 3317.6 OF THE LOS ANGELES COUTY BUILDING CODE.
- 19. THE GRADING CONTRACTOR SHALL SUBMIT THE STATEMENT TO THE GRADING INSPECTOR AS REQUIRED BY SECTION 3318.1 OF THE LOS ANGELES COUNTY BUILDING CODE AT THE COMPLETION OF ROUGH GRADING.
- 20. FINAL GRADING MUST BE APPROVED BEFORE OCCUPANCY OF BUILDINGS WILL BE ALLOWED PER SECTION 3318 OF THE LOS ANGELES COUNTY BUILDING CODE.

DRAINAGE NOTES:

- 21. ROOF DRAINAGE MUST BE DIVERTED FROM GRADED SLOPES.
- 22. PROVISIONS SHALL BE MADE FOR CONTRIBUTORY DRAINAGE AT ALL TIMES.
- 23. ALL CONSTRUCTION AND GRADING WITHIN A STORM DRAIN EASEMENT ARE TO BE DONE PER PRIVATE DRAIN PD NO.

 OR MISCELLANEOUS TRANSFER DRAIN MTD NO.
- 24. ALL STORM DRAIN WORK IS TO BE DONE UNDER CONTINUOUS INSPECTION BY THE FIELD ENGINEER. WEEKLY STATUS REPORTS SHALL BE SUBMITTED BY THE FIELD ENGINEER TO THE LOCAL BUILDING AND SAFETY DISTRICT OFFICE.

STORMWATER POLLUTION PLAN NOTES

- . EVERY EFFORT SHOULD BE MADE TO ELIMINATE THE DISCHARGE OF NON-STORMWATER FROM THE PROJECT SITE AT ALL TIMES.
- ERODED SEDIMENTS AND OTHER POLLUTANTS MUST BE RETAINED ON—SITE AND MAY NOT BE TRANSPORTED FROM THE SITE VIA SHEET FLOW, SWALES, AREA DRAINS, NATURAL DRAINAGE COURSES OR WIND.
- 3. STOCKPILES OF EARTH AND OTHER CONSTRUCTION RELATED MATERIALS MUST BE PROTECTED FROM BEING TRANSPORTED FROM THE SITE BY THE FORCES OF WIND OR WATER.
- FUELS, OILS, SOLVENTS, AND OTHER TOXIC MATERIALS MUST BE STORED IN ACCORDANCE WITH THEIR LISTING AND ARE NOT TO CONTAMINATE THE SOIL AND SURFACE WATERS. ALL APPROVED STORAGE CONTAINERS ARE TO BE PROTECTED FROM THE WEATHER. SPILLS MUST BE CLEANED UP IMMEDIATELY AND DISPOSED OF IN A PROPER MANNER. SPILLS MAY NOT BE WASHED INTO THE DRAINAGE SYSTEM.
- 5. EXCESS OR WASTE CONCRETE MAY NOT BE WASHED INTO THE PUBLIC WAY OR ANY OTHER DRAINAGE SYSTEM. PROVISIONS SHALL BE MADE TO RETAIN CONCRETE WASTES ON—SITE UNTIL THEY CAN BE DISPOSED OF AS SOLID WASTE.
- . TRASH AND CONSTRUCTION RELATED SOLID WASTES MUST BE DEPOSITED INTO A COVERED RECEPTACLE TO PREVENT CONTAMINATION OF RAINWATER AND DISPERSAL BY WIND.
- SEDIMENTS AND OTHER MATERIALS MAY NOT BE TRACKED FROM THE SITE BY VEHICLE TRAFFIC. THE CONSTRUCTION ENTRANCE ROADWAYS MUST BE STABILIZED SO AS TO INHIBIT SEDIMENTS FROM BEING DEPOSITED INTO THE PUBLIC WAY. ACCIDENTAL DEPOSITIONS MUST BE SWEPT UP IMMEDIATELY AND MAY NOT BE WASHED DOWN BY RAIN OR OTHER MEANS.
- 8. ANY SLOPES WITH DISTURBED SOILS OR DENUDED OF VEGETATION MUST BE STABILIZED SO AS TO INHIBIT EROSION BY WIND AND WATER.
- AS THE PROJECT OWNER OR AUTHORIZED AGENT OF THE OWNER, I HAVE READ AND UNDERSTAND THE REQUIREMENTS LISTED ABOVE, NECESSARY TO CONTROL STORM WATER POLLUTION FROM SEDIMENTS, EROSION, AND CONSTRUCTION MATERIALS, AND I CERTIFY THAT I WILL COMPLY WITH THESE REQUIREMENTS.

PRINT NAME _______ (OWNER OR AUTHORIZED AGENT OF THE OWNER)

SIGNATURE ______ DATE ______ DATE ______

THE FOLLOWING BMPs AS OUTLINED IN, BUT NOT LIMITED TO, THE <u>BEST MANAGEMENT PRACTICE</u> <u>HANDBOOK, CALIFORNIA STORMWATER QUALITY TASK FORCE, SACRAMENTO, CALIFORNIA 1993</u>, OR THE LATEST REVISED EDITION, MAY APPLY DURING THE CONSTRUCTION OF THIS PROJECT (ADDITIONAL MEASURES MAY BE REQUIRED IF DEEMED APPROPRIATE BY COUNTY INSPECTORS)

CA001-DEWATERING OPERATIONS CA002-PAVING OPERATIONS CA003-STRUCTURE CONSTRUCTION AND PAINTING CAO10-MATERIAL DELIVERY AND STORAGE CAO11-MATERIAL USE CA012-SPILL PREVENTION AND CONTROL CAO20-SOLID WASTE MANAGEMENT CAO21-HAZARDOUS WASTE MANAGEMENT CA022-CONTAMINATED SOIL MANAGEMENT CA023-CONCRETE WASTE MANAGEMENT CA030-VEHICLE AND EQUIPMENT CLEANING CAO31-VEHICLE AND EQUIPMENT FUELING CA032-VEHICLE AND EQUIPMENT MAINTENANCE CA040-EMPLOYEE/SUBCONTRACTOR TRAINING ESC01-SCHEDULING ESC02-PRESERVATION OF EXISTING VEGETATION ESC10-SEEDING AND PLANTING

APPROVED BY:

CITY OF CARSON

APPROVAL RECOMMENDED BY:

ESC11-MULCHING

SOILS ENGINEER:

11823 SAUSON AVE #46

TEL: (562) 696-6062

SANTA FE SPRING, CÄ 90670

GSS INC.

ESC20-GEOTEXTILES AND MATS ESC21-DUST CONTROLS ESC22-TEMPORARY STREAM CROSSING ESC23-CONSTRUCTION ROAD STABILIZATION ESC24-STABILIZED CONSTRUCTION ENTRANCE ESC30-EARTH DIKE ESC31-TEMPORARY DRAINS AND SWALES ESC32-SLOPE DRAIN ESC40-OUTLET PROTECTION ESC41-CHECK DAMS ESC42-SLOPE ROUGHENING/TERRACING ESC50-SILT FENCE ESC51-STRAW BALE BARRIERS ESC52-SAND BAG BARRIERS ESC53-BRUSH OR ROCK FILTER ESC54-STORM DRAIN INLET PROTECTION ESC55-SEDIMENT TRAP ESC56-SEDIMENT BASIN

LEGEND

C.B. _ _ _ _ CATCH BASIN C.F. _ _ _ _ CURB FACE CONC._ _ _ _ CONCRETE DWY. _ _ _ _ DRIVEWAY F.F. _ _ _ _ FINISHED FLOOR F.G. _ _ _ _ FINISHED GRADE F.H. _ _ _ _ FIRE HYDRANT F.L. _ _ _ FLOW LINE F.S. _ _ _ _ FINISHED SURFACE G.B. _ _ _ _ GRADE BREAK H.P. _ _ _ _ HIGH POINT MAX. _ _ _ _ MAXIMUM MIN. _ _ _ _ MINIMUM P.L. _ _ _ PROPERTY LINE PVMT. _ _ _ PAVEMENT R. _ _ _ _ RADIUS T.C. _ _ _ TOP OF CURB T.C.B. _ _ _ _ TOP OF CATCH BASIN T.W. _ _ _ TOP OF WALL INV. _ _ _ _ INVERT CL. _ _ _ _ CENTER LINE

PROPOSED CONTOUR

(634) EXISTING ELEVATION

634 PROPOSED ELEVATION

FENCE

FIRE HYDRANT

FLOW LINE

SLOPE

CONCRETE

PROPOSED WALL

EXISTING WALL

RIDGE LINE

---- GRADE BREAK LINE

-- EXISTING CONTOUR

LEGAL DESCRIPTION

PARCEL 1:


LOT 7 OF TRACT NO. 8018 AS PER MAP RECORDED IN BOOK 165 PAGES 30-31 OF MAPS IN THE OFFICE OF THE COUNTY RECORDER OF SAID COUNTY, AND THE WESTERLY 10 FEET OF THAT PORTION OF THE VACATED ALLEY ADJOINING SAID LOT ON THE EASTERLY LINE.

ALSO THAT TRACT NO. 8018 AS PER MAP RECORDED IN BOOK 165 PAGES 30-31 OF MAPS IN THE OFFICE OF THE COUNTY, LIVING WESTERLY OF THE SOUTHERLY PROLONGATION OF THE EASTERLY LINE OF SAID LOT.

PARCEL 2:

LOT 8 OF TRACT 8018 AS PER MAP RECORDED IN BOOK 165 PAGES 30-31 OF MAPS IN THE OFFICE OF THE COUNTY RECORDER OF SAID COUNTY.

ALSO THAT PORTION OF THE SOUTH HALF OF AN ALLEY AS SHOWN ON SAID TRACT, VACATED BY RESOLUTION NO 142 RECORDED AS INSTRUMENT NO. 29088 ON OCT. 21, 1968 OFFICIAL RECORDS OF SAID COUNTY, LYING WESTERLY OF THE NORTHERLY PROLONGATION OF THE EASTERLY LINE OF SAID LOT.

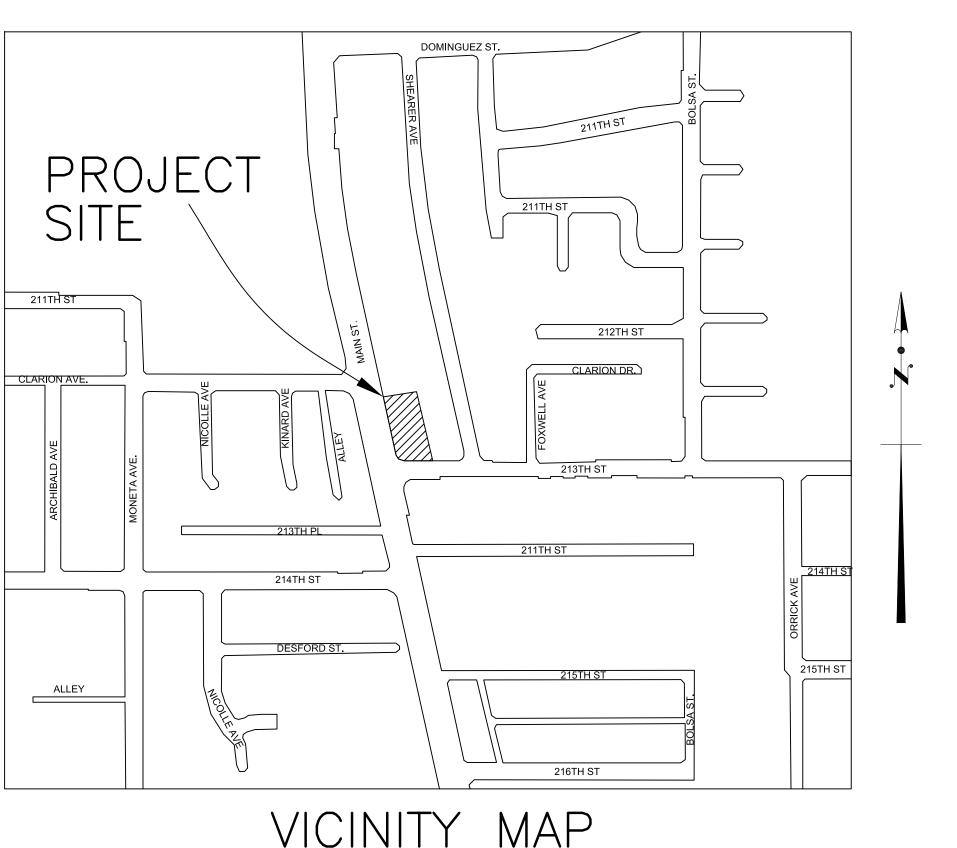

NOT TO SCALE

CONSTRUCTION NOTES

- 1) INSTALL 12"X12" GRATE DRAIN(ALHABRA FDRY. STD. 2011)
- (2) 4" DIA. PVC PIPE(SCHEDULE 40)
- (3) 6" CONC. ON COMPACTED PAVEMENT
- (4) 6' HIGH CONC BLOCK WALL PER APPROVED ARCHITECTURAL PLANS.
- (5) LANDSCAPE AREA PER APPROVED LANDSCAPE PLANS.
- (6) CONST. 4" DIA CAST IRON PRESSURED PIPE
- (7) DUAL PUMPING SYSTEM PER SEPARATE PERMIT
- (8) CONST. CONC DRIVEWAY PER APWA STD PLAN

ADDITIONAL NOTES


- THIS GRADING PLAN WAS PREPARED FOR THE EXCLUSIVE USE OF JEFF DAUN. IT SHALL NOT BE TRANSFERRED TO OR USED BY A THIRD PARTY WITHOUT THE PRIOR WRITTEN CONSENT OF THIS OFFICE.
- II. THE GEOTECHNICAL REPORT PREPARED BY NORCAL ENGINEERING.

 DATED JANUARY 25, 2005 (PROJECT NO. 11869-05) IS PART OF THIS GRADING PLAN AND THE CONTRACTOR SHALL COMPLY WITH ALL ITS RECOMMENDATIONS AND REQUIREMENTS.
- III. ALL DRAINAGE PIPES TO BE PVC SCHEDULE 40 MINIMUM OR EQUIVALENT WITH 4" MINIMUM DIAMETER
- IV. RETAINING WALLS REQUIRES SEPARATE PERMIT.
- V. CURB DRIAN REQUIRES SEPARATE PERMIT FROM ENGINEERING DEPT.
- VI. THE CONTRACTOR SHALL COMPLY WITH CITY OF CARSON ORDINANCE RELATED TO STANDARD URBAN STORMWATER MITIGATION PLAN (STATE OF CALIFORNIA MANDATED) AND COMPLY WITH NPDES PERMIT REQUIREMENTS.
- VII. THE SOILS ENGINEER OF RECORDS SHALL INSPECT AND APPROVE THE FOUNDATION EXCAVATIONS BEFORE STEEL OR CONCRETE IS PLACED.
- VIII. FOR DETAIL OF THE FOOTING AND FOUNDATION, REFER TO THE APPROVED STRUCTURAL AND ARCHITECTURAL DRAWINGS.
- IX. VOLUME OF CUT AND FILL

1,500	. C. i
1,500	C.Y
:	
	1,500

H. STEVE NAZEMI

GPC NO. XXXXXXXXXX CUP XXXXXXX

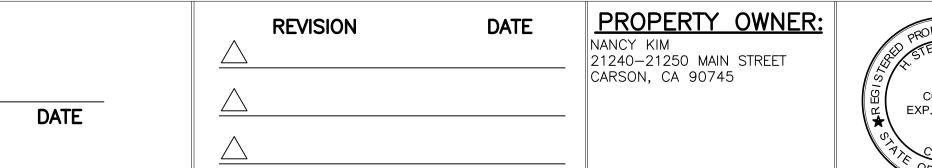



DHS & ASSOCIATES, INC.
275 CENTENNIAL WAY, #205
TUSTIN, CA 92780-3709
(714) 665-6569

<u> 10/08/202</u>1

GRADING AND DRAINAGE PLAN FOR 7 DETACHED TOWNHOUSES

SCALE: 1"=10'
DATE: 10/08/2021

TR53709 21240-21250 MAIN STREET CARSON, CA 90745

SHEET 1 OF 2

JOB NO.



