GENERAL NOTES

EQUIPMENT INDICATED.

1. THE WORK SHALL CONFORM TO THE APPLICABLE BUILDING CODE, AND OTHER ORDINANCES, CODES AND REGULATIONS LISTED IN THE PROJECT MANUAL OR ON THE DRAWINGS, AND REQUIRED BY LOCAL BUILDING AUTHORITIES. THE GOVERNING CODES, RULES AND REGULATIONS ARE COLLECTIVELY REFERRED TO AS "THE CODE". THE CONTRACTOR SHALL REPORT ANY INCONSISTENCIES, CONFLICTS OR OMISSIONS HE MAY DISCOVER TO THE ARCHITECT FOR INTERPRETATION PRIOR TO PERFORMING THE WORK.

2. THE CONTRACTOR SHALL ASSUME SOLE AND COMPLETE RESPONSIBILITY FOR JOB SITE CONDITIONS DURING THE COURSE OF CONSTRUCTION OF THIS PROJECT INCLUDING SAFETY OF ALL PERSONS AND PROPERTY. THIS REQUIREMENT SHALL APPLY CONTINUOUSLY AND NOT BE LIMITED TO NORMAL WORKING HOURS. THE CONTRACTOR SHALL PROVIDE PUBLIC PROTECTION AS NECESSARY AND REQUIRED BY GOVERNING CITY AGENCIES.

3. THE GENERAL CONTRACTOR IS RESPONSIBLE TO COORDINATE WORK OF ALL OF OWNER'S SUB-CONTRACTORS AND SHALL PERFORM SUCH MISCELLANEOUS WORK AS MAY BE NECESSARY FOR THEM TO COMPLETE THEIR WORK.

4. THE GENERAL CONTRACTOR SHALL VERIFY ALL CONDITIONS AND DIMENSIONS ON THE JOB SITE AND REPORT ANY AND ALL DISCREPANCIES AND/OR UNUSUAL CONDITIONS TO THE ARCHITECT PRIOR TO FINALIZING BIDS OR COMMENCEMENT OF ANY

5. THE CLIENT, ARCHITECT, CONSULTANTS AND ALL INSPECTORS FROM PERTINENT AGENCIES SHALL BE PERMITTED ACCESS TO THE JOB SITE AT ALL TIMES DURING NORMAL WORKING HOURS.

6. THE CONTRACTOR SHALL OBTAIN AND PAY FOR ALL PERMITS AND VERIFY GOVERNING AUTHORITIES' REQUIREMENTS FOR

7. THE CONTRACTOR SHALL BE RESPONSIBLE FOR ALL COSTS FOR INSPECTIONS AND/OR TESTS, UNLESS NOTED OTHERWISE.

8. DO NOT SCALE THESE DRAWINGS, SHOULD ANY DIMENSIONAL DISCREPANCIES BE ENCOUNTERED, CLARIFICATIONS SHALL BE OBTAINED FROM THE ARCHITECT.

9. DETAILS ARE INTENDED TO SHOW THE INTENT OF THE DESIGN. MINOR MODIFICATIONS MAY BE REQUIRED TO SUIT THE FIELD DIMENSIONS OR CONDITIONS AND SUCH MODIFICATIONS SHALL BE INCLUDED AS PART OF THE WORK OF THE CONTRACT.

10. UNLESS OTHERWISE NOTED ON THESE DRAWINGS OR IN THE SPECIFICATIONS AS BEING NIC. OR EXISTING, ALL ITEMS, MATERIALS, ETC., AND THE INSTALLATIONS OF SAME ARE A PART OF THE CONTRACT DEFINED BY THESE DRAWINGS AND SPECIFICATIONS.

11. THE CONTRACTOR SHALL PROVIDE SOLID BLOCKING, UNLESS NOTED OTHERWISE AS REQUIRED FOR NAILING OF ALL INTERIOR AND EXTERIOR TRIMS, FINISHES, AND SHALL PROVIDE FOR ALL THE NECESSARY FRAMING AND BRACING FOR THE INSTALLATIONS OF NIC.

12. ALL BUILDING ENTRANCES SHALL BE ACCESSIBLE TO AND USABLE BY PERSONS WITH DISABILITIES AND SHALL BE IDENTIFIED WITH A STANDARD SIGN (DECAL) DISPLAYING THE INTERNATIONAL SYMBOL OF ACCESSIBILITY. THE SYMBOL SHALL CONSIST OF A WHITE FIGURE ON A BLUE BACKGROUND. THE BLUE SHALL BE EQUAL TO COLOR No.15090 IN FEDERAL STANDARD 599B.

13. EXIT DOORS SHALL BE OPERABLE WITHOUT THE USE OF A KEY OR ANY SPECIAL KNOWLEDGE OR EFFORT. OR, IN GROUP A-3 B, F, M,S OR A OCCUPANCIES, KEY-LOCKING HARDWARE MAY BE USED ON THE MAIN EXIT DOOR (S) IF THERE IS A READILY VISIBLE, DURABLE SIGN ATTACHED ON OR ADJACENT TO EACH DOOR STATING. "THIS DOOR TO REMAIN UN-LOCKED WHEN BUILDING IS OCCUPIED." THE SIGN SHALL BE IN 1" HIGH LETTERS ON A CONTRASTING BACKGROUND. WHEN UNLOCKED, THE DOOR (S) MUST BE FREE TO SWING WITHOUT THE OPERATION OF ANY LATCHING DEVICE. (LE, PUSH-PULL).

14. PROVIDE EXIT SIGNS AT ALL LEGAL EXITS AS REQUIRED BY CODE. EXIT SIGNS, WHERE INDICATED ON PLANS, SHALL BE ILLUMINATED AND READ "EXIT" IN 6 INCH HIGH LETTERS. EXIT SIGNS SHALL BE ON SEPARATE CIRCUIT AND INDEPENDENTLY CONTROLLED. REFER TO ELECTRICAL DRAWINGS.

15. EXITS SHALL BE ILLUMINATED WITH A LIGHT INTENSITY OF ONE FOOTCANDLE AT FLOOR LEVEL MINIMUM. PROVIDE SEPARATE SOURCES OF POWER (GENERATOR OR BATTERIES) FOR EXIT ILLUMINATION WHEN THE OCC. LOAD EXCEEDS 100.

16. ANY SPACE WITH AN OCCUPANT LOAD EXCEEDING 50 SHALL HAVE AN OCCUPANT LOAD SIGN POSTED OVER THE MAIN EXIT WITH 1" HIGH LETTERS ON A CONTRASTING BACKGROUND, AND INTERNALLY ILLUMINATED EXIT SIGNS WITH A FACE LUMINANCE OF 5.0 FOOTCANDLES POSTED AT ALL EXITS.

17. ALL EXTERIOR OR INTERIOR WALL DIMENSIONS ARE TO FACE OF STUD OR MASONRY, UNLESS OTHERWISE NOTED.

18. PROVIDE VENTILATION FOR ALL ELECTRICAL AND TELEPHONE EQUIPMENT ROOMS.

19. THE BUILDING SHALL BE MECHANICALLY VENTILATED. THE SYSTEM SHALL BE CAPABLE OF SUPPLYING A MINIMUM OF 15 CUBIC FEET PER MINUTE OF OUTSIDE AIR PER OCCUPANT IN ALL PORTIONS OF THE BUILDING. TOILET ROOMS SHALL BE PROVIDED WITH A MECHANICALLY OPERATED EXHAUST SYSTEM CAPABLE OF PROVIDING A COMPLETE AIR CHANGE EVERY 15 MINUTES. REFER TO MECHANICAL DRAWINGS.

20. SET DOORJAMB 2" FROM THE NEAREST FACE OF WALL, U.N.O. THRESHOLDS SHALL HAVE A MAXIMUM HEIGHT OF? WITH A MAXIMUM

21. BUILDING ADDRESS NUMBERS SHALL BE PROVIDED ON THE FRONT OF THE BUILDING, SHALL BE VISIBLE AND LEGIBLE FROM THE STREET FRONTING THE PROPERTY, AND SHALL CONTRAST WITH THEIR BACKGROUND.

22. SEPARATE APPROVAL FOR TEMPORARY OR PERMANENT SIGNAGE IS REQUIRED FROM THE CITY.

23. THE CONTRACTOR SHALL VERIFY LOCATION AND SIZE OF ALL FLOOR, ROOF, AND WALL OPENINGS WITH ALL APPLICABLE DRAWINGS. THE CONTRACTOR SHALL VERIFY INSERTS AND EMBEDDED ITEMS WITH ALL APPLICABLE DRAWINGS PRIOR TO POURING CONCRETE.

24. KEEP DUCT, PIPING, CONDUITS, ETC. AS CLOSE TO WALLS AND AS HIGH TO UNDERSIDE OF ROOF FRAMING AS POSSIBLE EXPOSED WORK IN FINISHED AREAS WILL NOT BE ACCEPTED. U.N.O.

25. WHERE LARGER STUDS OR FURRING ARE REQUIRED TO COVER DUCTS, PIPING CONDUIT, ETC. THE LARGER STUD OR FURRING SHALL EXTEND THE FULL LENGTH OF THE SURFACE INVOLVED, U.N.O.

26. PROVIDE METAL TRIM OR CASING AT ALL EDGES OF PLASTER OR DRYWALL WHERE IT TERMINATES OR MEETS ANY OTHER MATERIAL,

27. PRIOR TO REQUESTING A FOUNDATION INSPECTION, THE CONTRACTOR SHALL HAVE A REGISTERED ENGINEER FIELD VERITY THE BUILDING PAD HEIGHT AND SUBMIT A LETTER TO THE CITY ENGINEER, OWNER & ARCHITECT, CERTIFYING THE BUILDING PAD HEIGHT AS COMPLYING WITH THE APPROVED GRADING PLAN.

28. ALL EXTERIOR EXPOSED METAL (TRIMS, AILING, FRAMES, NUTS, BOLTS, FASTENERS, MOULDINGS, ETC.) SHALL BE PAINTED, UNLESS

29. PROVIDE ISOLATION OF ALL DISSIMILAR METALS (ALUMINUM, COPPER, STEEL, ETC.) FROM EACH OTHER.

30. ALL EXTERIOR WALL OPENINGS, FLASHINGS, COPINGS AND EXPANSIONS JOINTS SHALL BE WEATHERPROOF.

31. SIZES OF MECHANICAL EQUIPMENT PADS, BASES, ROOF EQUIPMENT PADS, AND OPENINGS ARE A BASIS FOR DESIGN ONLY. CONTRACTOR SHALL VERIFY ALL DIMENSIONS MANUFACTURERS. MECHANICAL CONTRACTOR SHALL VERIFY ALL SIZES AND LOCATIONS OF

32. IF THERE ARE ANY TRENCHES OR EXCAVATIONS FIVE FEET OR MORE IN DEPTH INTO WHICH A PERSON IS REQUIRED TO DESCEND, THE CONTRACTOR SHALL OBTAIN THE NECESSARY PERMIT FROM THE CALIFORNIA STATE DIVISION OF INDUSTRIAL SAFETY. THE CONTRACTOR SHALL PROVIDE TEMPORARY SHORING AS NECESSARY TO PROTECT ADJACENT STRUCTURES, PROPERTIES, OR PUBLIC WAYS. MAINTAIN A MINIMUM OF 1" CLEARANCE BETWEEN PROPERTY LINES AND ANY NEW CONSTRUCTION SUCH AS WALLS, FOOTINGS, ETC.

33. SUSPENDED ACOUSTICAL CEILING SYSTEMS SHALL COMPLY WITH UBC TABLES 25-A AND 16-O.

34. PROVIDE PIPING INSULATION AND AIR HANDLING DUCT INSULATION IN ACCORDANCE WITH THE STANDARDS OF THE CALIFORNIA ENERGY COMMISSION. DUCTWORK SHALL BE CONSTRUCTED, ERECTED, AND TESTED IN ACCORDANCE WITH THE PROCEDURES DETAILED IN THE ASHRAE HANDBOOK OF FUNDAMENTALS OR APPLICABLE SMACNA STANDARDS. PROVIDE MASTIC OR DUCT TAPE SEALER AT ALL

35. THE CONTRACTOR SHALL POST, ADJACENT TO THE BUILDING PERMIT, INSTALLATION CERTIFICATES FOR MANUFACTURED DEVICES REGULATED BY THE CALIFORNIA APPLIANCE EFFICIENCY STANDARDS INDICATING FEATURES REQUIRED TO VERIFY COMPLIANCE, A STATEMENT THAT INSTALLED DEVICES CONFORM WITH THE STANDARDS, REQUIREMENTS FOR SUCH DEVICES IN THE APPROVED PLANS AND SPECIFICATIONS, AND THE PERMIT NUMBER.

36. THE CONTRACTOR SHALL PROVIDE THE OWNER WITH A LIST OF THE HEATING, COOLING, WATER HEATING, LIGHTING, AND CONSERVATION SYSTEMS, FEATURES, MATERIALS, COMPONENTS, AND DEVICES INSTALLED IN THE BUILDING AND INSTRUCTIONS ON HOW TO USE THEM; LABLES ON MANUFACTURED DEVICES CLEARLY STATING ROUTINE MAINTENAMNCE ACTION: AND A DESCRIPTION OF THE QUANTITIES OF OUTDOOR AND RECIRCULATED AIR THAT THE VENTILATION SYSTEM IS DESIGNED TO PROVIDE EACH AREA.

37. NO ALCOHOLIC BEVERAGE SALES ARE PERMITTED. CONDITIONAL USE PERMIT IS REQUIRED.

38. PROVIDE A LEVEL LANDING (DEFINED AS A 2% MAXIMUM SLOPE IN ANY DIRECTION) EXTENDING 5 FEET IN FRONT OF ALL DOORS. ALL WALKING SURFACES SHALL BE SLIP-RESISTANT.

39. LOCATE ALL MANUALLY OPERATED SWITCHES CENTERED 40" ABOVE SLAB FLOOR TYPICAL, BETWEEN 36" AND 48" A.F.F. LOCATE CONVENIENCE OUTLETS CENTERED 16" ABOVE SLAB FLOOR TYPICAL 15" ABOVE FINISH FLOOR MINIMUM.

40. A CERTIFICATE OF WORKMAN'S COMPENSATION INSURANCE MUST BE PRESENTED TO THE BUILDING & SAFETY OFFICE BEFORE A

EXTERIOR REMODELING FOR HAMPTON INN

767 EAST ALBERTONI STREET CARSON, CA 90746

ARREVIATIONS

	ABBREVIATIONS				
	A.C.	ASPHALTIC CONCRETE	LAV.	LAVATORY	
	A/C	AIR CONDITIONING	LB.	POUND	
	A.F.F.	ABOVE FINISHED FLOOR	L.F.	LINEAR FOOT(FEET)	
	AC.T. ADMIN.	ACOUSTIC TILE ADMINISTRATION	LVR. LT.WT.	LOUVER LIGHTWEIGHT	
		ALUMINUM		LIGHTWEIGHT	
	ALT.	ALTERNATE	MAS.	MASONRY	
	AMT. ANOD	AMOUNT ANODIZE(D)	MATL. MAX.	MATERIAL MAXIMUM	
	ASPH.	ASPHALT	M.B.	MACHINE BOLT	
	DD	DOADD	MECH.	MECHANIC(AL)	
	BD. BIT.	BOARD BITUMINOUS	MEMBR. MFR.	MEMBRANE MANUFACTURER	
	BLD'G	BUILDING	MIN.	MINIMUM	
	BLKG BM	BLOCKING BEAM	MISC.	MISCELLANEOUS	
)	DI⁴I	DEAM	MTL.	MOUNT(ED)(ING) METAL	
	C.B.	CATCH BASIN		/	
	CEM. C.F.	CEMENT CUBIC FEET	(N) N/C	NEW NOT APPLICABLE	
	C.J.	CONTROL JOINT	N.I.C.	NOT APPLICABLE NOT IN CONTRACT	
	CLG.	CEILING	NO.	NUMBER	
	CLR. CMU	CLEAR CONCRETE MASONRY UNITS	N.R.C. N.T.S.	NOISE REDUCTION COEFFICIENT NOT TO SCALE	
	COL.	COLUMN	N.T.S.	NOT TO SCALL	
	CONC.	CONCRETE	O.C.	ON CENTER	
	CONT. CORR.	CONTINUOUS CORRIDOR	O.D. O.F.D.	OUTSIDE DIAMETER OVERFLOW DRAIN	
	C.T.	CERAMIC TILE	OPEN'G	OPENING	
.	DEMO.	DEMOLITION	O.P.C.I.	OWNER PROVIDED	
	DEMO. DET.	DETAIL	OPP.	CONTRACTOR INSTALLED OPPOSITE	
	D.F.	DRINKING FOUNTAIN			
	DIA. DIM.	DIAMETER DIMENSION	PAV. P.H.	PAVING, PAVEMENT PANIC HARDWARE	
	DIM. DISP.	DISPENSER, DISPOSAL	P.n. PL.	PLATE	
	DN	DOWN	P.LAM.	PLASTIC LAMINATE	
	DR. D.S.	DOOR DOWNSPOUT	PLAS. PLBG.	PLASTER, PLASTIC PLUMBING	
	DTL.	DETAIL	PLYWD	PLYWOOD	
	DWG.	DRAWINGS	PNT.	PAINT	
	(E)	EXISTING	PREFAB. PREFIN.	PREFABRICATE(D) PREFINISH(ED)	
	EA.	EACH	P.S.F.	POUNDS PER SQUARE FOOT	
	E.J.	EXPANSION JOINT	P.S.I.	POUNDS PER SQUARE INCH	
	ELEV. E.P.	ELEVATION, ELEVATOR ELECTRICAL PANEL	PTD.	PAINTED	
	EQ.	EQUAL	QUAL.	QUALITY	
	EQUIP. EXH.	EQUIPMENT EXHAUST	QUAN.	QUANTITY	
	EXTG.	EXISTING	R.B.	RUBBER BASE	
	EXP.	EXPAND(SION), EXPOSED	R.C.P.	REINFORCED CONCRETE PIPE	
	F.A.	FIRE ALARM	R.D. REF.	ROOF DRAIN REFERENCE	
	F.D.	FLOOR DRAIN, FIRE DAMPER	REFRIG.	REFRIGERATOR	
	F.E.	FIRE EXTINGUISHER	REG.	REGISTER	
	F.E.C. F.F.	FIRE EXTINGUISHER CABINET FINISH FLOOR	REINF. REQ.	REINFORCEMENT REQUIRED	
	F.G.	FINISH GRADE	RET.	RETAINING	
	F.H.C. F.H.R.	FIRE HOSE CABINET FIRE HOSE RACK	R.L. RM	ROOF LEADER, RAIN LEADER	
	FIN.	FINISH	RT.	ROOM RIGHT	
	FL.	FLOOR			
	FLASH. FND.	FLASHING FOUNDATION	S.C. SCHED.	SOLID CORE SCHEDULE	
	F.O.C.	FACE OF CONCRETE	S.D.	STORM DRAIN, SOAP DISPENSER	
	F.O.F.	FACE OF FINISH FACE OF MASONRY	S.F.	SQUARE FOOT(FEET)	
	F.O.M. F.O.S.	FACE OF MASONRY FACE OF STUDS	SHT. SHTG.	SHEET SHEATING	
	FT.	FOOT, FEET	SIM.	SIMILAR	
	FTG.	FOOTING	SPEC. STD.	SPECIFICATION STANDARD	
	GA.	GAUGE	STL.	STEEL	
	GALV.	GALVANIZED	STO.	STORAGE	
	G.C. GL.	GENERAL CONTRACTOR GLASS, GLAZING	S'STL. STRUCT.	STAINLESS STEEL STRUCTURAL	
	GR.	GRADE	SUSP.	SUSPENDED	
	GRD. GYP.	GUARD GYPSUM	т	TREAD THE TOHET	
	GYP. BD.	GYPSUM BOARD	T. TEL.	TREAD, TILE, TOILET TELEPHONE	
			TEMP.	TEMPORARY	
	H.B. H.C.	HOSE BIBB HOLLOW CORE	T.O.C. T.O.CONC.	TOP OF CURB TOP OF CONC.	
	HD.	HEAD	T.O.M.	TOP OF MASONRY	
	HDWD	HARDWOOD	T.O.P.	TOP OF PARAPET	
	HDWR. HM	HARDWARE HOLLOW METAL	T.O.S. T.O.W.	TOP OF SLAB TOP OF WALL	
	HORIZ.	HORIZONTAL	TR.	TRENCH	
	HT. HVAC	HEIGHT	TYP.	TYPICAL	
	ПVАС	HEATING, VENTILATION AND AIR CONDITIONING	U.N.O.	UNLESS NOTED OTHERWISE	
	HYD.	HYDRANT			
:	I.C.	INTERCOM	V.B. V.C.T.	VAPOR BARRIER, VINYL BASE VINYL COMPOSITION FLOOR TILE	
	I.D.	INSIDE DIAMETER	VERT.	VERTICAL VERTICAL	
	INFO.	INFORMATION	VEST.	VESTIBULE	
₹	INSUL. INT.	INSULATION INTERIOR	V.I.F. V.T.	VERIFY IN FIELD VINYL TILE	
	INV.	INVERT		VIIVIL IILL	
	1 D	TUNCTION DOV	W/	WITH	
	J.B. JT.	JUNCTION BOX JOINT	W/O WD	WITHOUT WOOD	
			W.I.	WROUGHT IRON	
	K.D. KIT.	KNOCK DOWN KITCHEN, KITCHENETTE	W.W.F. W.W.M.	WELDED WIRE FABRIC	
	K.O.(P)	KNOCK OUT (PANEL)	v v . v V .l*l.	WELDED WIRE MESH	

APPLICABLE BUILDING CODES		
WITH CITY OF CARSON MUNICIPAL CODE		
CALIFORNIA CODE OF REGULATIONS TITLE 24	2016	
CALIFORNIA ENERGY CODE	2016	
CALIFORNIA BUILDING CODE	2016	
CALIFORNIA MECHANICAL CODE	2016	
CALIFORNIA PLUMBING CODE	2016	
CALIFORNIA ELECTRICAL CODE & TITLE 24	2016	
CALIFORNIA FIRE CODE	2016	

BUILDING ANALYSIS

PROJECT DESCRIPTION: EXTERIOR REMODELING FOR HAMPTON INN 767 EAST ALBERTONI ST. CARSON, CA 90746 ADDRESS:

APN: 7319035015 OWNER NAME: THE OXENIA LLC BUILDING AREA: 63,618 SQFT **GENERAL PLAN:** GENERAL COMMERCIAL

ZONING: CONSTRUCTION AREA: EXTERIOR, PARAPET

TYPE OF CONSTRUCTION: TYPE V, FULLY AUTO-SPRINKLER SYS. **EXISTING USE:** 137 GUESTROOMS HOTEL

PARKING: EXISTING PARKING

SCOPE OF WORK: THE WORK INCLUDES DEMOLITION (E) ROOF & INSTALL NEW ADDITIONAL PARAPET WALL

& DECORATION MOLDING, PAINT WORK

*** NOTE: 1. EXTERIOR SIGNAGE REQUIRES SEPARATE APPROVAL & SEPARATE PERMIT


SHEET INDEX

ARCHITECTURAL

TITLE SHEET, DRAWING INDEX A1.0 SITE PLAN A1.1 (E) 1ST FLOOR PLAN (E) TYPICAL FLOOR PLAN A1.3 (E) ROOF & DEMOLITION PLAN A1 4 PROPOSED ROOF PLAN A2.0 (E)ELEVATION A2.1 (E)ELEVATION A2.2 PROPOSED ELEVATION A2.3 PROPOSED ELEVATION A2.4 DETAILS

STRUCTURAL

SECTION, DETAILS

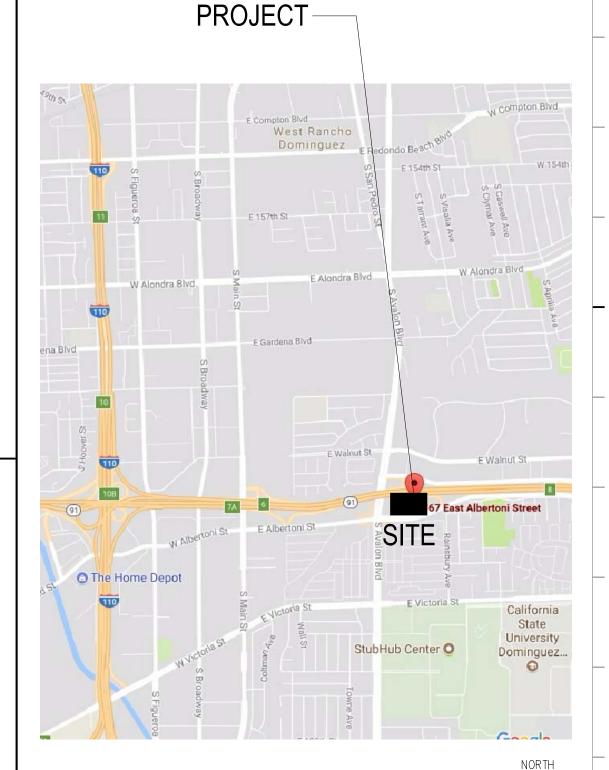



AERIAL PHOTOGRAPH 1

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HAMPTON INN

CARSON, CA 90746

Project Owner:

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> 767 EAST ALBERTONI STREET **CARSON, CA 90746**


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GENERAL NOTES



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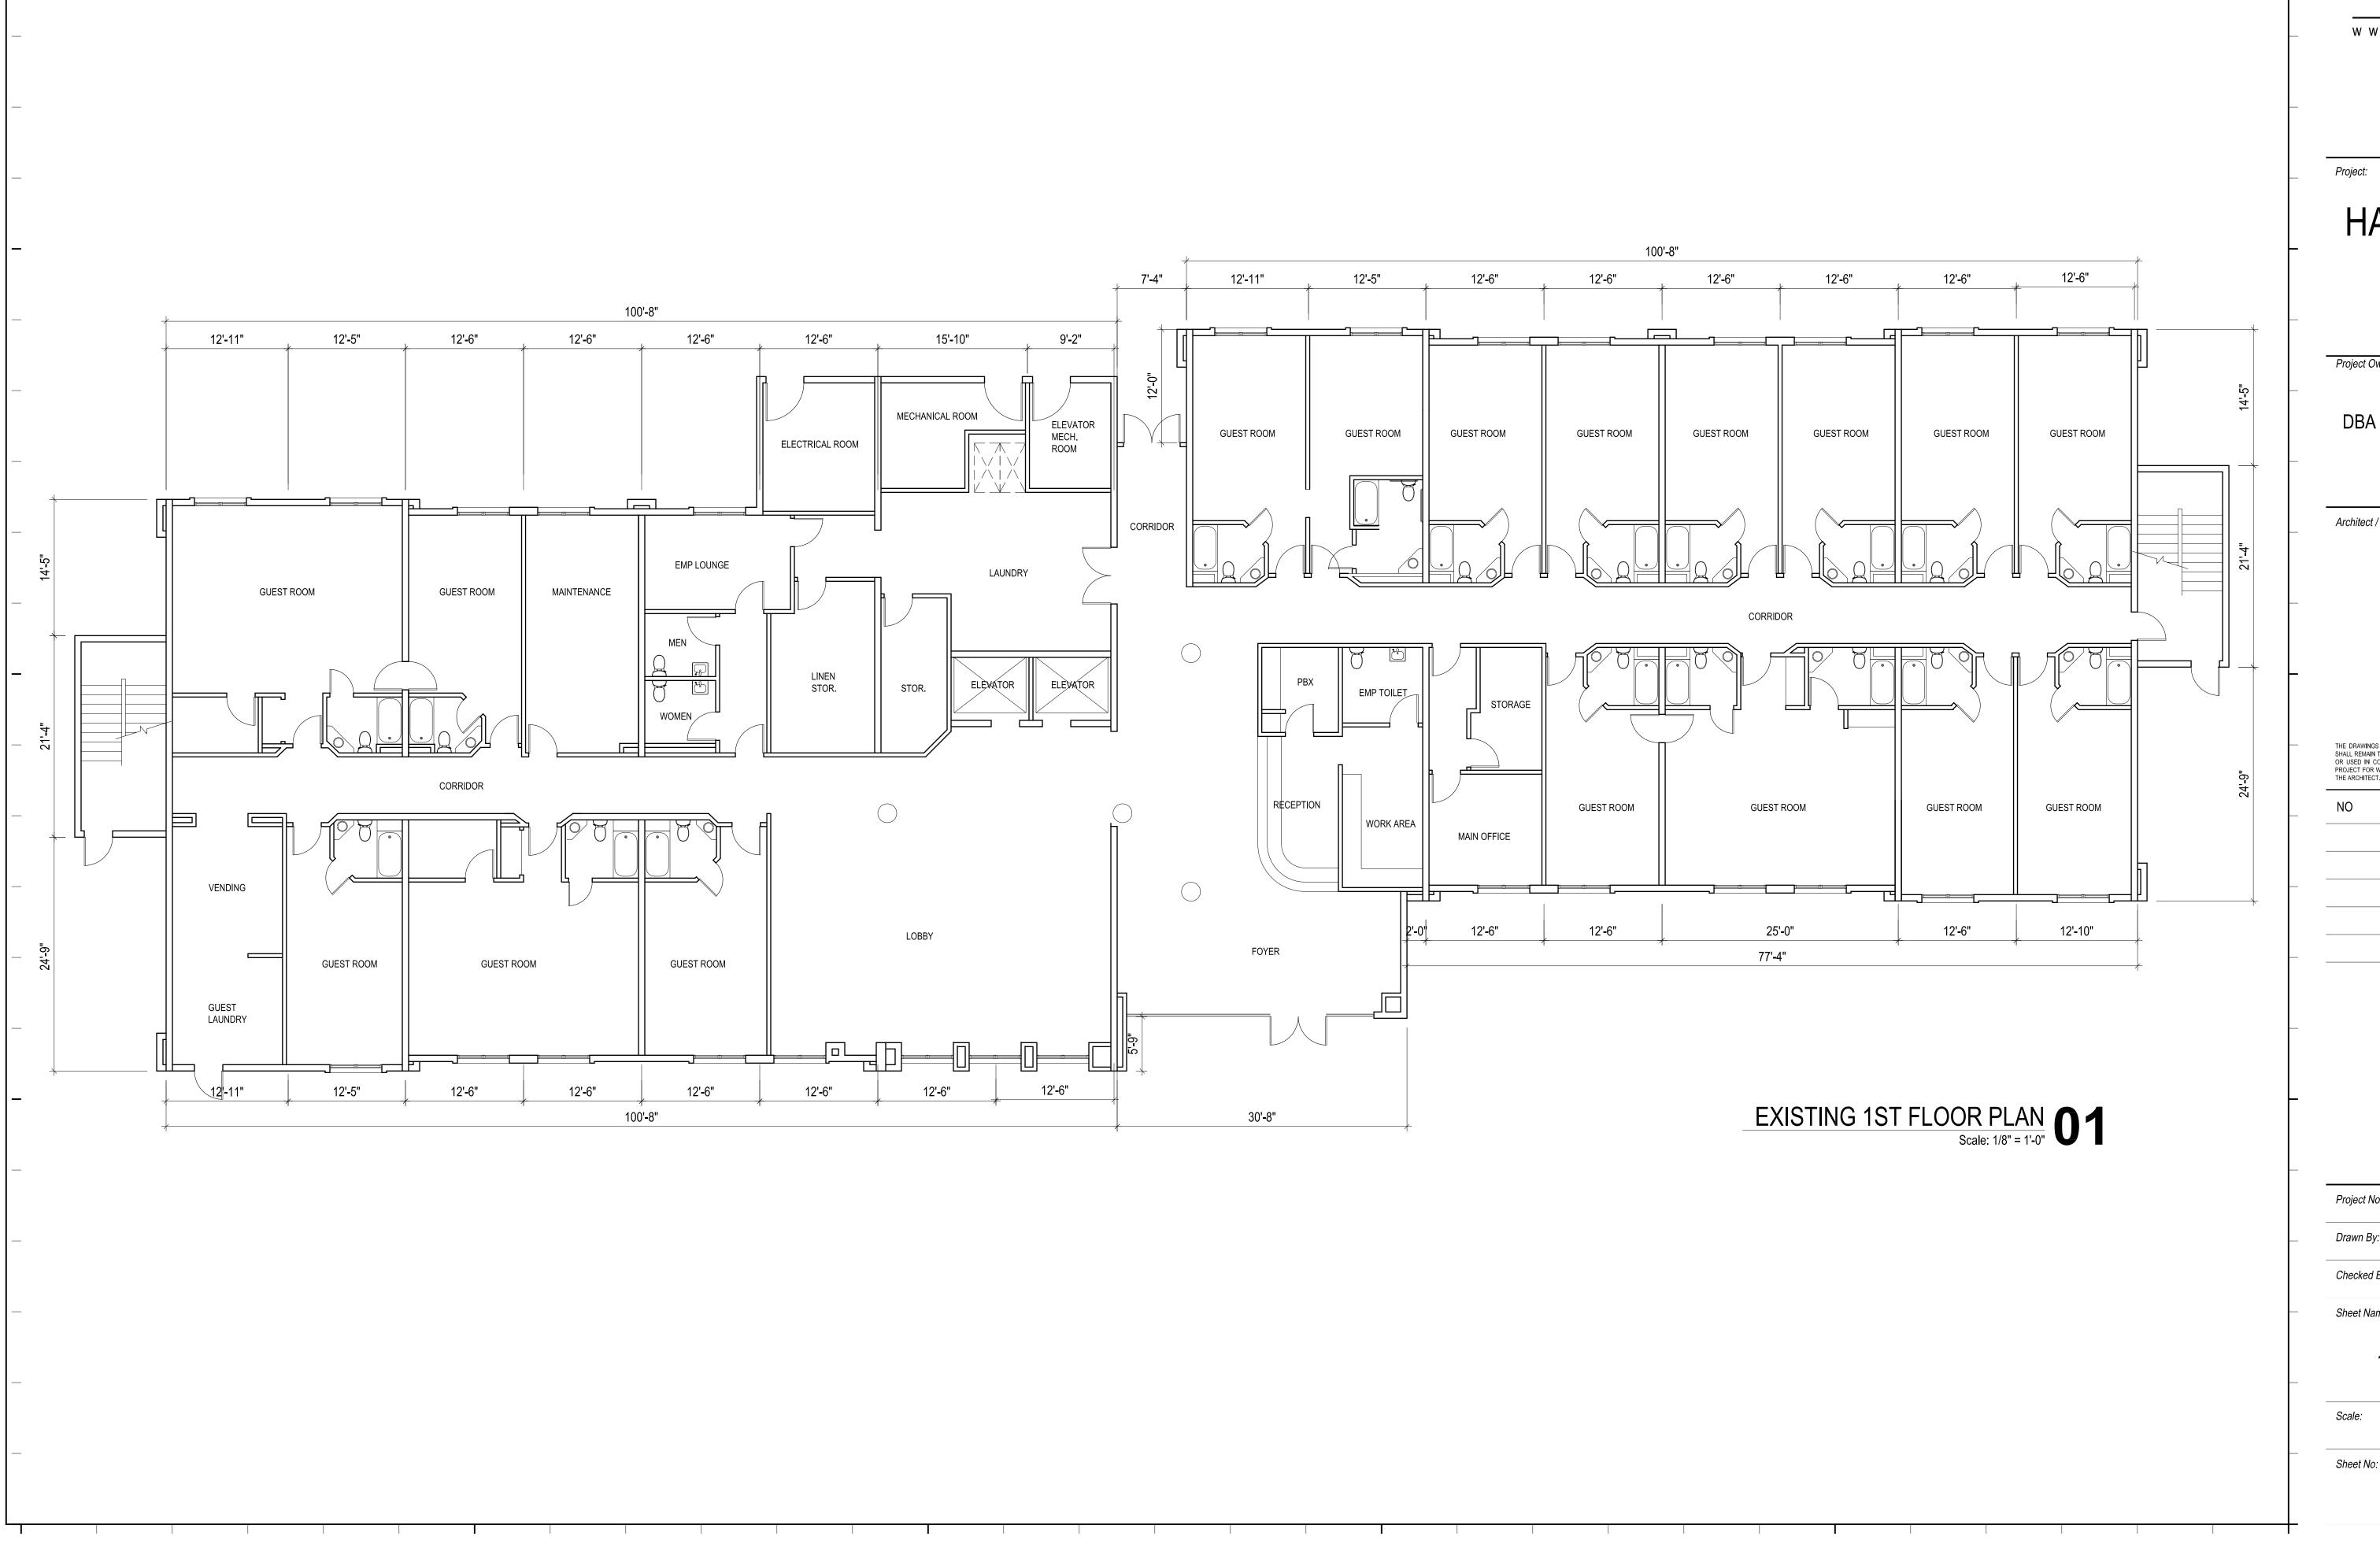
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SITE PLAN

1/16" = 1'-0"

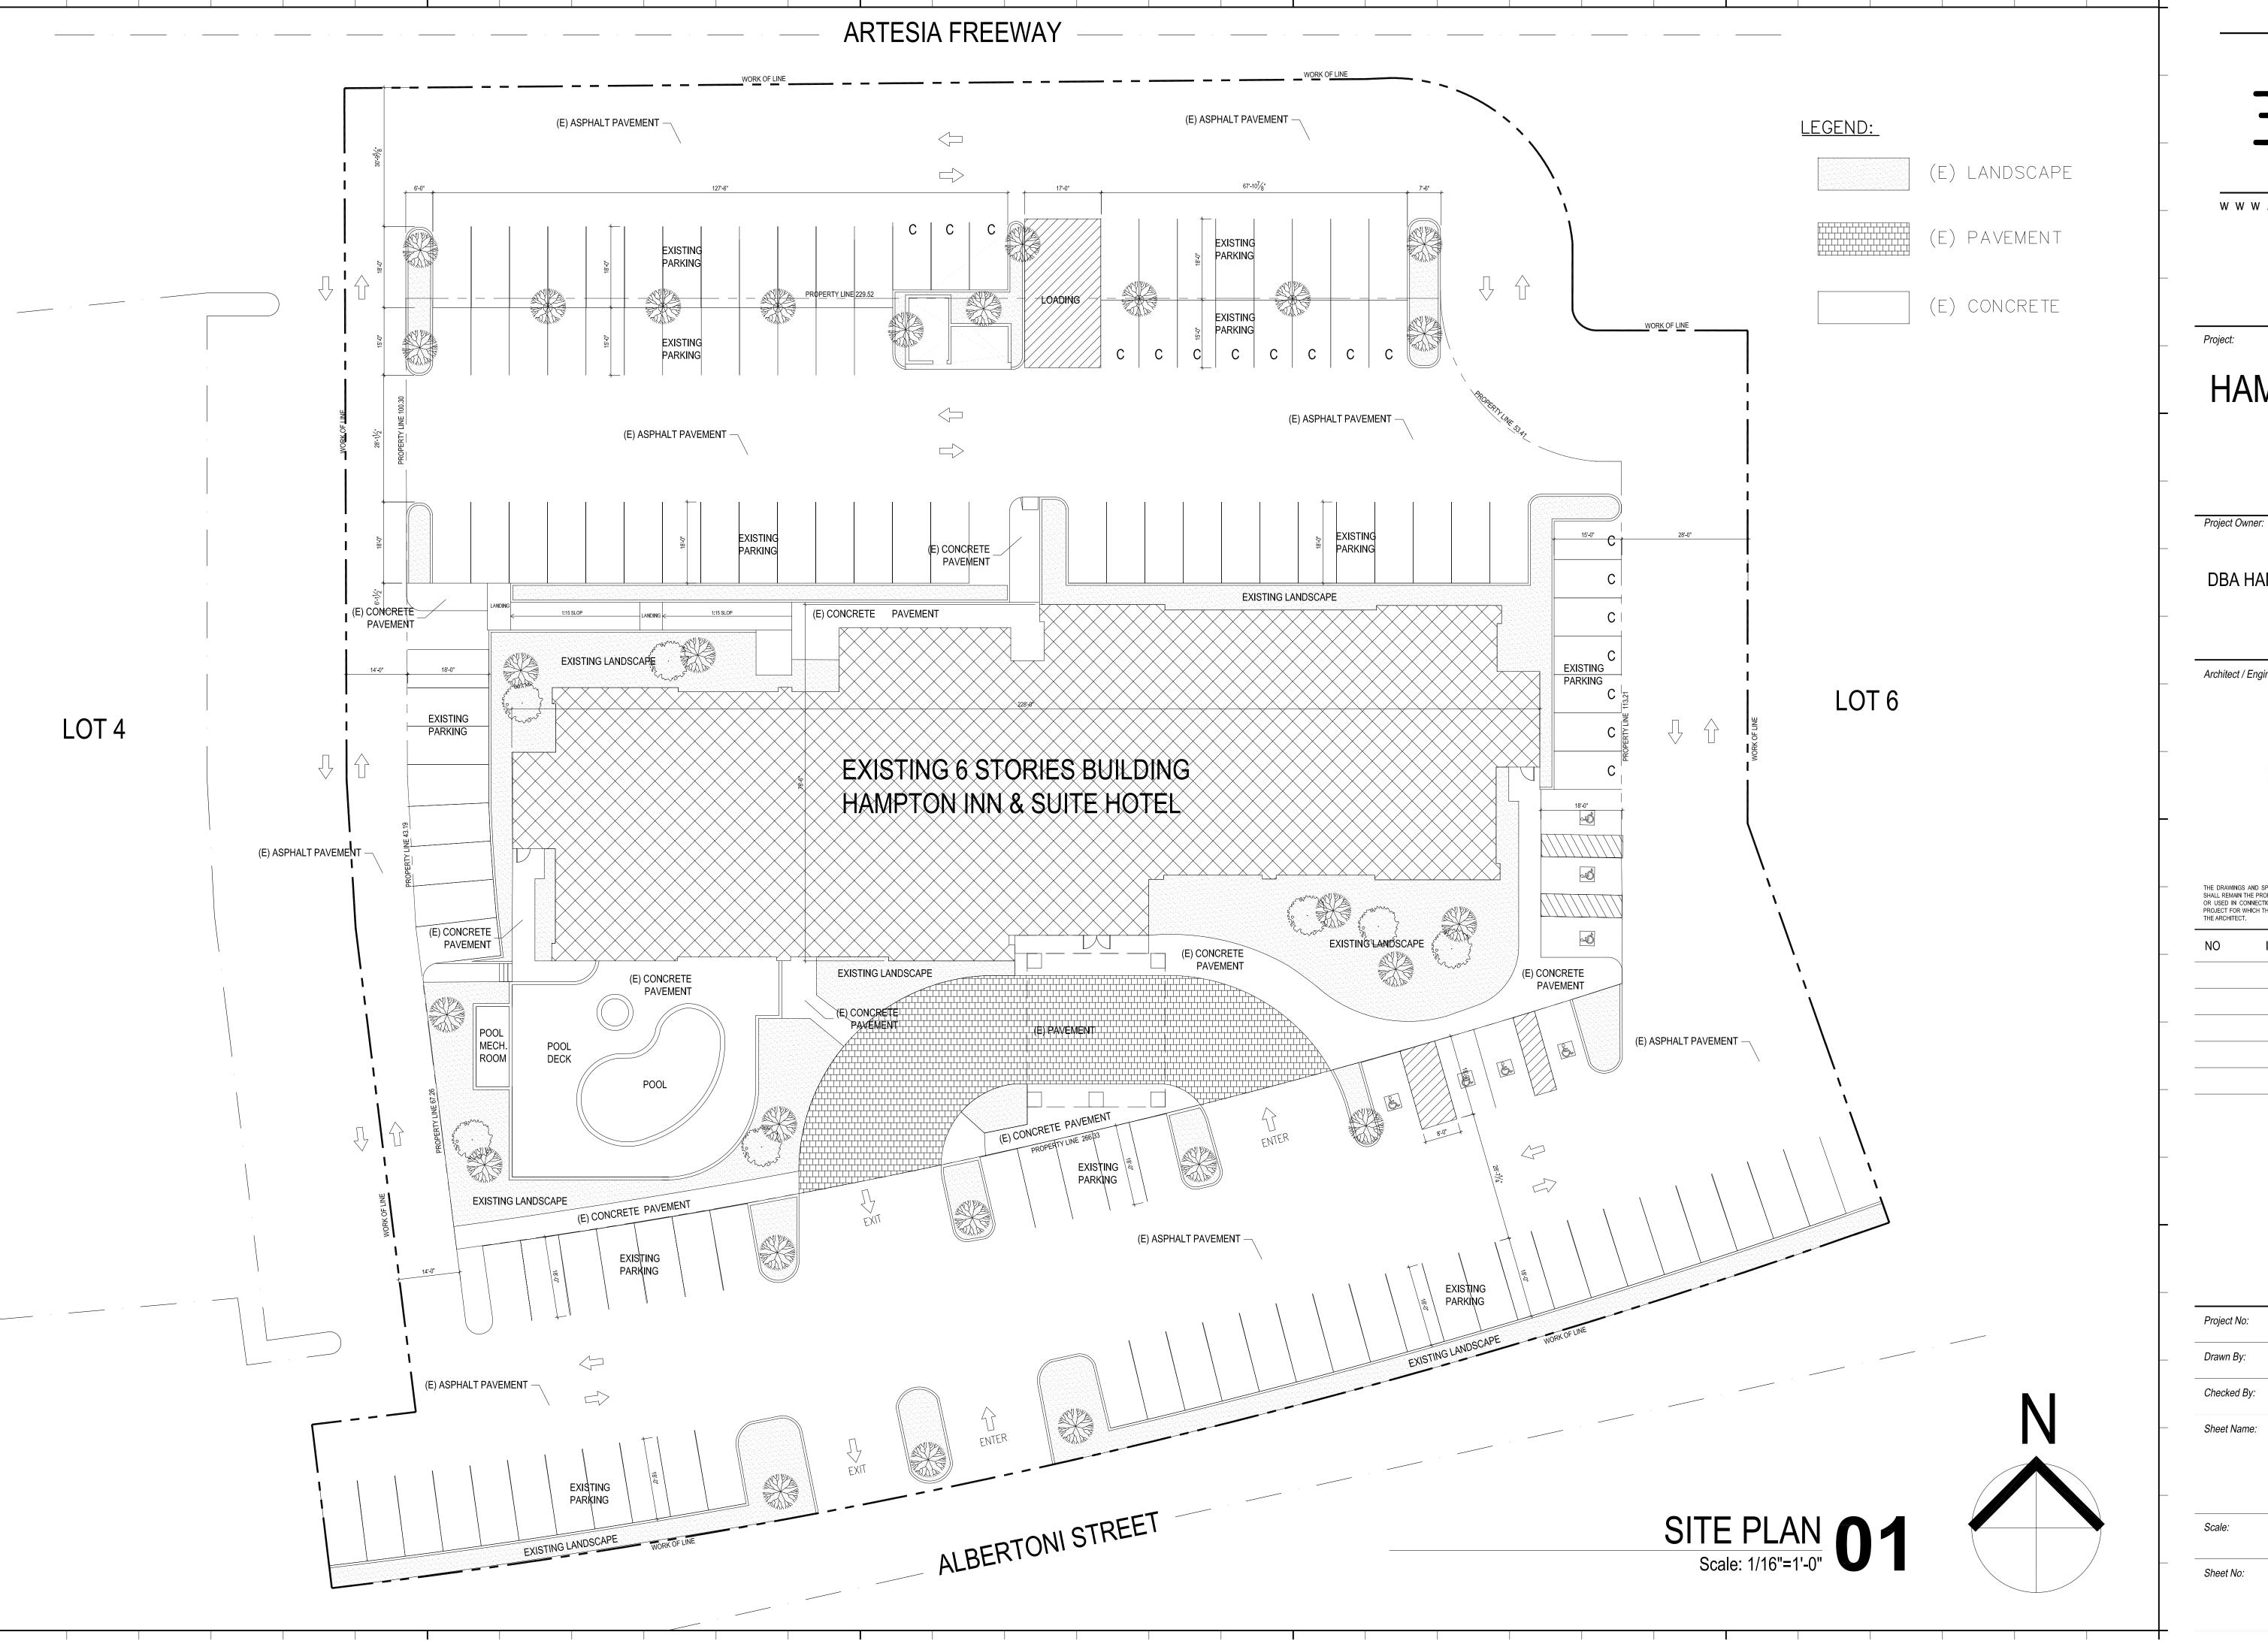

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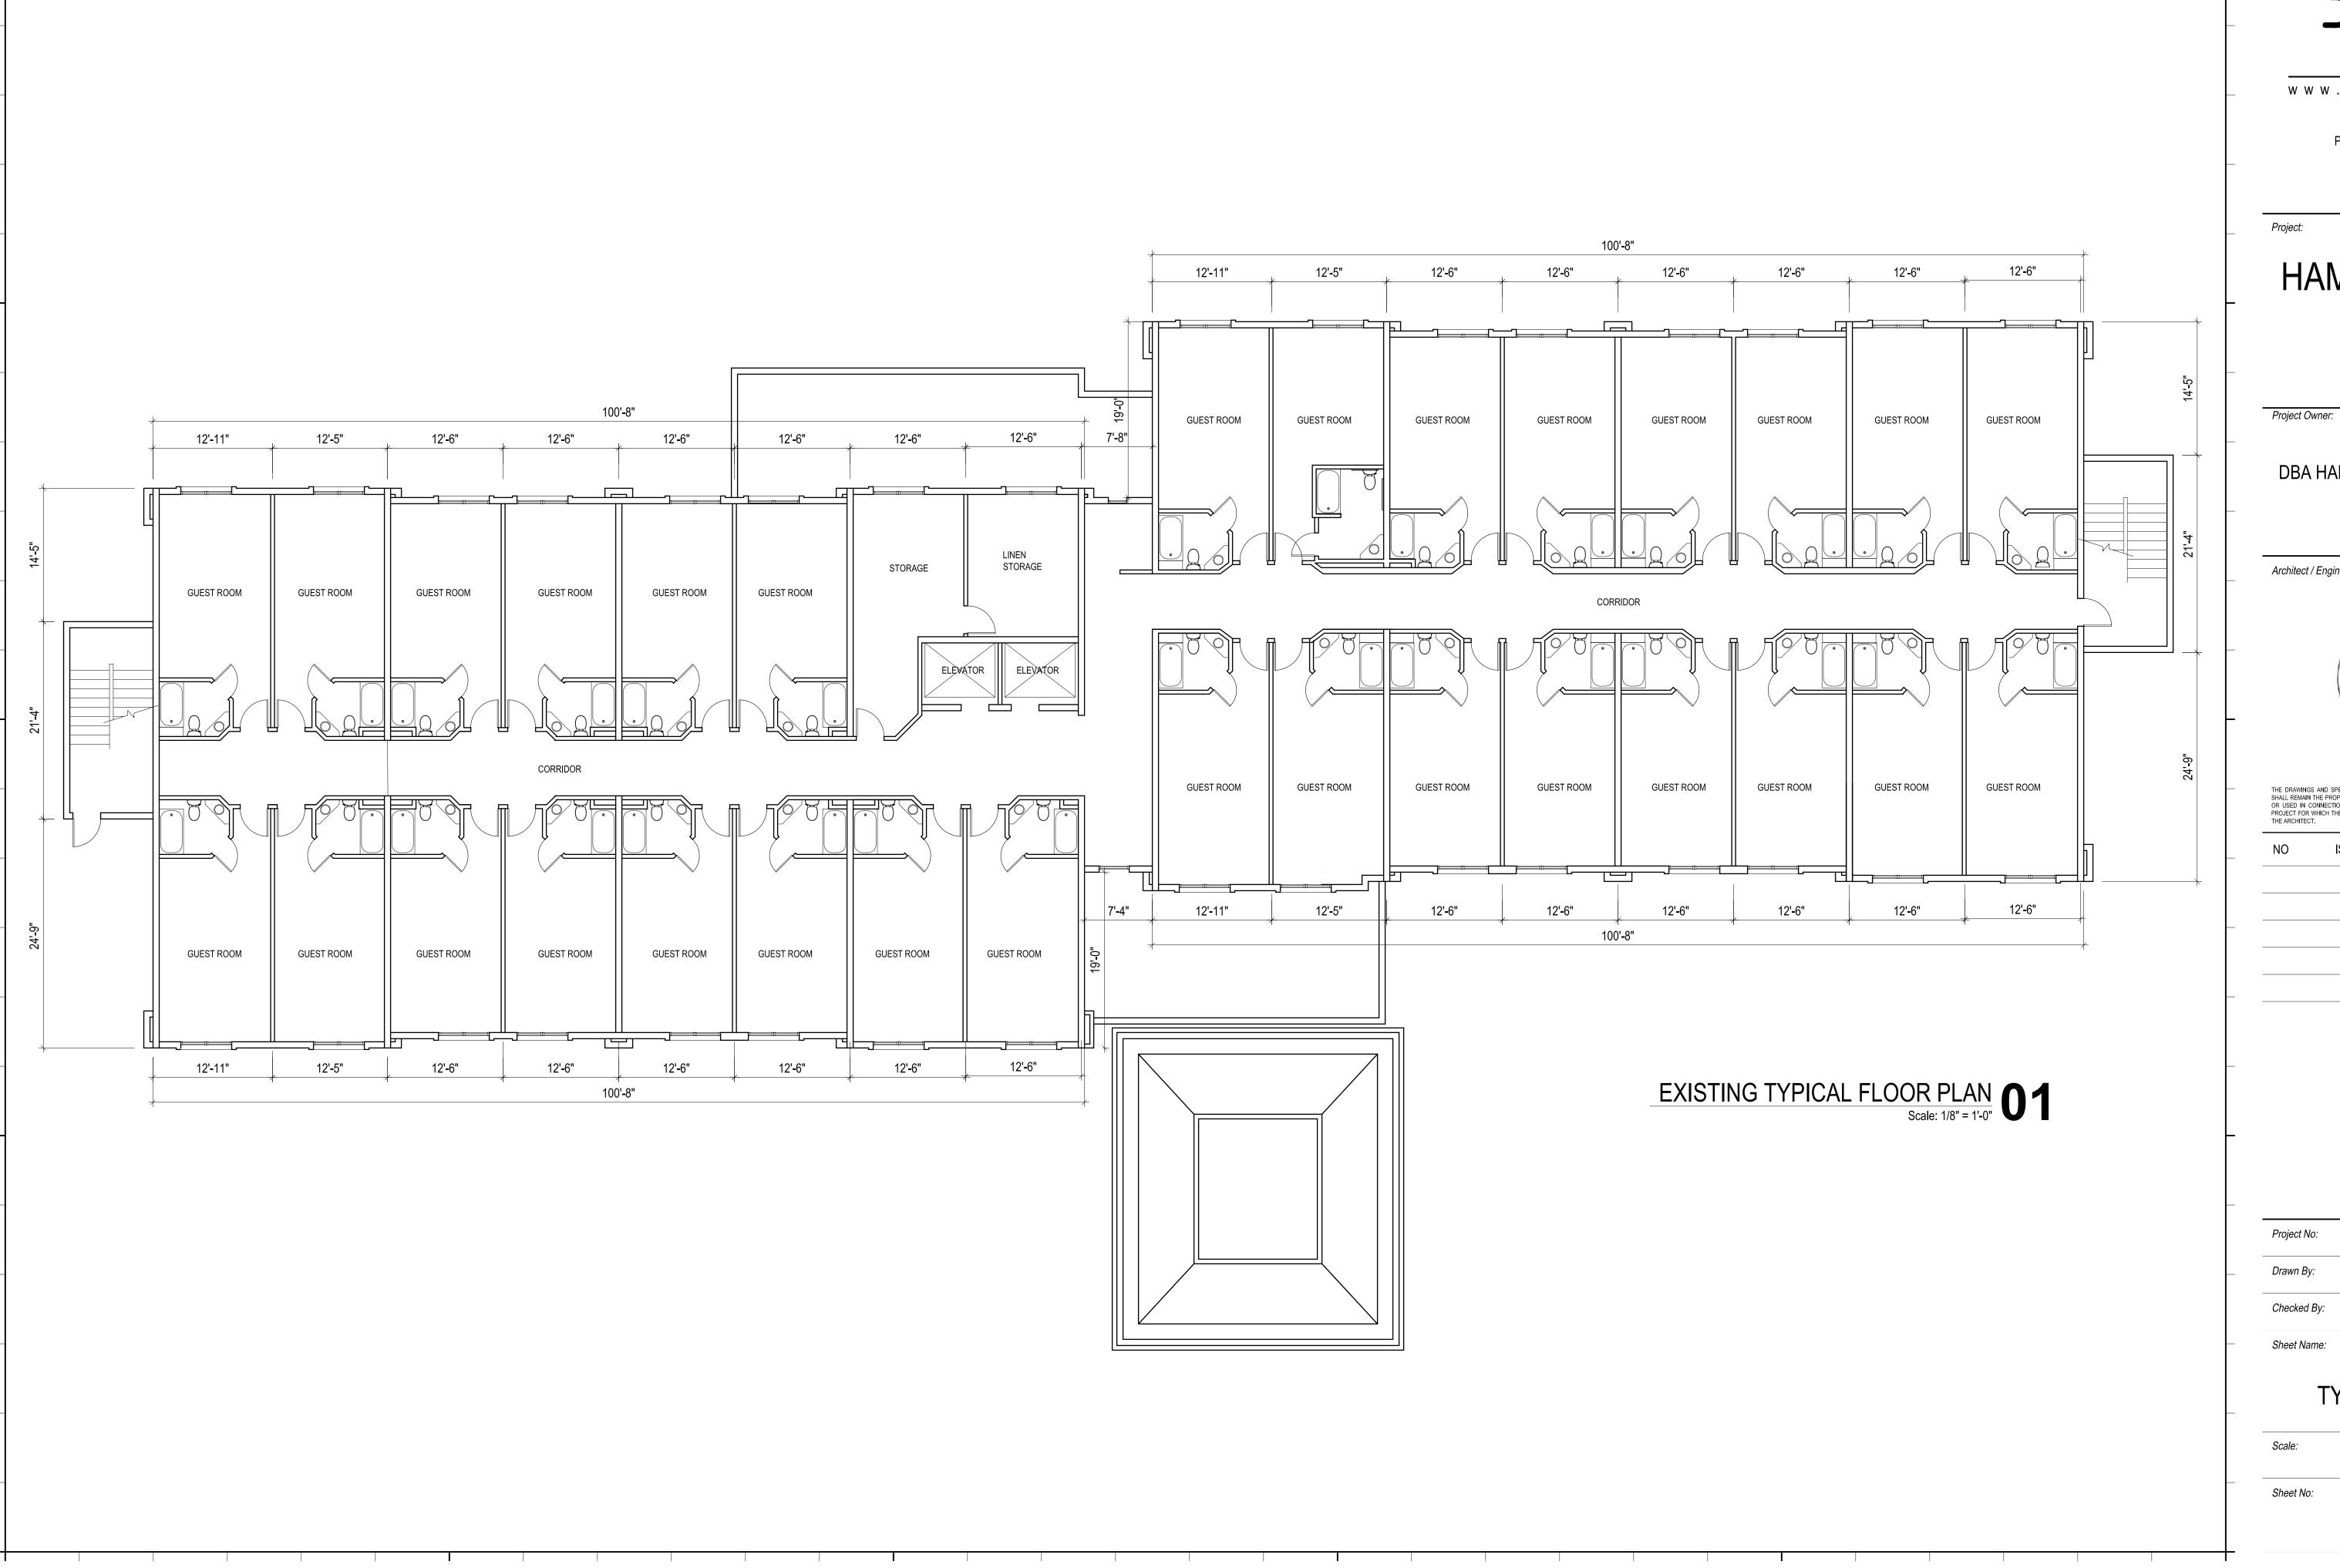
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EXISTING 1ST FLOOR PLAN

1/8"=1'-0"



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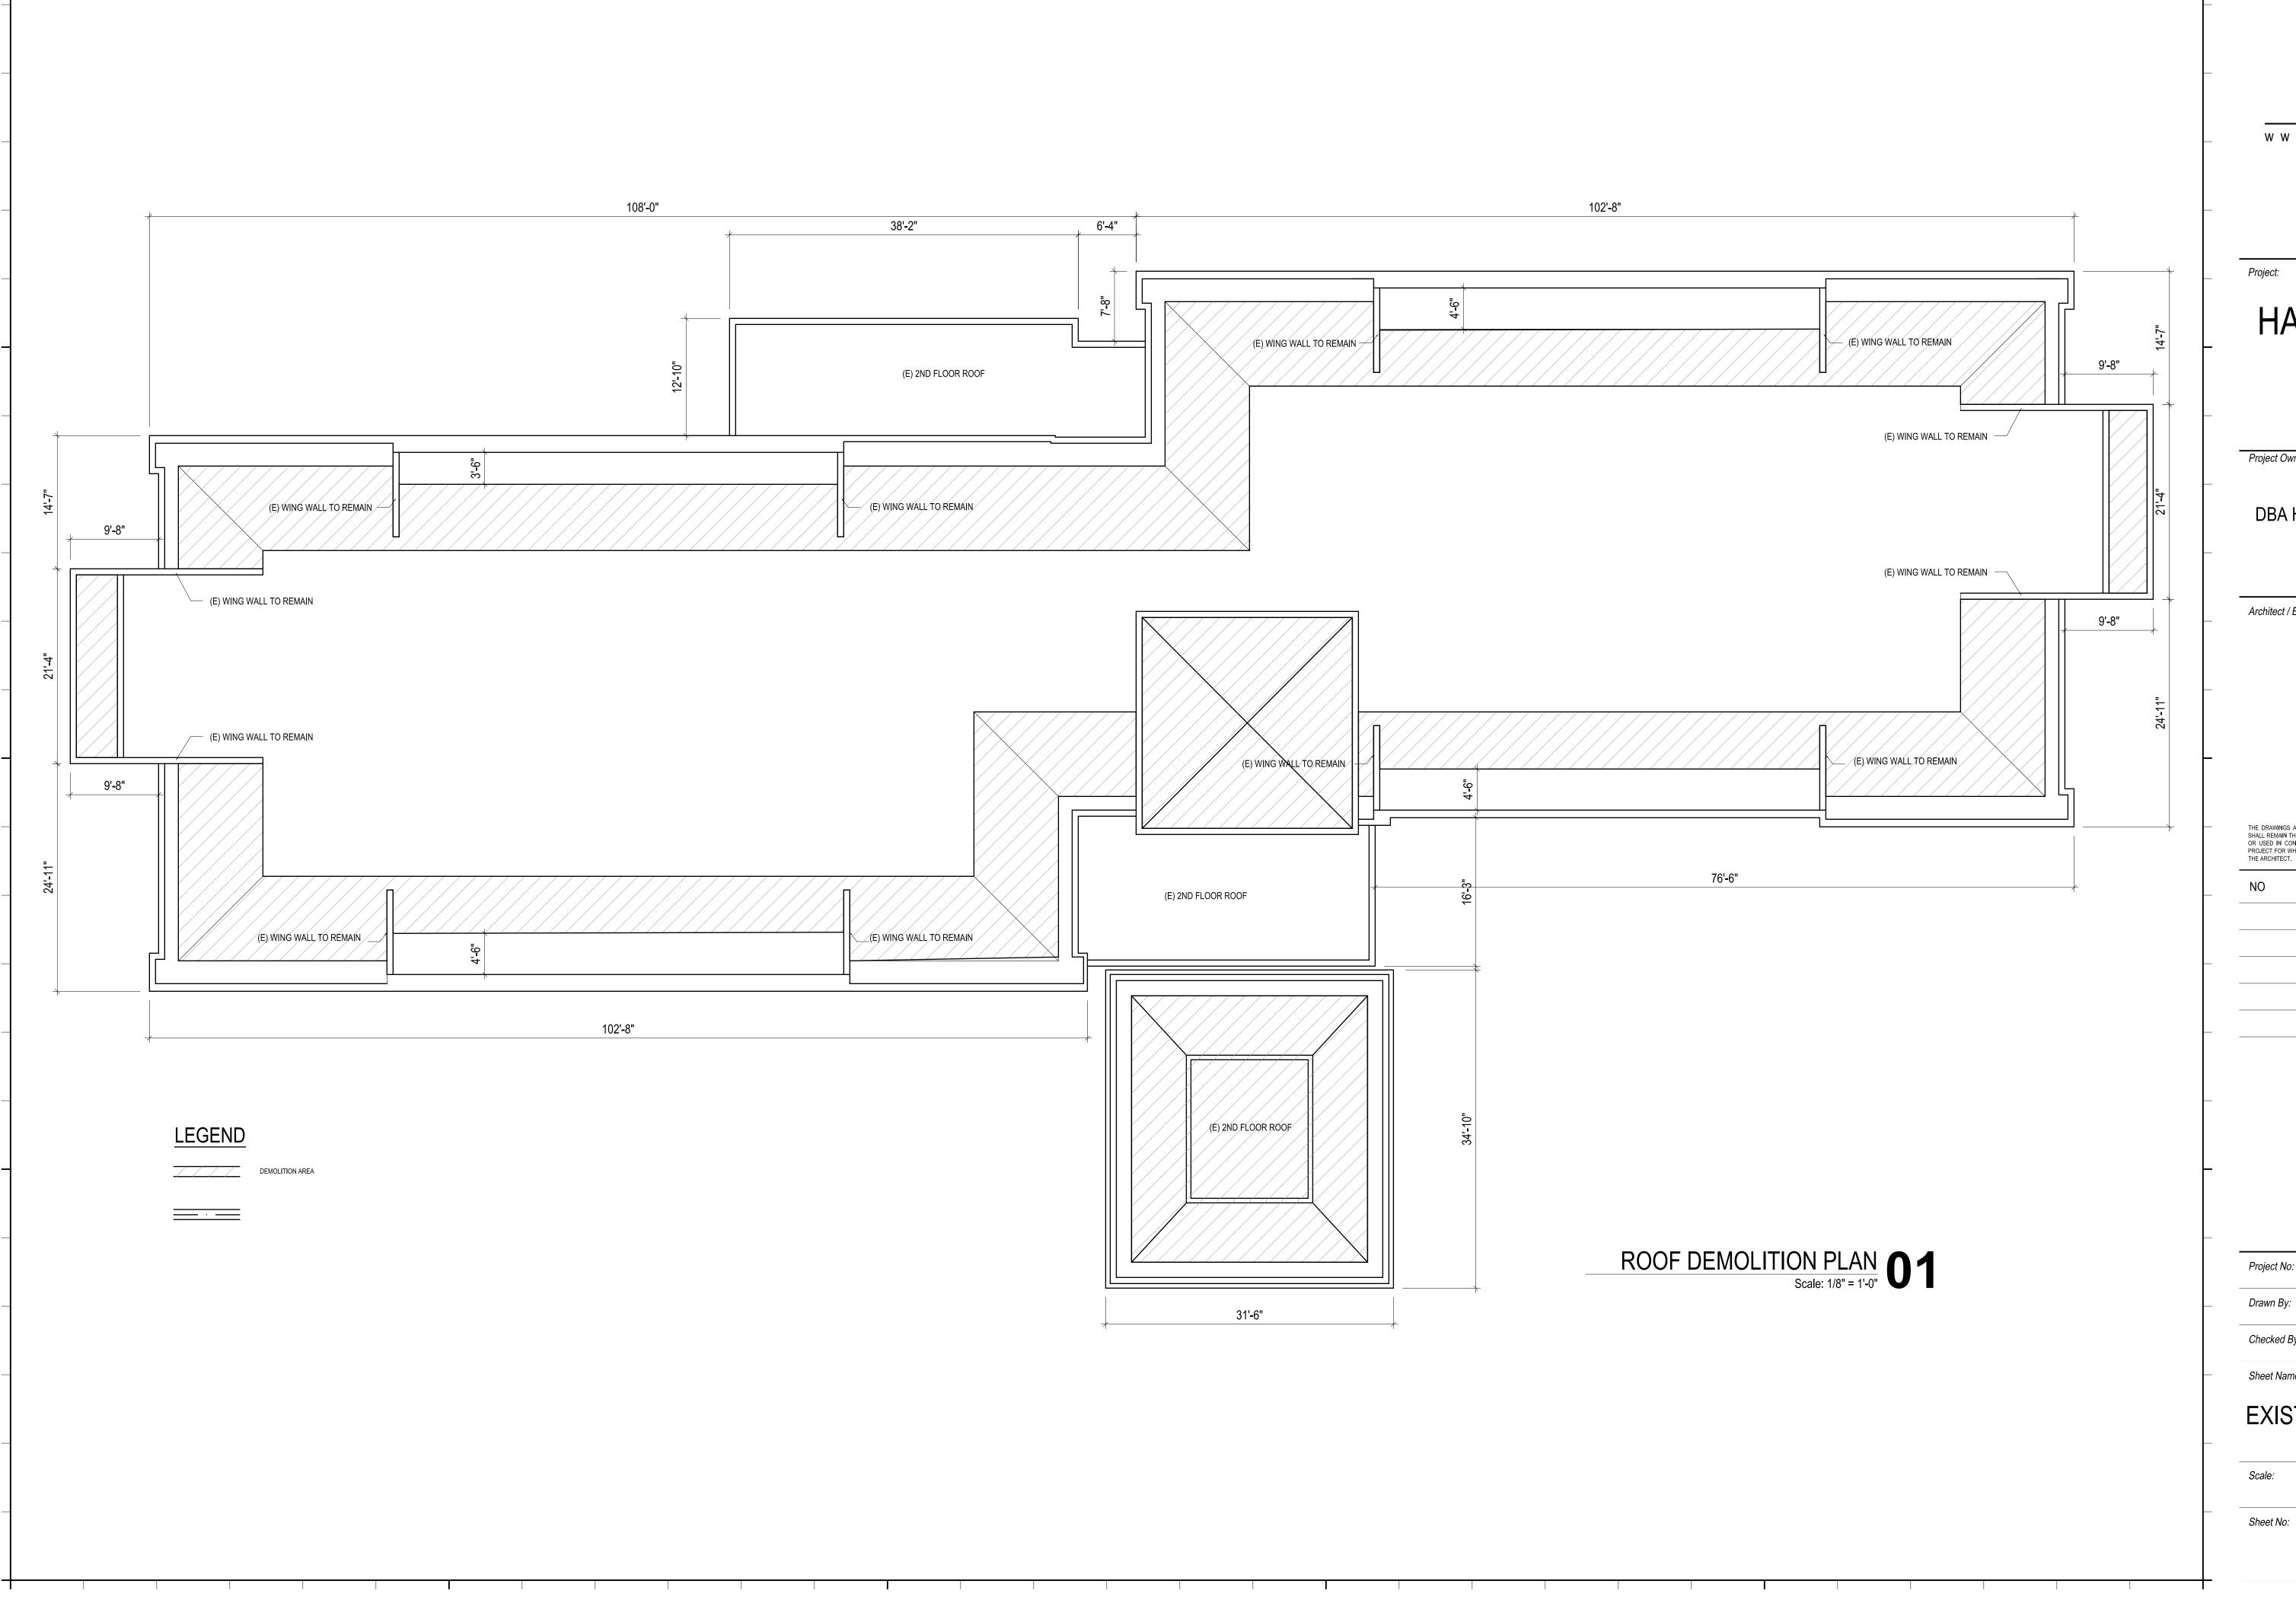
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EXISTING TYPICAL PLAN

1/8"=1'-0"



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ISSUED DATE


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EXISTING & DEMO PLAN

1/8"=1'-0"



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Project Owner:

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PROPOSED ROOF PLAN

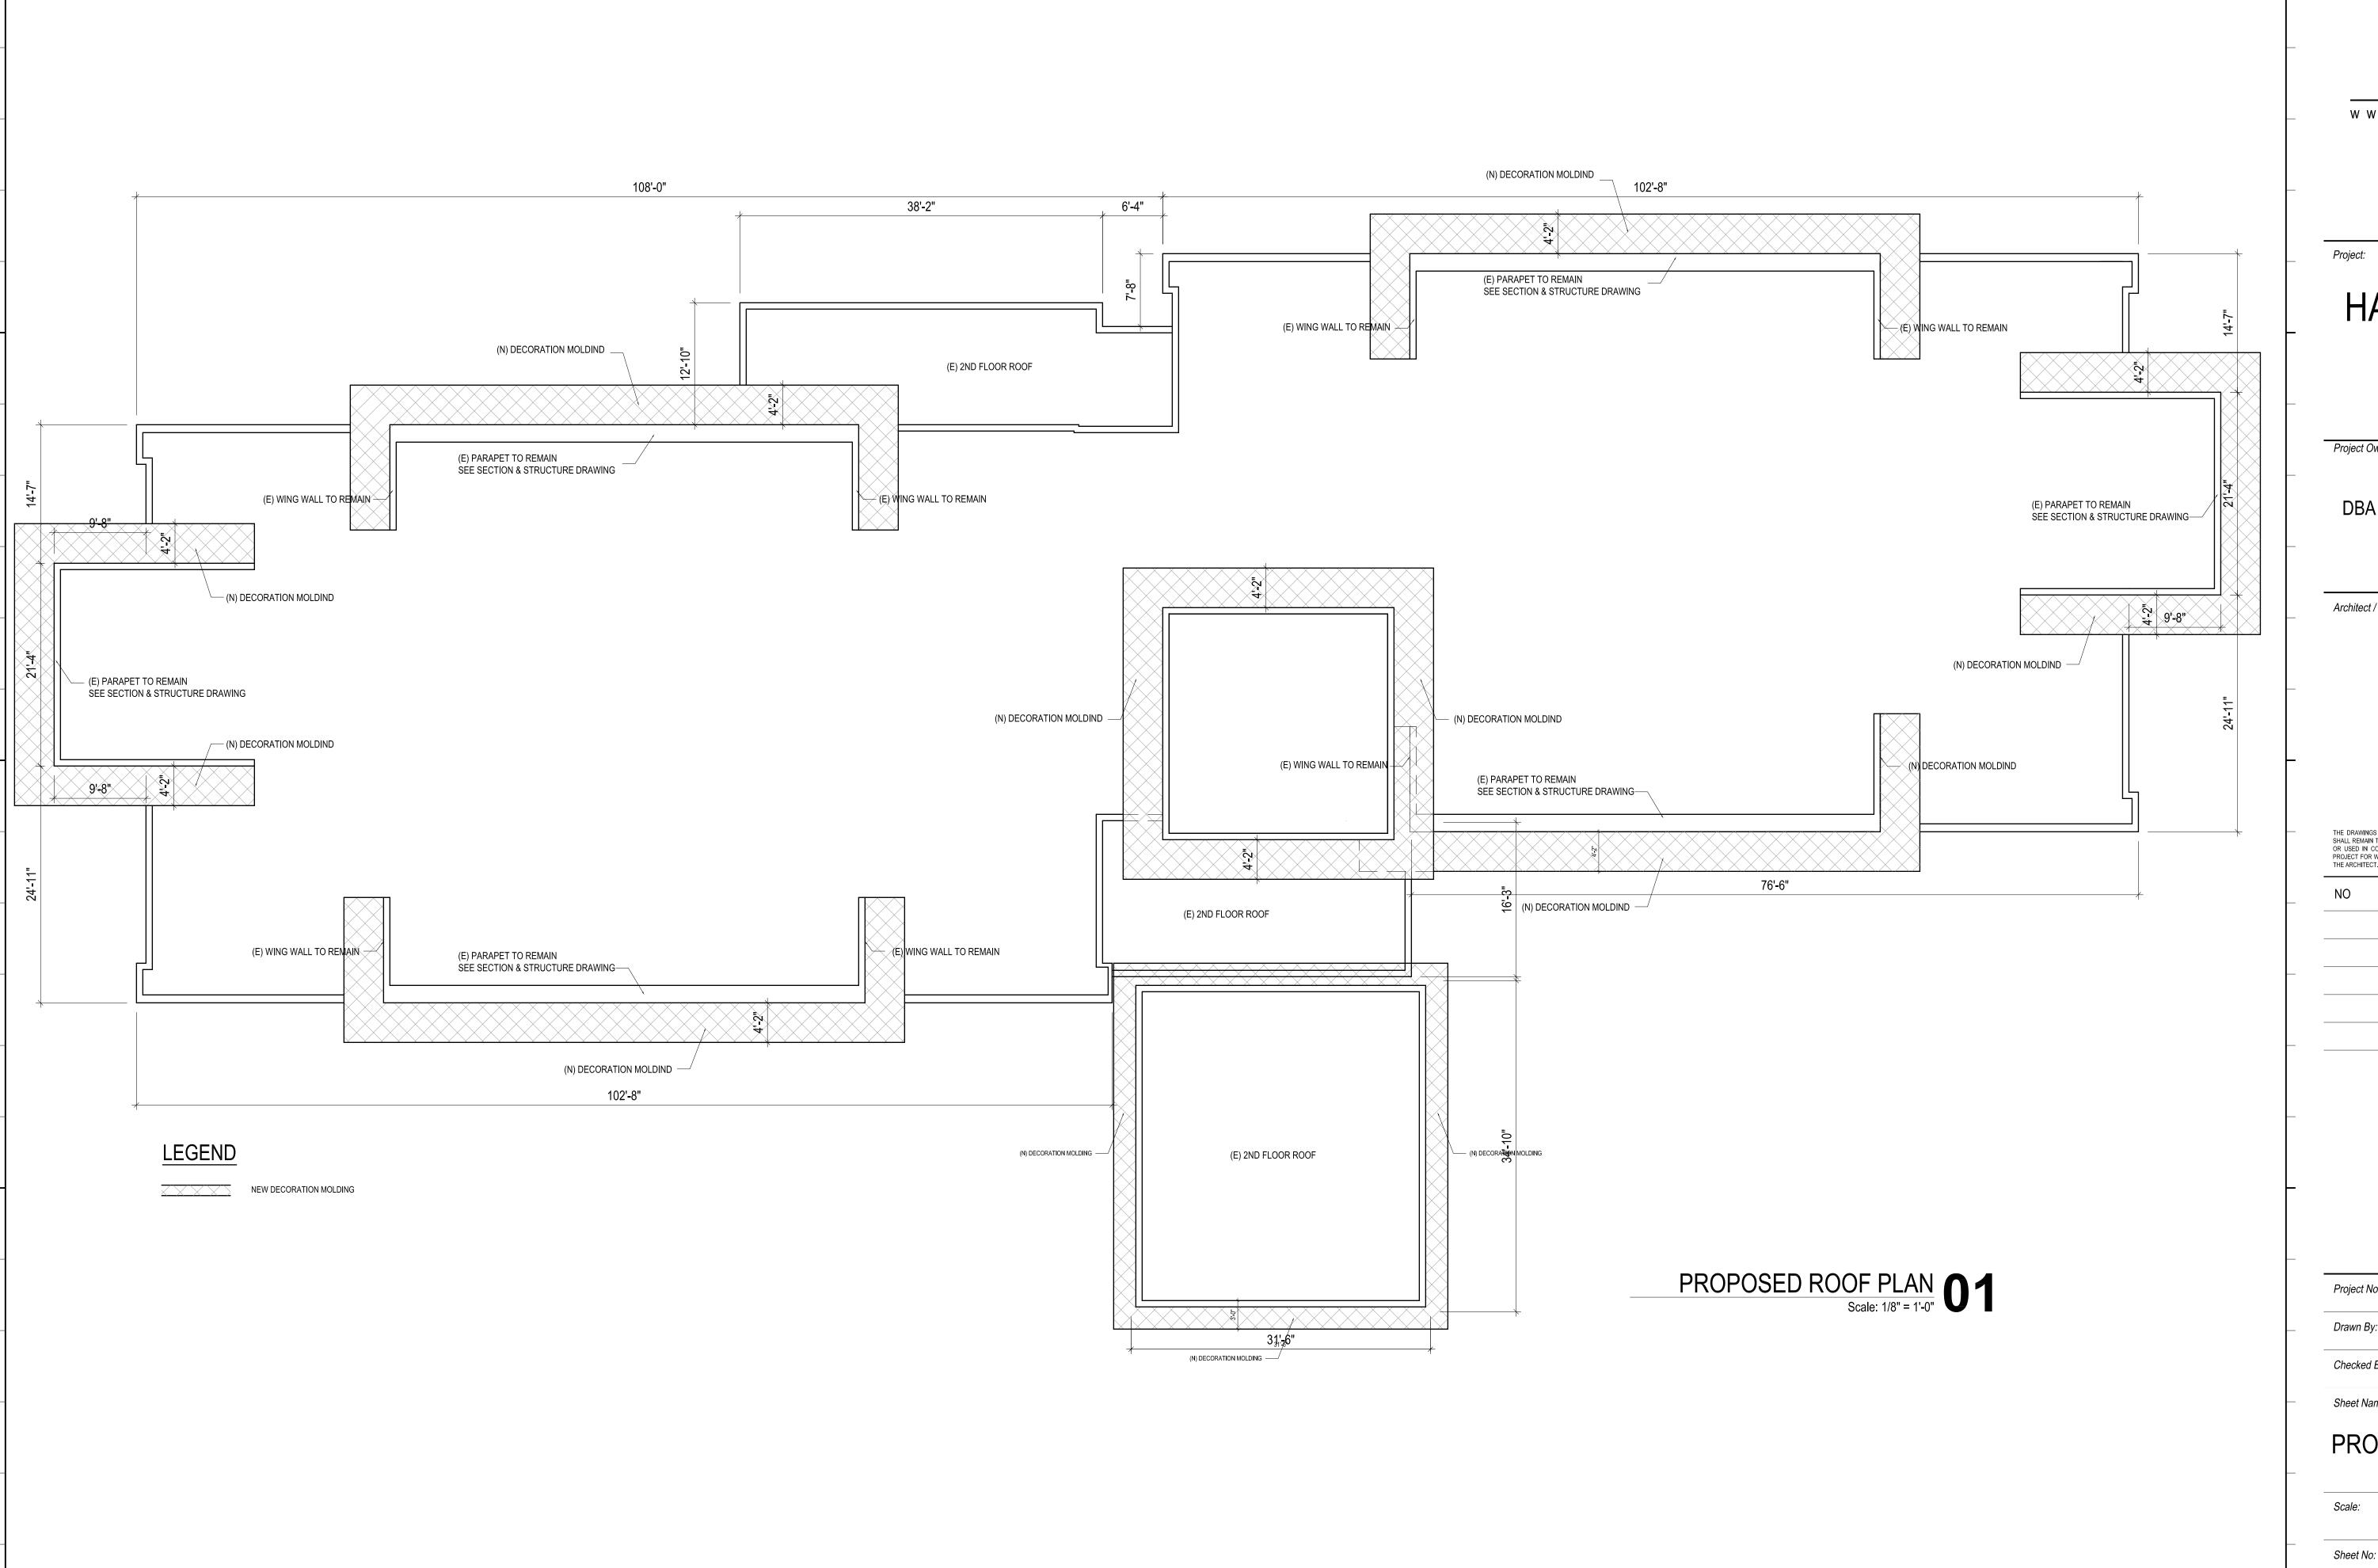1/8"=1'-0"



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KEY PLAN Architect Engineer Seal:




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DATE ISSUED

> 1636 (E) ELEVATION

1/8"= 1'-0"

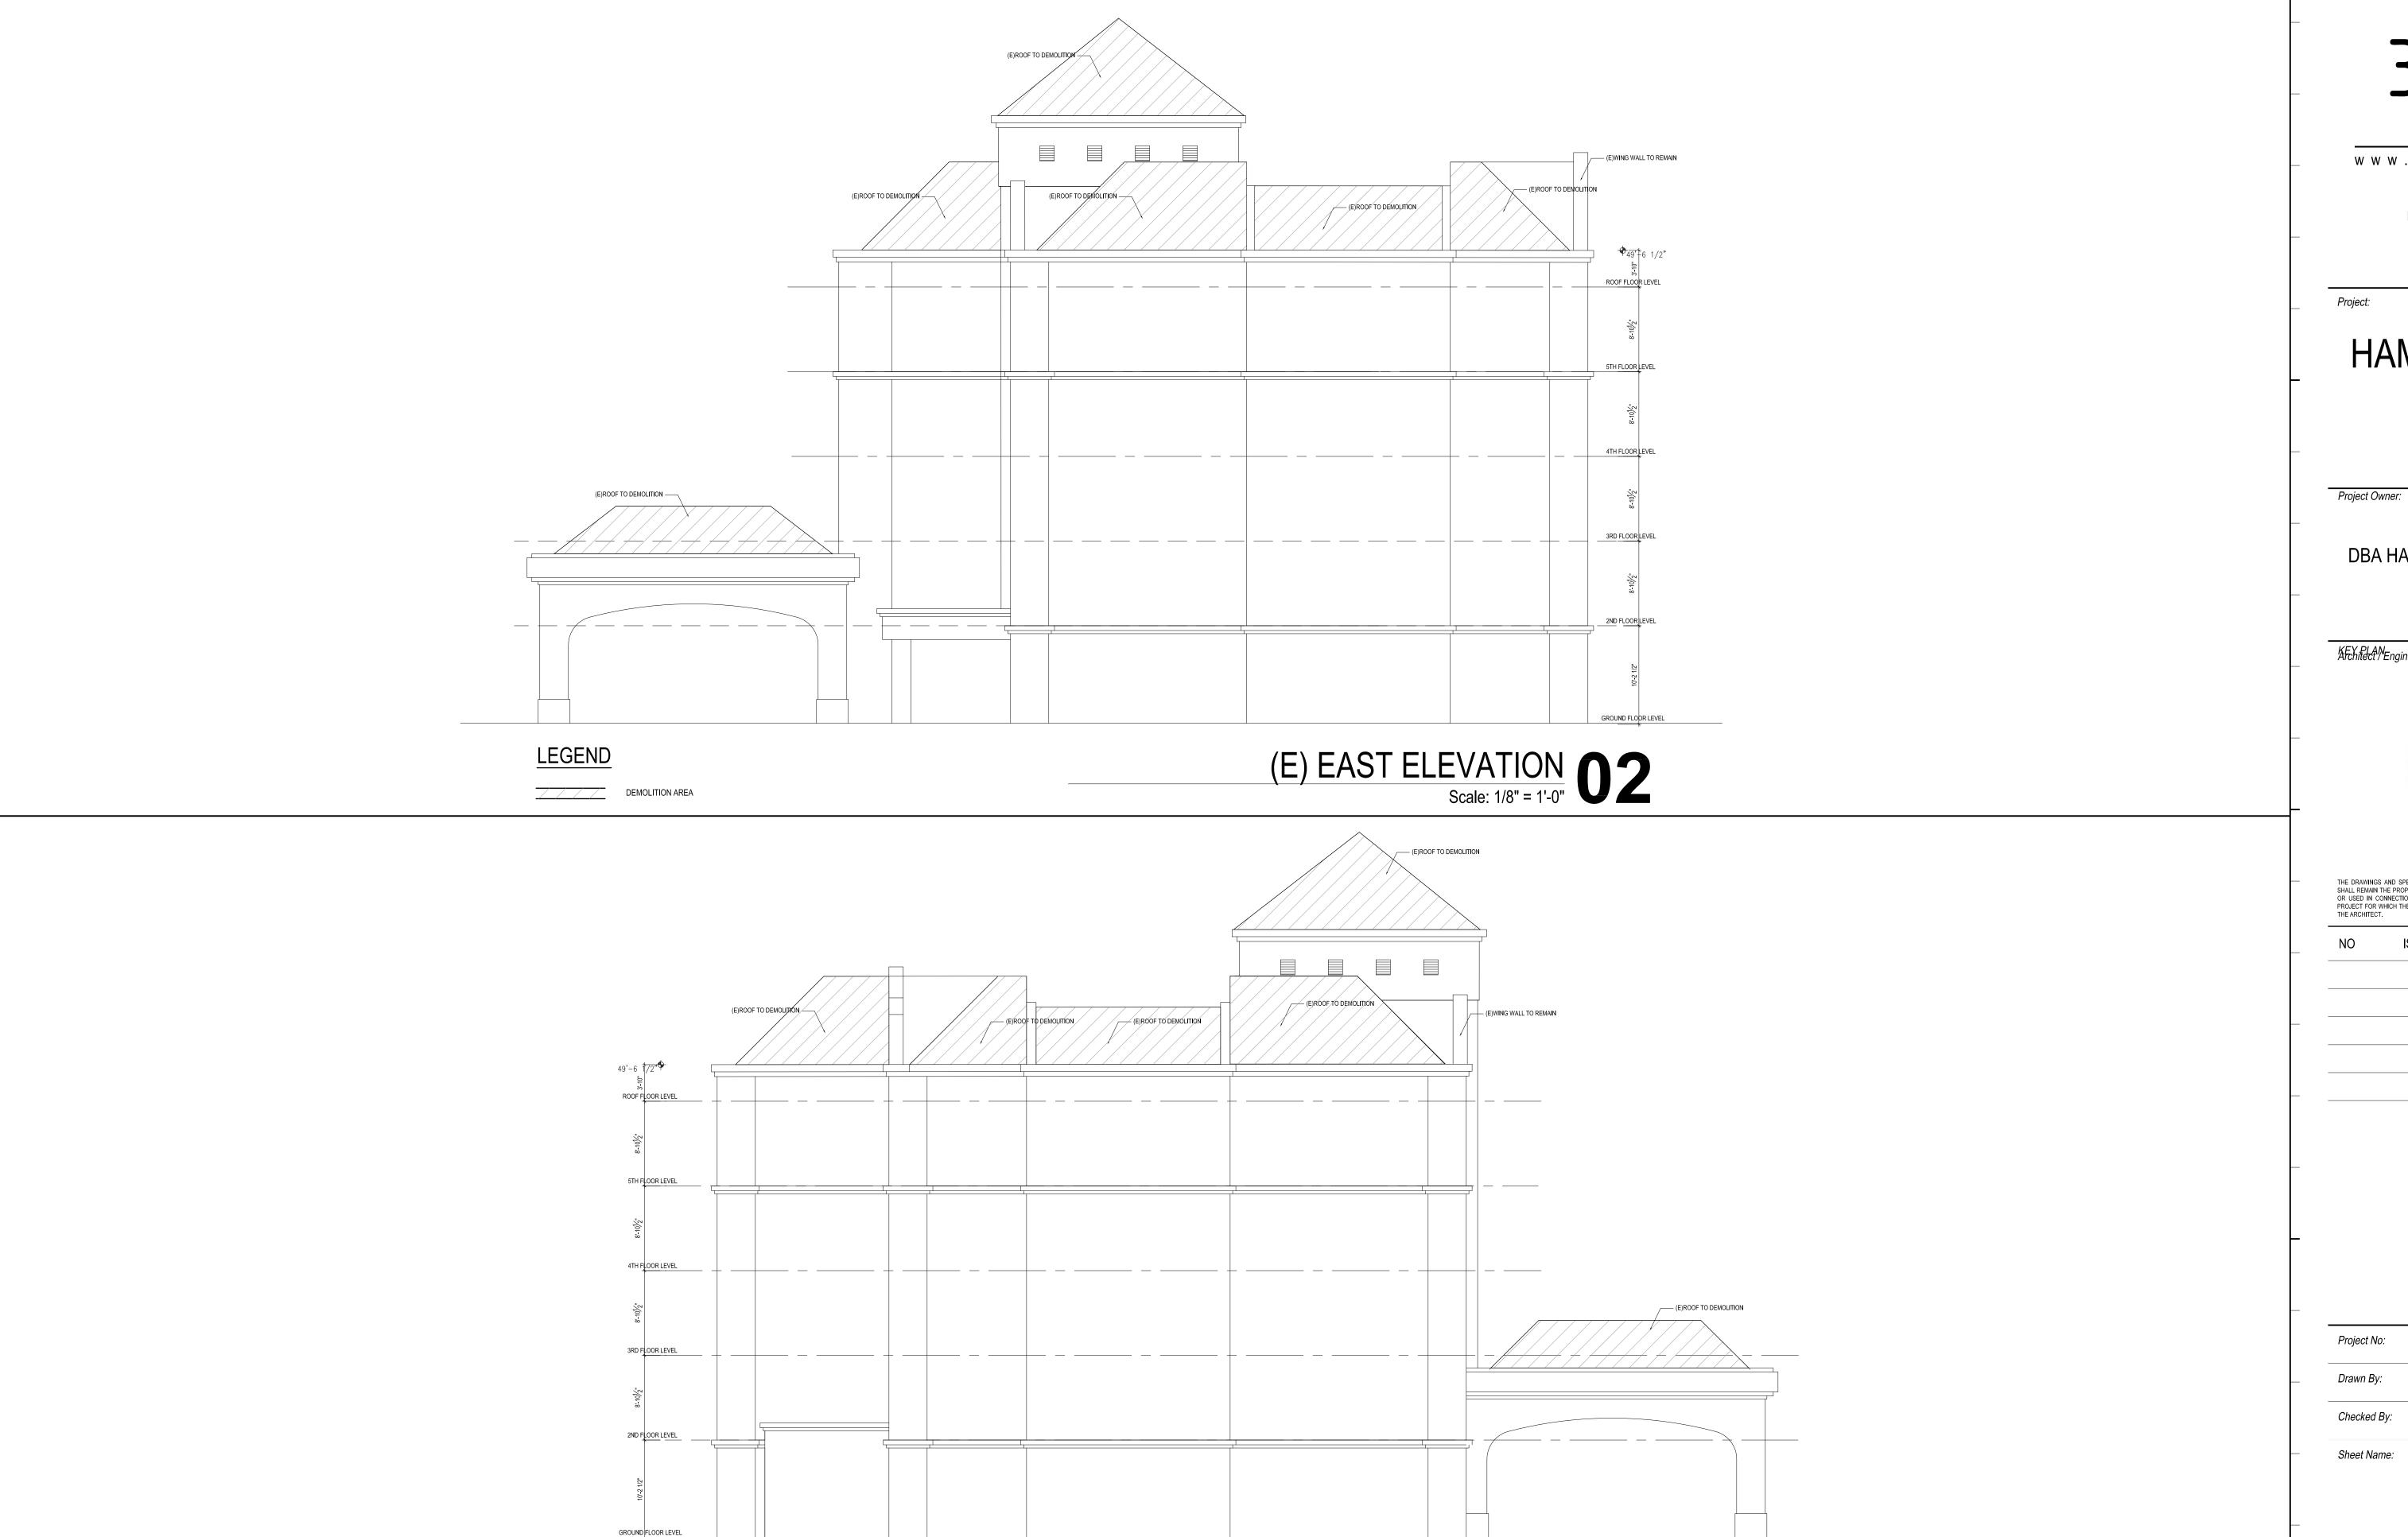

<u>LEGEND</u>

_____ DEMOLITION AREA

(E)WEST ELEVATION
Scale: 1/8" = 1'-0"

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KEY PLAN Architect / Engineer Seal:



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NO	ISSUED	DATE	

Project No:	1636
Drawn By:	
Checked By:	
Sheet Name:	
	(E) ELEVATION

1/8"= 1'-0"

Sheet No:



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Project Owner:

THEOXENIA LLC DBA HAMPTON INN CARSON 767 EAST ALBERTONI STREET CARSON, CA 90746

Architect Engineer Seal:





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> 1636 PROPOSED ELEVATION

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NEW DECORATION MOLDING

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KEY PLAN Architect / Engineer Seal:

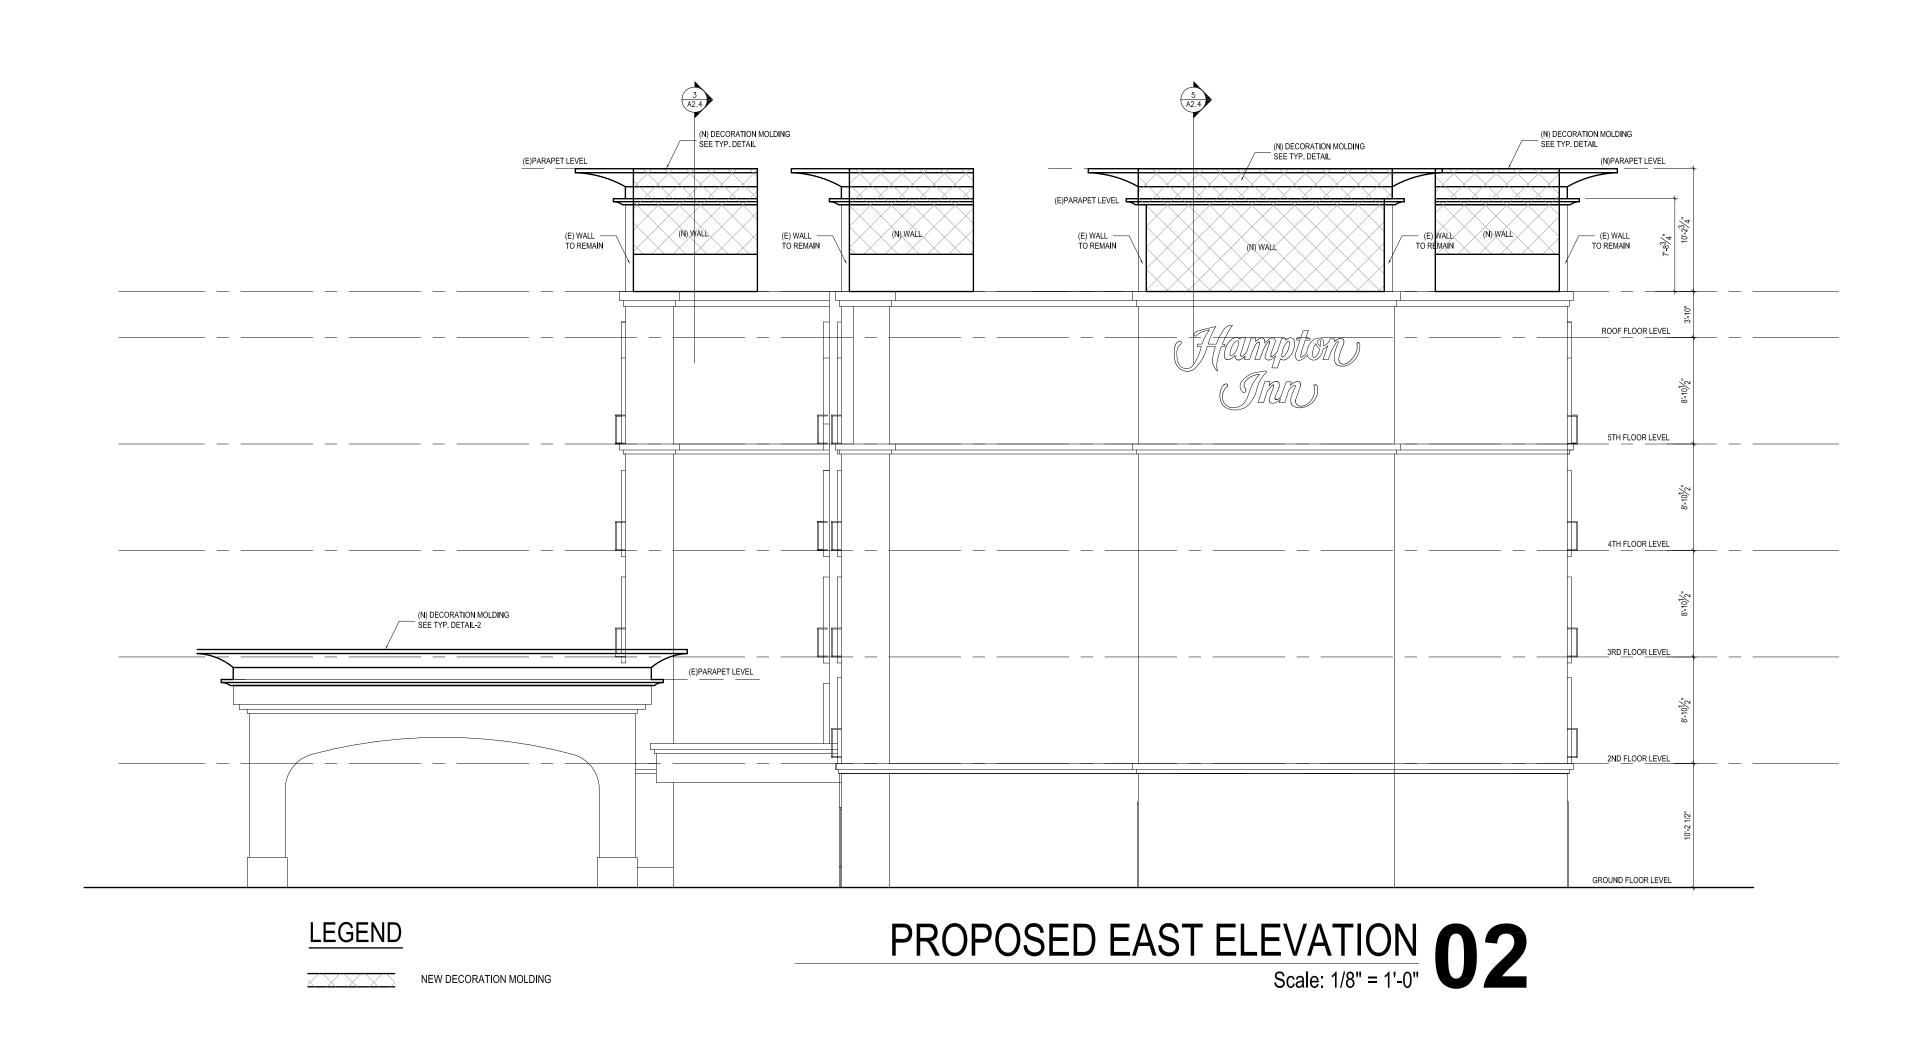


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1/8"= 1'-0"

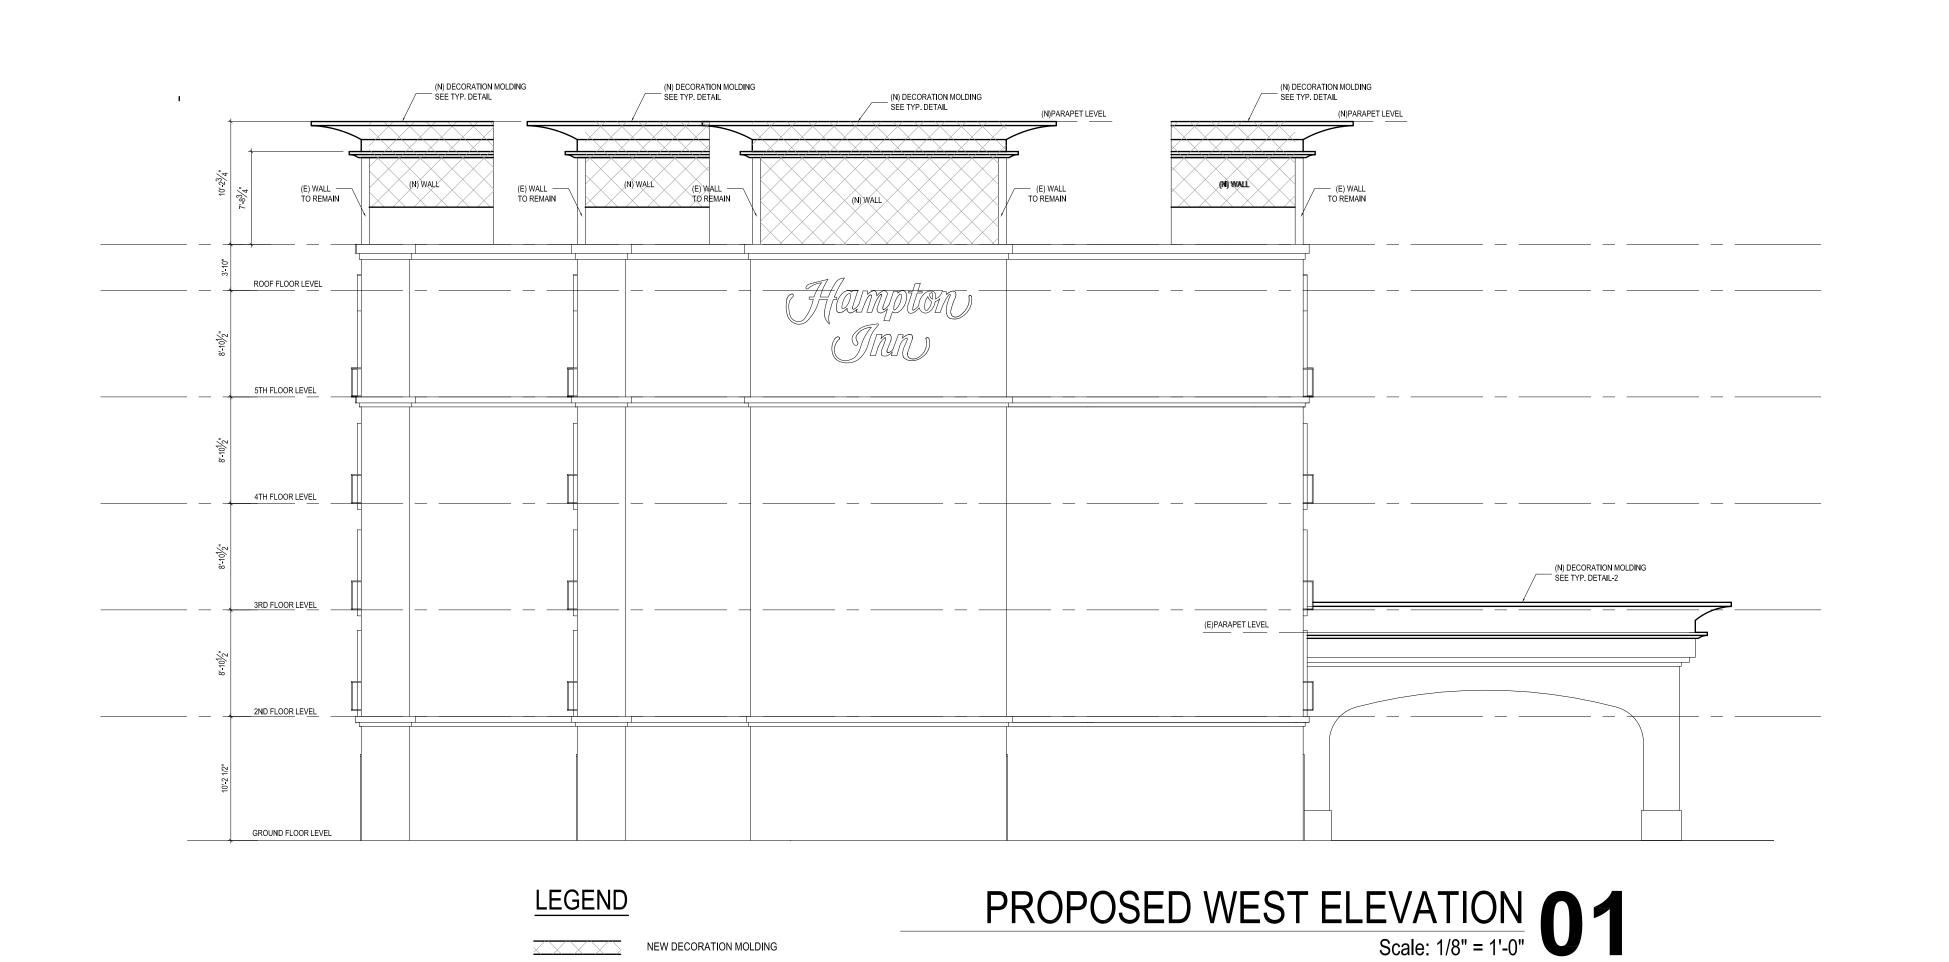

(N) DECORATION MOLDING

(N) PARAPET LEVEL

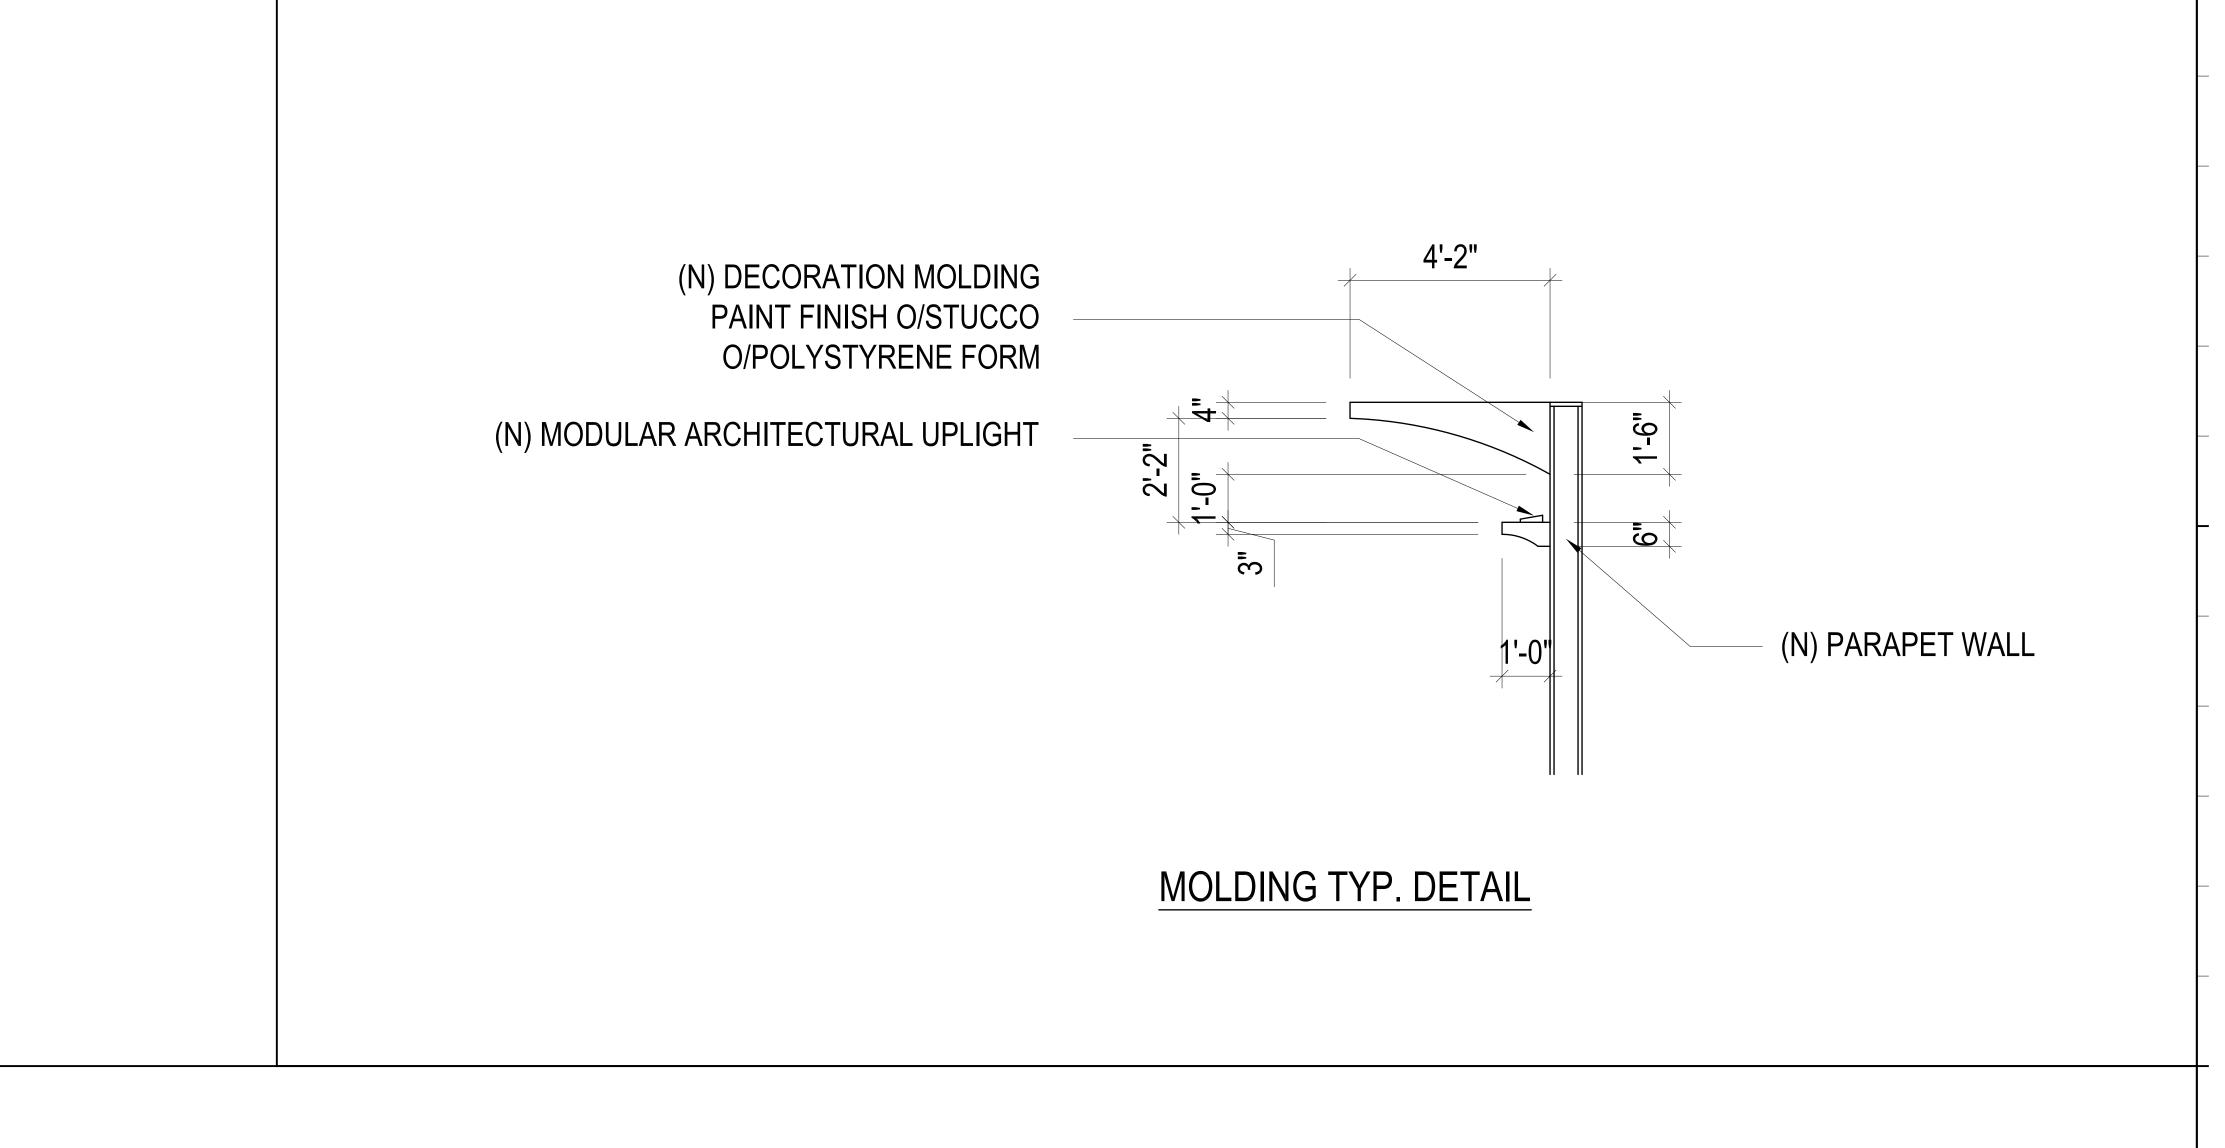(E) ROOF LEVEL

PAINT FINISH O/STUCCO

O/POLYSTYRENE FORM

(N) WING WALL

(E) WING WALL

WALL SECTION 3

NOTE: SEE S-1,2 DRAWINGS

(N) DECORATION MOLDING

PAINT FINISH O/STUCCO

O/POLYSTYRENE FORM

(N) PARAPET LEVEL

(E) PARAPET LEVEL

(E) ROOF LEVEL

WALL SECTION 1

(N) DECORATION MOLDING

PAINT FINISH O/STUCCO


O/POLYSTYRENE FORM

(N) PARAPET LEVEL

(E) PARAPET LEVEL

(E) ROOF LEVEL

WALL SECTION 2

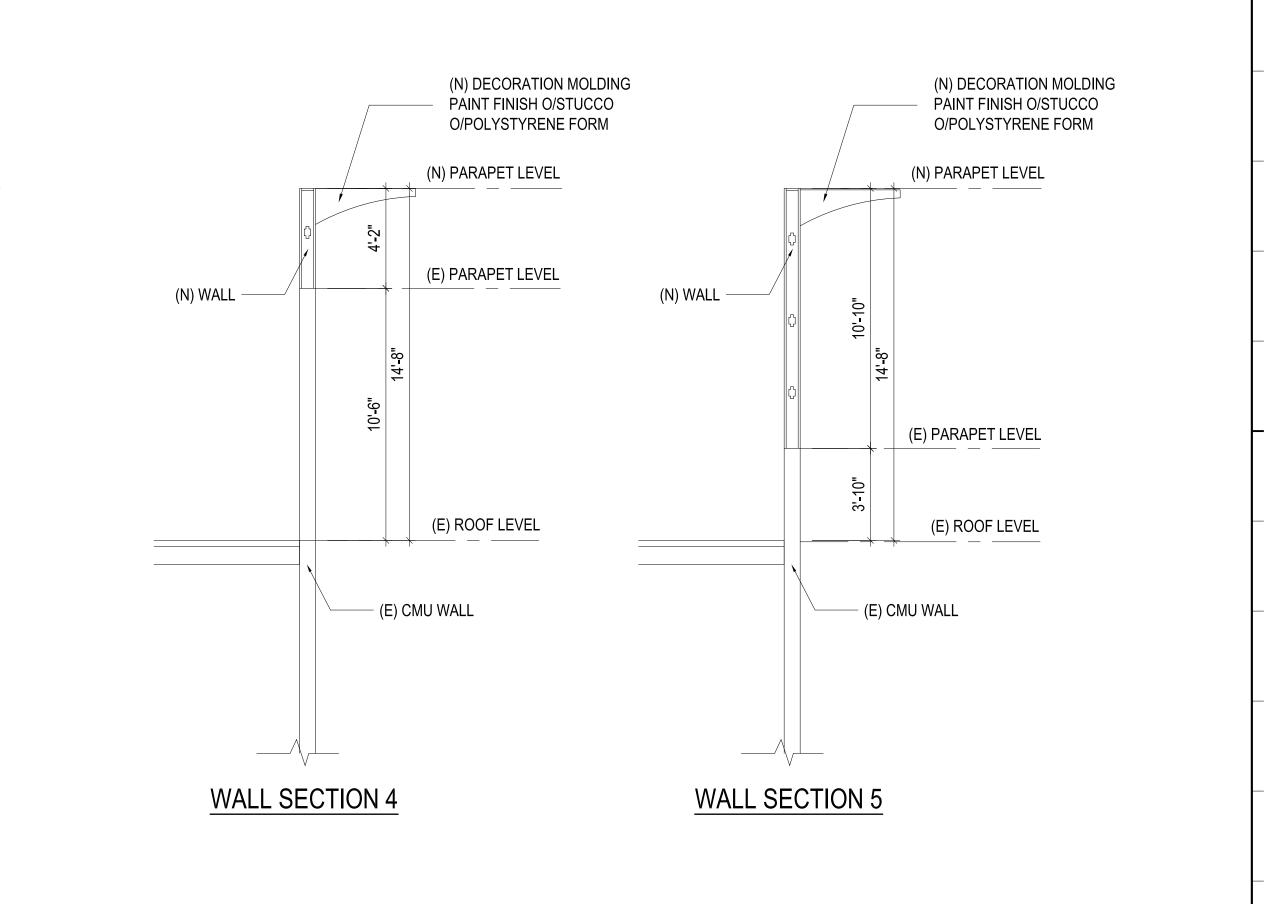

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Projec

HAMPTON INN CARSON

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NO ISSUED DATE

Project No:

Drawn By:

Checked By:

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DETAILS

1/8"= 1'-0"

A2.4

GENERAL NOTES

General Notes

- 1. ALL WORK SHALL CONFORM TO THE 2016 CALIFORNIA BUILDING CODE.
- 2. THE FOLLOWING NOTES AND ALL OTHER TYPICAL DETAILS APPLY TO ALL DRAWINGS UNLESS NOTED OTHERWISE.
- 3. STRUCTURAL DRAWINGS SHALL BE USED IN CONJUNCTION WITH ARCHITECTURAL, MECHANICAL AND ELECTRICAL DRAWINGS.
- 4. FRAMING CONDITIONS NOT SPECIFICALLY SHOWN SHALL BE FRAMED SIMILAR TO THE DETAILS SHOWN FOR THE RESPECTIVE MATERIALS.
- 5. PROVIDE OPENINGS AND SUPPORTS FOR MECHANICAL EQUIPMENT, DUCTS, PIPING VENTS ETC., AS REQUIRED. REFER TO ARCHITECTURAL & MECHANICAL DRAWINGS FOR ADDITIONAL OPENINGS AND EQUIPMENT WHICH ARE NOT SHOWN ON STRUCTURAL DRAWINGS. ALL SUSPENDED EQUIPMENT TO BE PROVIDED WITH ALL APPROVED BRACING.
- 6. CONTRACTOR MUST CLARIFY ALL DIMENSIONS AND SITE CONDITIONS BEFORE COMMENCING WORK. ARCHITECT SHALL BE INFORMED AND NOTIFIED OF ANY TYPE OF DISCREPANCIES.
- 7. NOTES AND DETAILS ON DRAWINGS SHALL TAKE PRECEDENCE OVER THESE GENERAL NOTES.
- 8. DESIGN MATERIALS, EQUIPMENT AND PRODUCTS OTHER THAN THOSE DESCRIBED BELOW OR INDICATED ON THE DRAWINGS MAY BE CONSIDERED FOR USE. PROVIDED THAT PRIOR APPROVAL IS OBTAINED FROM THE OWNER, ARCHITECT/ENGINEER AND THE APPLICABLE GOVERNING CODE AUTHORITY.
- 9. THE FOLLOWING WORK REQUIRES SPECIAL INSPECTION BY
 A REGISTERED DEPUTY INSPECTOR UNLESS NOTED OTHERWISE BY CBC 1704.1.1
 A. FIELD WELDING AS REQUIRED
 B. EPOXY AS REQUIRED
 - C. CON'C FILE AND GRADE BEAM(CONCRETE F'C>=3000psi)
 D. HIGH STRENGTH BOLT
- 10. STRUCTURE OBSERVATION BY ENGINEER OF RECORD WILL BE REQUIRED AT:

 A) FOUNDATION INCLUDING CON'C PILE AND GRADE BEAM
 B) FRAMING
 C) OTHER

Metal studs and accessories

- MEET OR EXCEED MIN. REQUIREMENTS OF FED. SPEC. QQ-S-698

 AND FED. SPEC. QQ-S-775d, FOR THE ITEM AND USE IN-TENDED

 METAL STUDS:
- 1. AT INTERNAL METAL STUD PARTITIONS, UNLESS OTHERWISE SHOWN ON THE DRAWINGS, PROVIDE STANDARD PUNCHED STEEL STUDS OF THE GAGES SHOWN ON THE DRAWINGS, EITHER HOT—DIP GALVANIZED OR FACTORY PRE—PAINTED.
- 2. USE ONLY ONE TYPE THROUGHOUT THE WORK, UNLESS
 OTHERWISE SHOWN ON THE DRAWINGS OR SPECIFICALLY
 APPROVED IN ADVANCE BY THE ARCHTECT OR ENGINEER
 ACCESSORIES:
- PROVIDE ALL ACCESSORIES INCLUDING, BUT NOT NECESSARILY
 LIMITED TO, TRACKS, CLIPS, ANCHORS, FASTENING DIVICES,
 SOUND ATTENUATION PENCIL RODS AND RESILIENT CLIPS, AND
 OTHER ACCESSORIES REQUIRED FOR A COMPLETE AND PROPER
 INSTALLATION, AND AS RECOMMENDED BY THE MANUFACTURER OF

(N)METAL STUD -

16 GA. BLK'G

362 S162-033 20GA @16" O.C. TYP.


- THE STEEL STUDS USED.

 ALL METAL STUDS AND SCREWS PROVIDED BY METAL SYSTEM

 (ICC ESR-2196 LARR # 25678)
- 3. ALL SCREWS COMPLY TO ICBO. NER-211
- 4. METAL STUDS (ICC ESR-3064P)

MATERIAL LARR# TABLE

:		
MATERIAL	ICC #	LARR #
SIMPSON HDU	ESR-2330	25720
SIMPSON HANGER	ESR-2552	24949
SIMPSON SET-XP EPOXY	ESR-2508	25744
SIMPSON MST/ST	ESR-2105	25113
SIMPSON CC/ECC	ESR-2604	25714
SIMPSON A35/A34/LTP 4	ESR-2606	25716
SIMPSON STRONG WALL SHEAR PANEL	ESR-1267	25427
SIMPSON CB	ESR-2604	25714
PARALLAM	ESR-1387	25202
MSTAL STUDS	ESR-1166P	25889

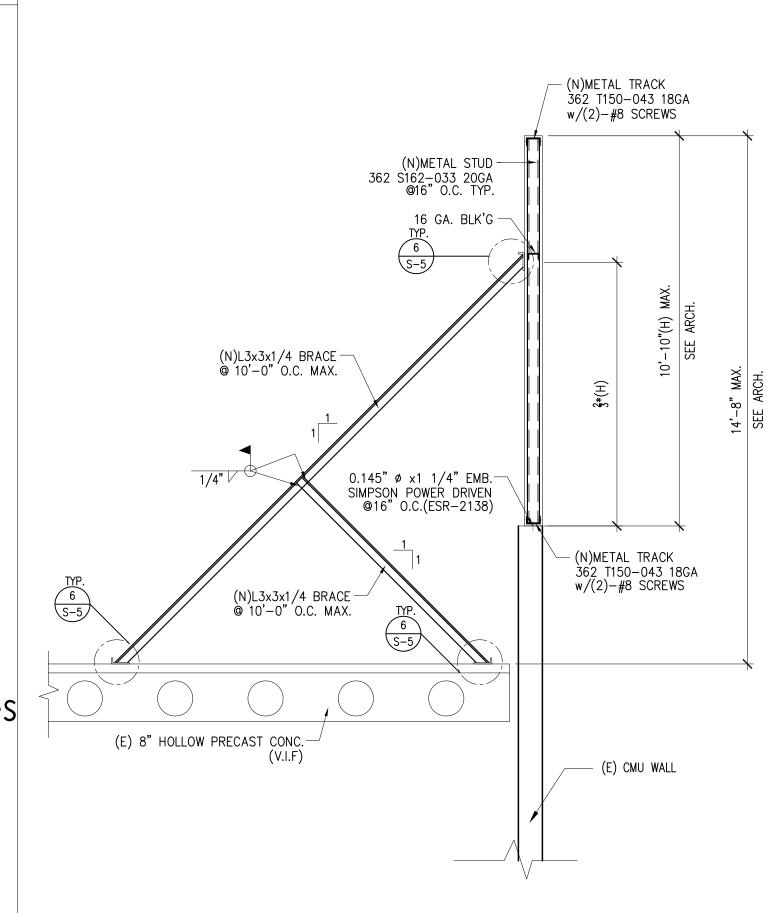

- L3x3x1/4 CONT. w/0.145" PDPT-XX

SIMPSON FASTENER @16" O.C (ESR-2138)

-16 GA. BLK'G

-(N)METAL STUD

362 S162-033 20GA @16" O.C. TYP.

1/4

(N)L3x3x1/4 BRACE @ 10'-0" O.C. MAX.

(ESR-2138)


0.145" Ø x1 1/4" EMB. SIMPSON POWER DRIVEN


— (N)L3x3x1/4 BRACE [—] ◎ 10'-0" O.C. MAX.

L3x3x1/4 CONT. w/0.145" PDPT-XX


(E) 8" HOLLOW PRECAST CONC.


SIMPSON FASTENER @16" O.C (ESR-2138)

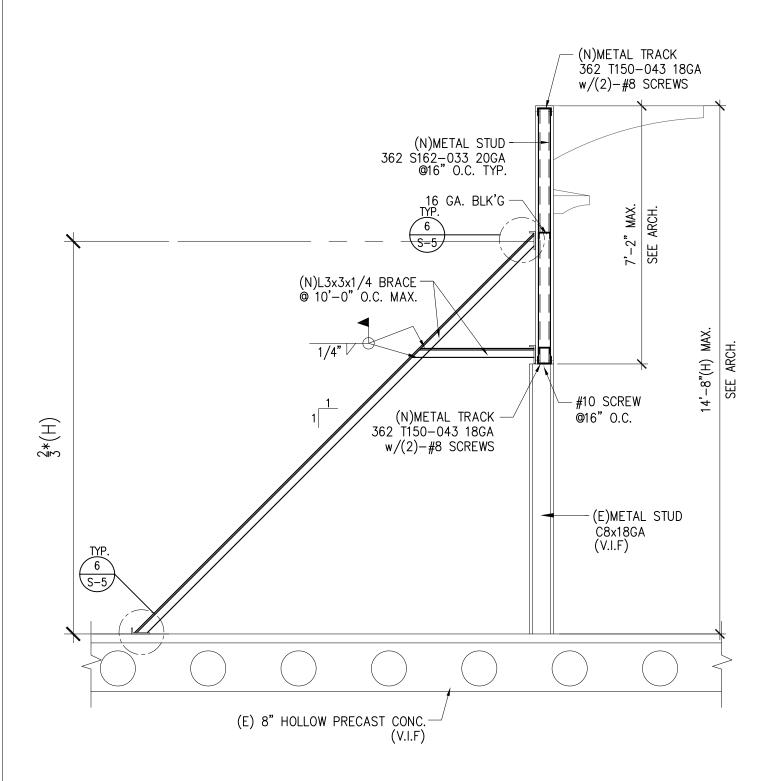

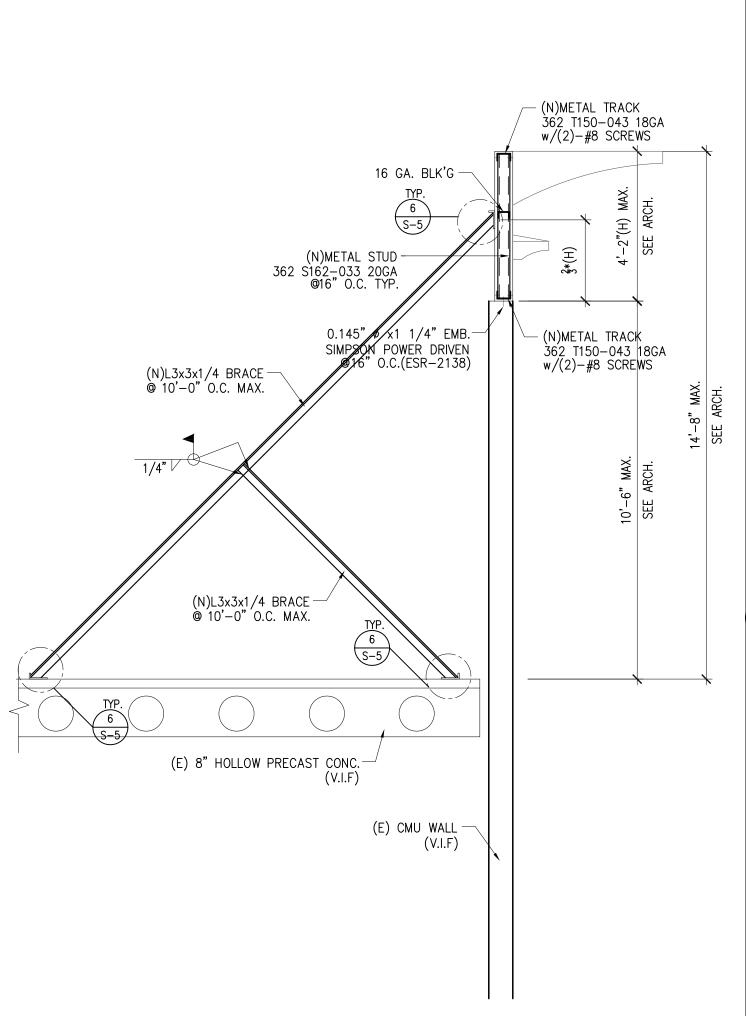

3

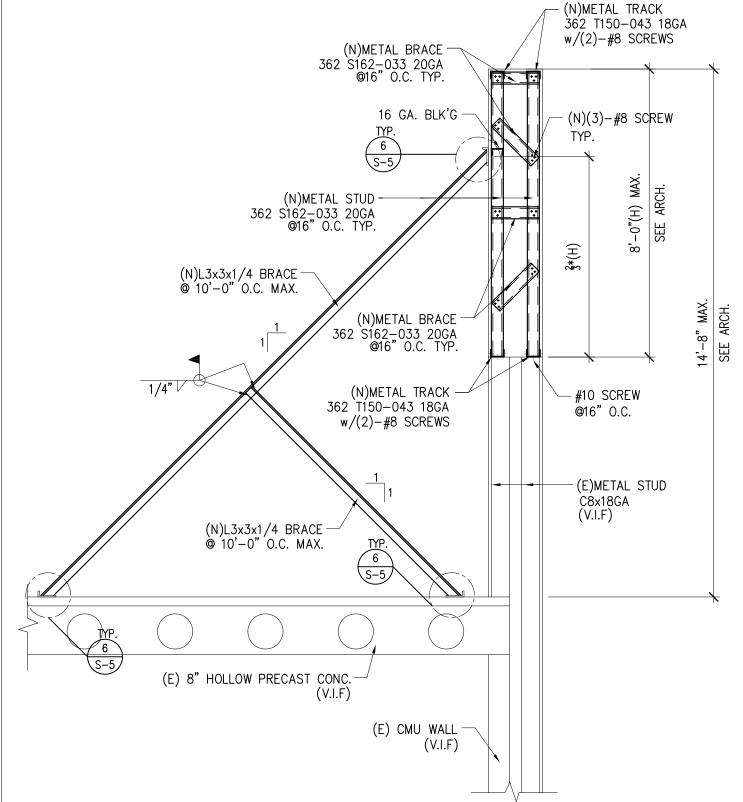

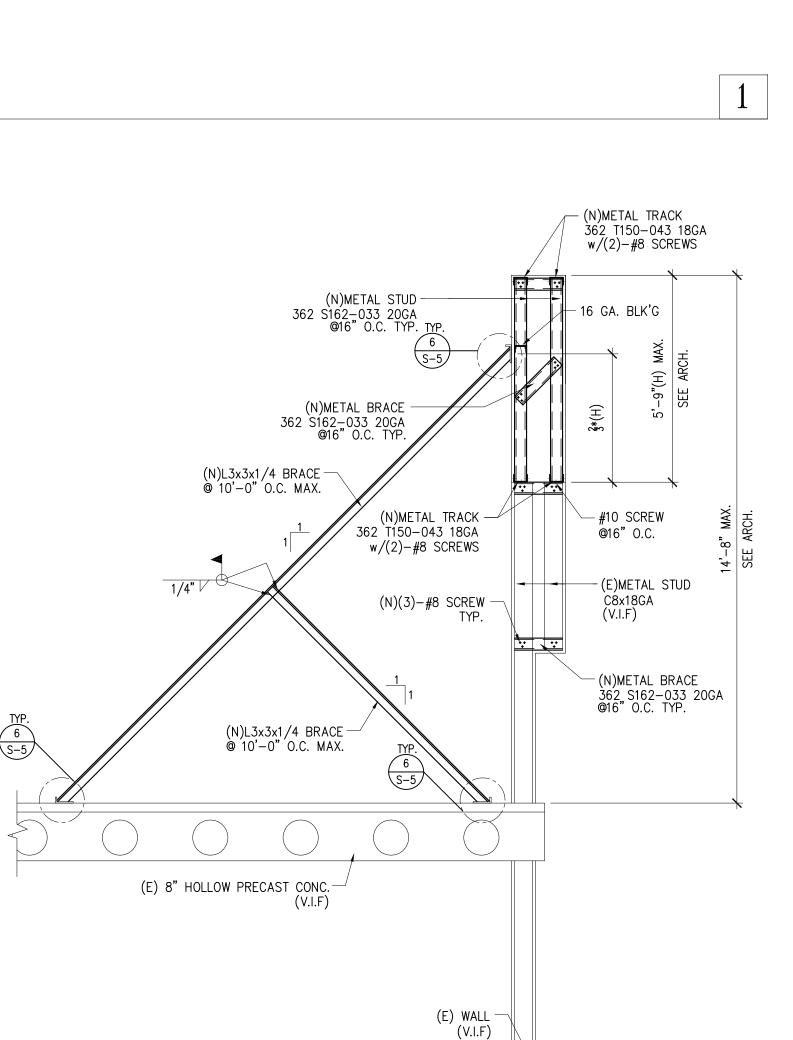

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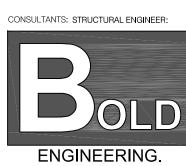
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Project Owner:

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Architect / Engineer Seal:





3055 WILSHIRE BLVD. #880 LOS ANGELES, CA 90010 T. 213-386-3049 213-487-7490 boldengineer@gmail.com

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GENERAL NOTE &

SECTIONS

Scale:

Sheet No:

2

S - 1

Project:

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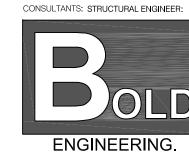
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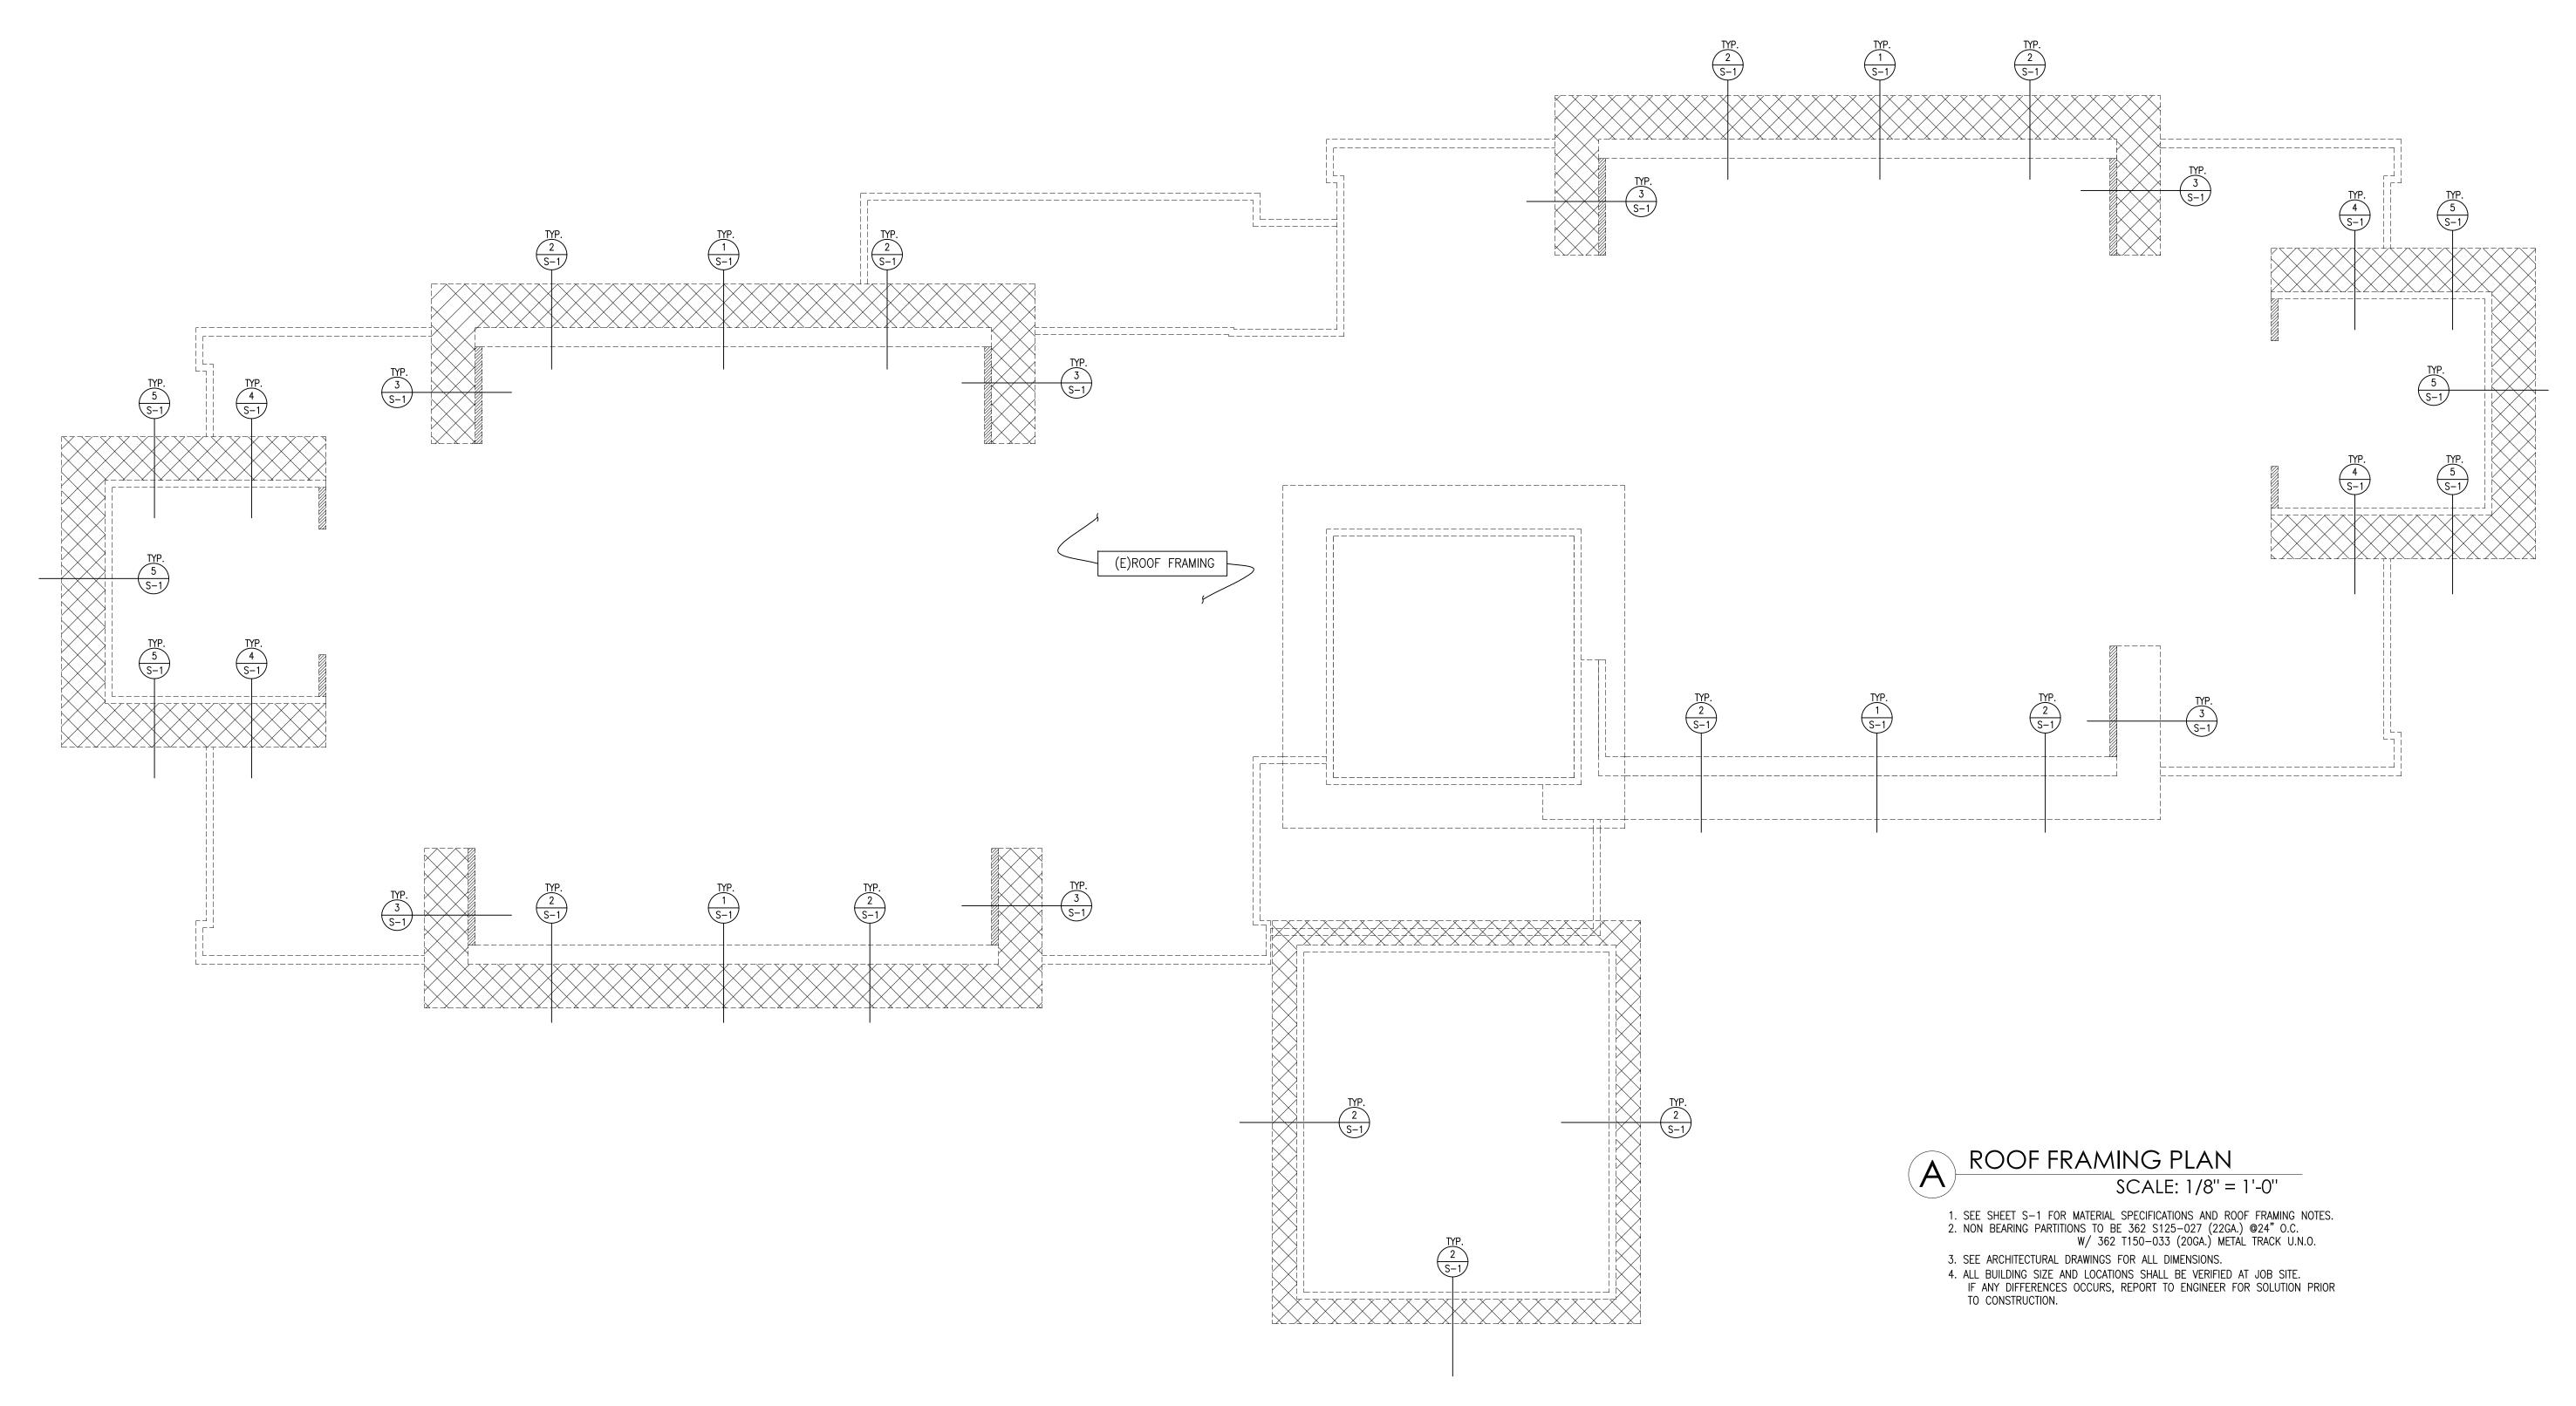
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Sheet Name:

ROOF FRAMING PLAN

Scale: N/A

S - 2



<u>LEGEND</u>

: INDICATES (E)ROOF LINE

: INDICATES (N)METAL STUDS WALL

: INDICATES (N) PARAPET

MATERIAL TABLE

METAL STUDS

ASTM A1003

(fy=33ksi FOR 20, 18GA.)

(fy=50ksi FOR 16, 14, 12GA.)







VIEW 4 VIEW 3

VIEW 2 VIEW 1



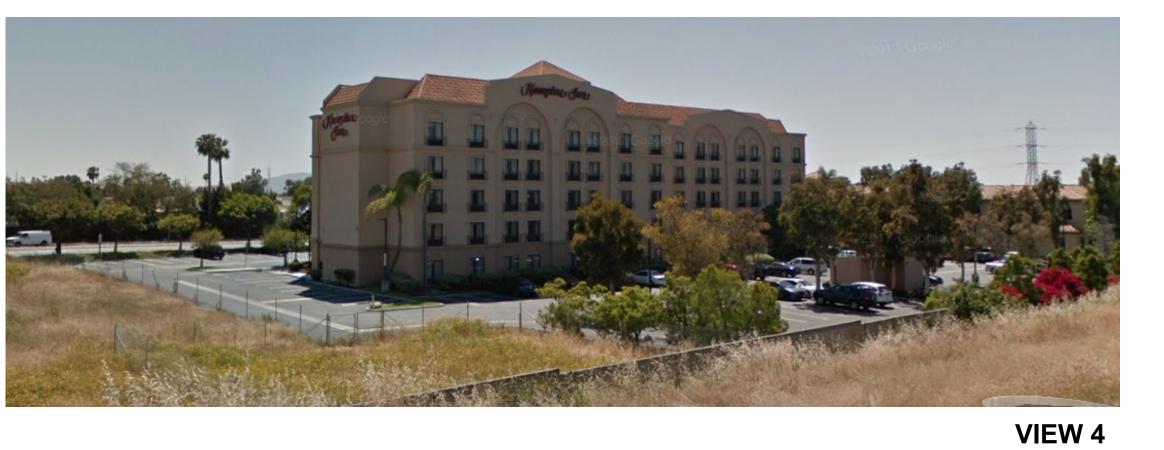


VIEW 2

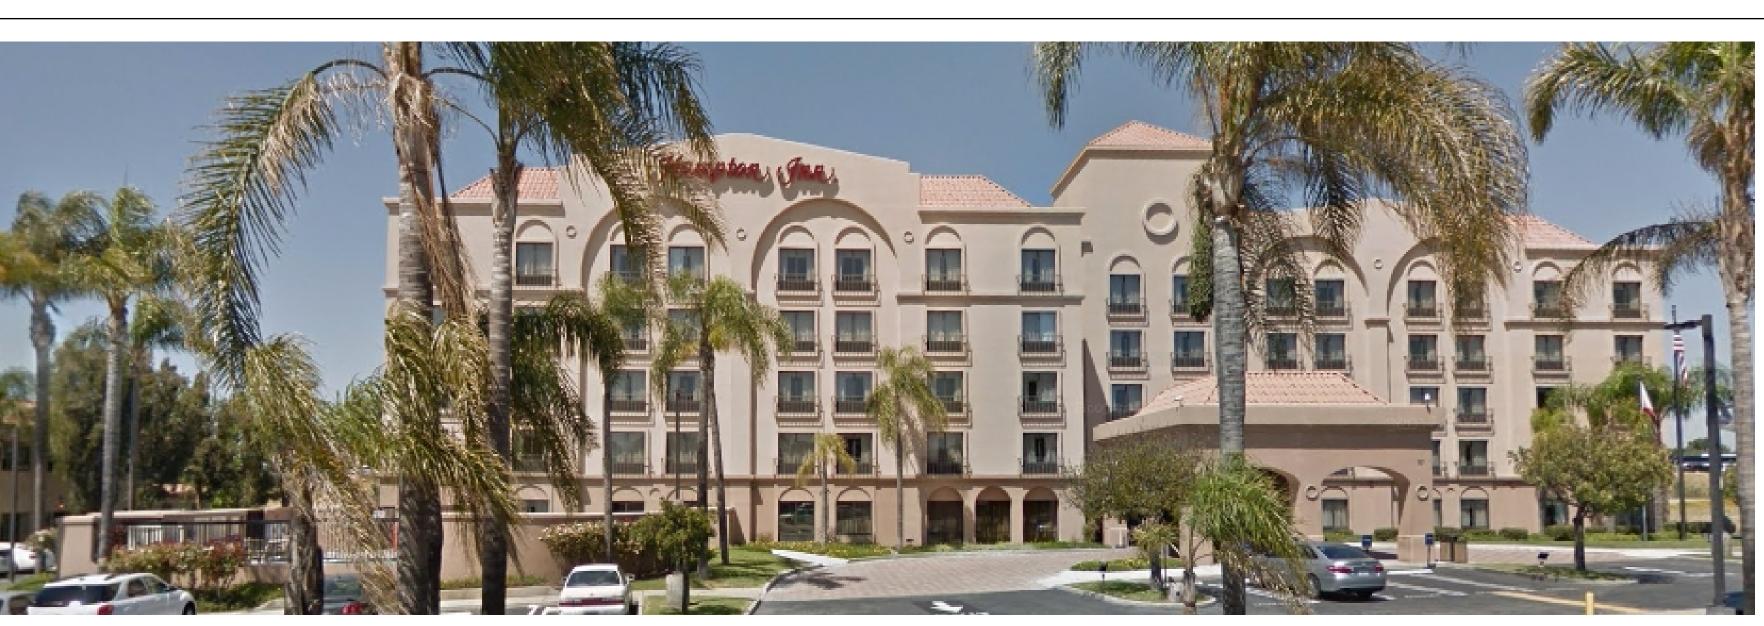





02

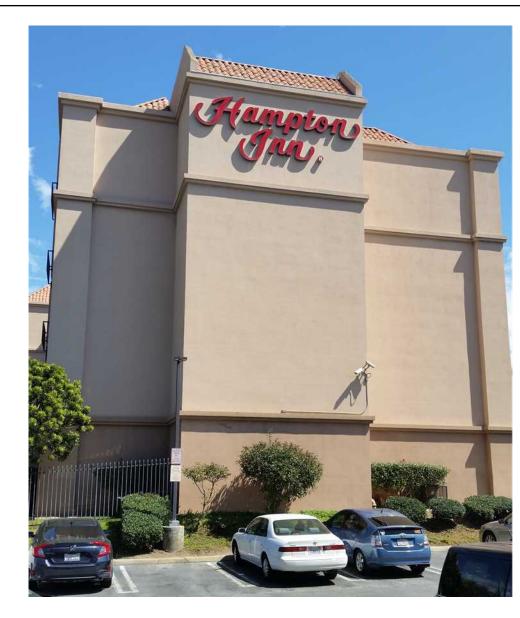

(E) WEST ELEVATION 03

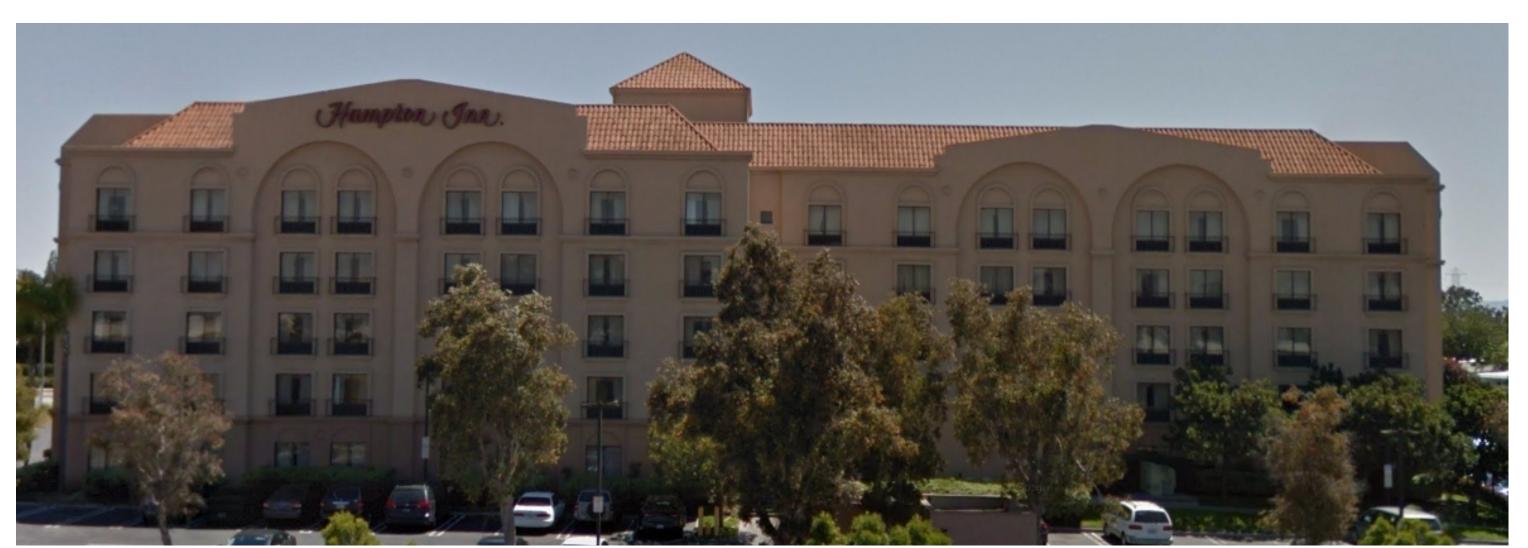

(E) NORTH ELEVATION SCALE: N/A

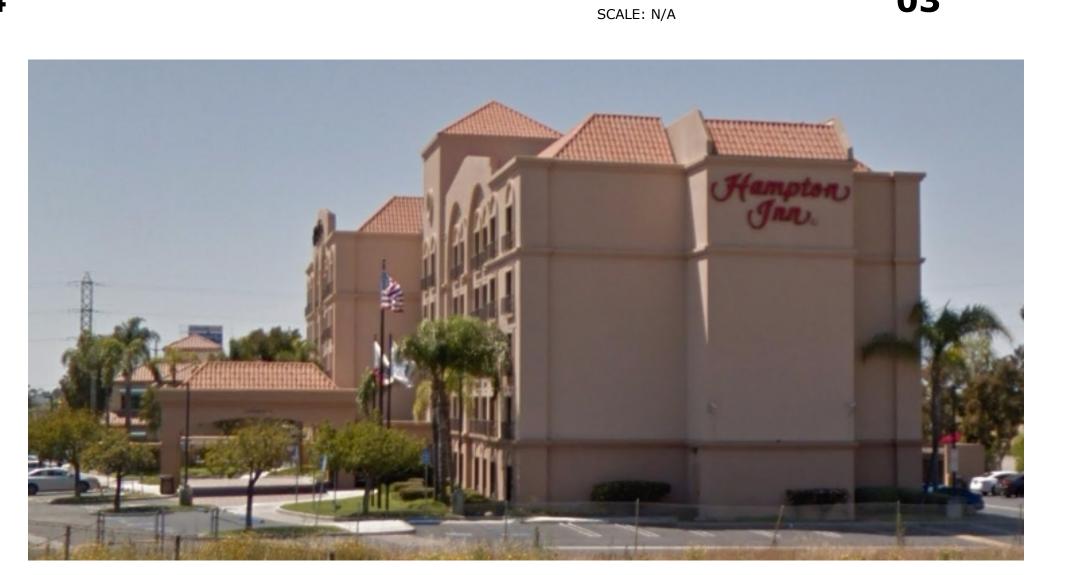

(E) EAST ELEVATION SCALE: N/A

01

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N/A



(E)SOUTH ELEVATION 1/8" = 1'-0"

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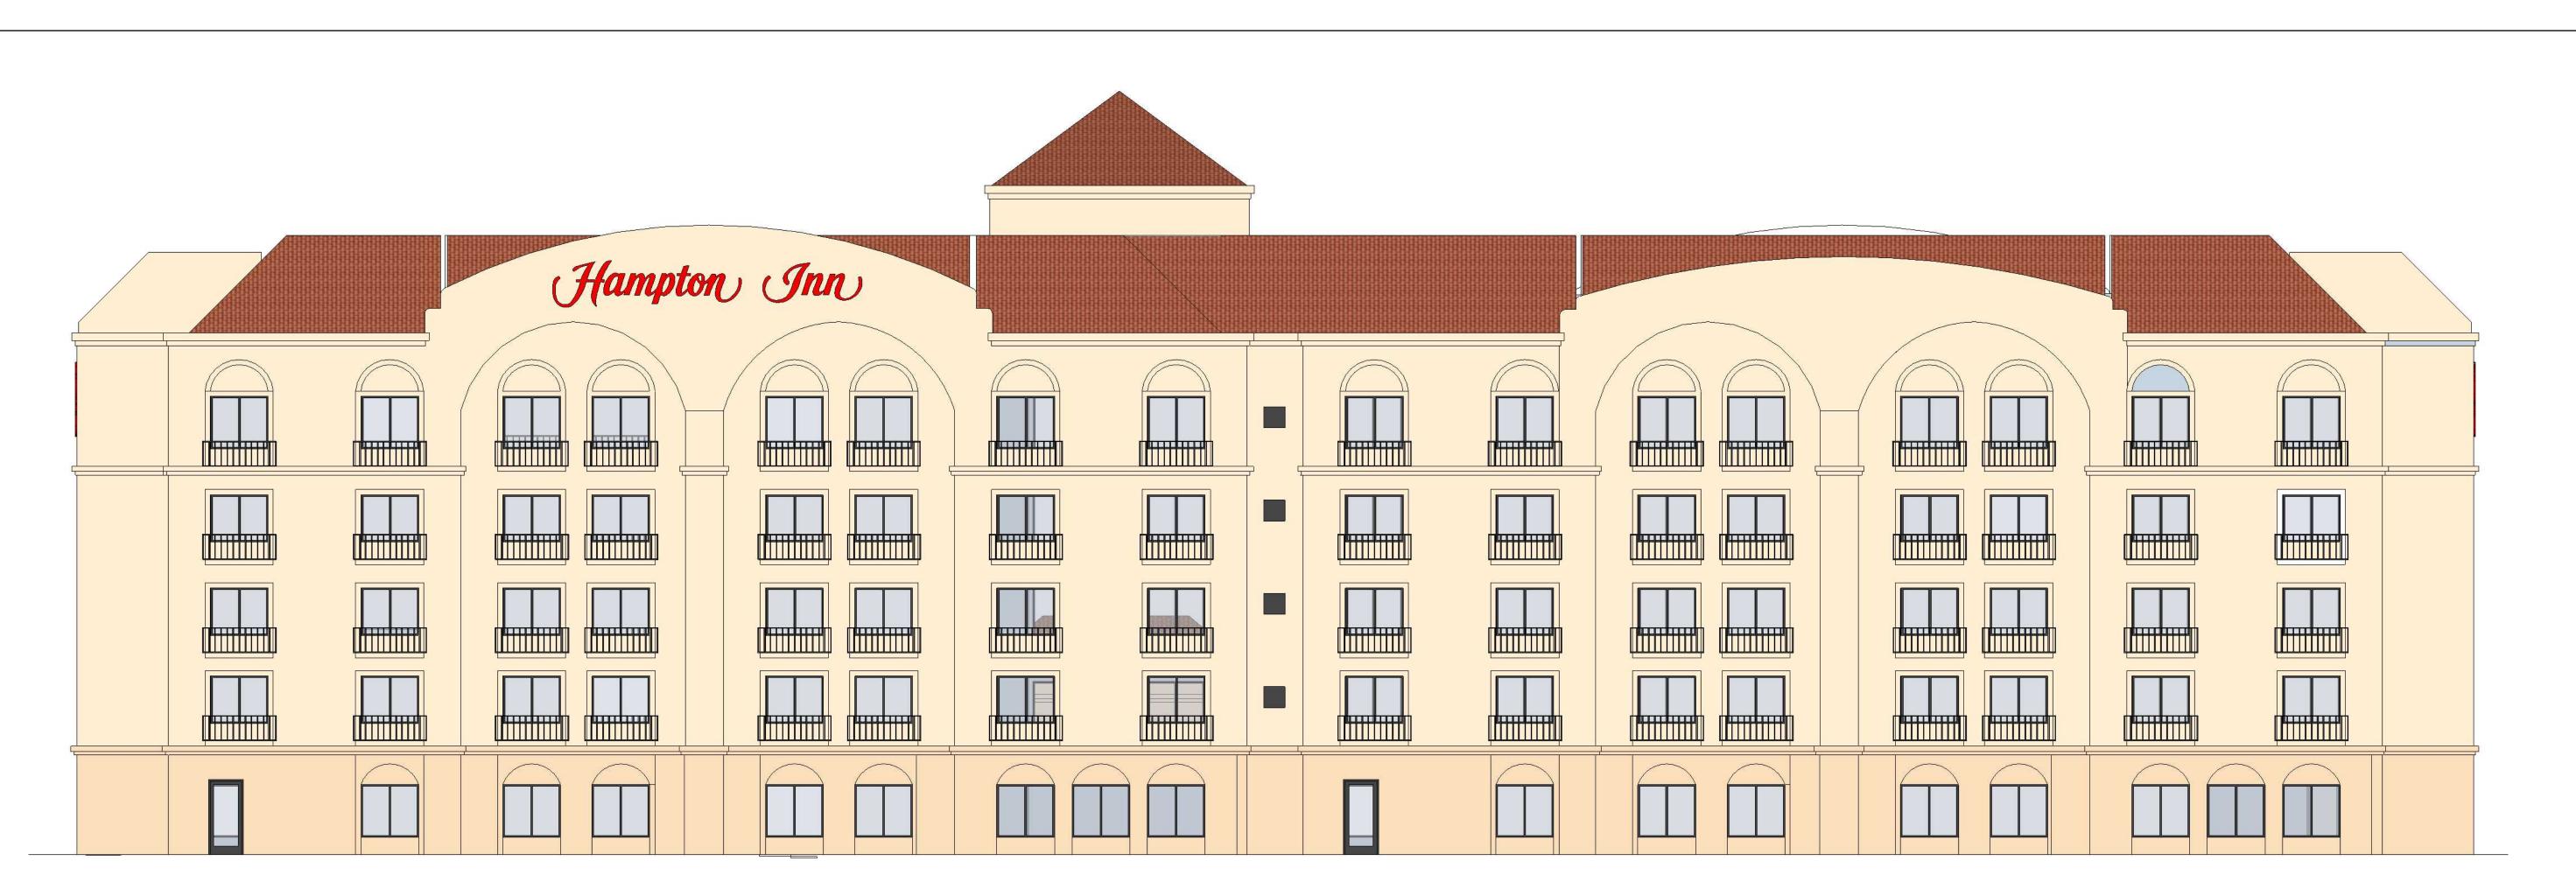


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1/8"=1'-0"



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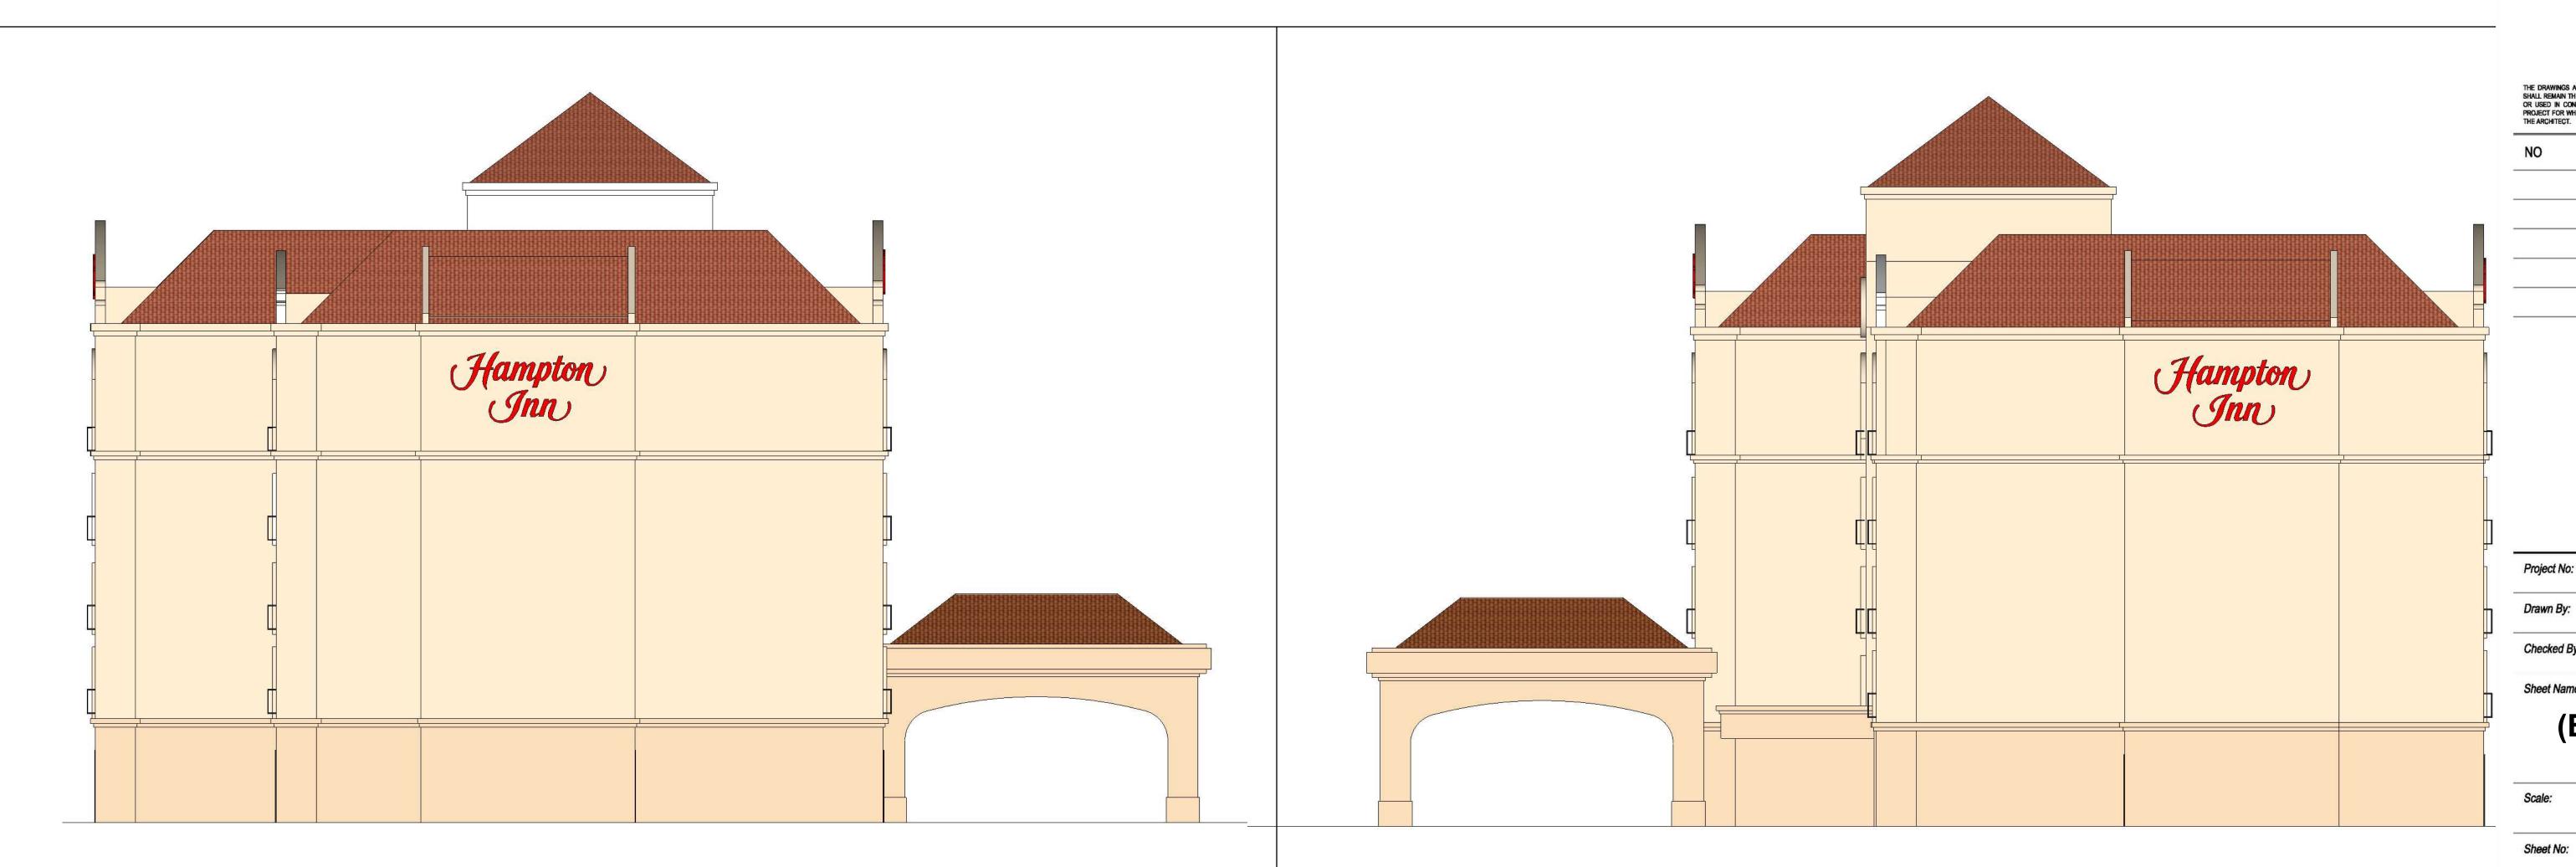
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Sheet Name:

(E) EXTERIOR

1/8"=1'-0"

AE-3

WEST ELEVATION 1/8" = 1'-0"

EAST ELEVATION 1/8" = 1'-0"



(N)SOUTH ELEVATION 1/8" = 1'-0"



(N)NORTH ELEVATION 01

PROPOSED EXTERIOR

Project No:

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Checked By:

Sheet Name:

1/8"=1'-0"

AE-4

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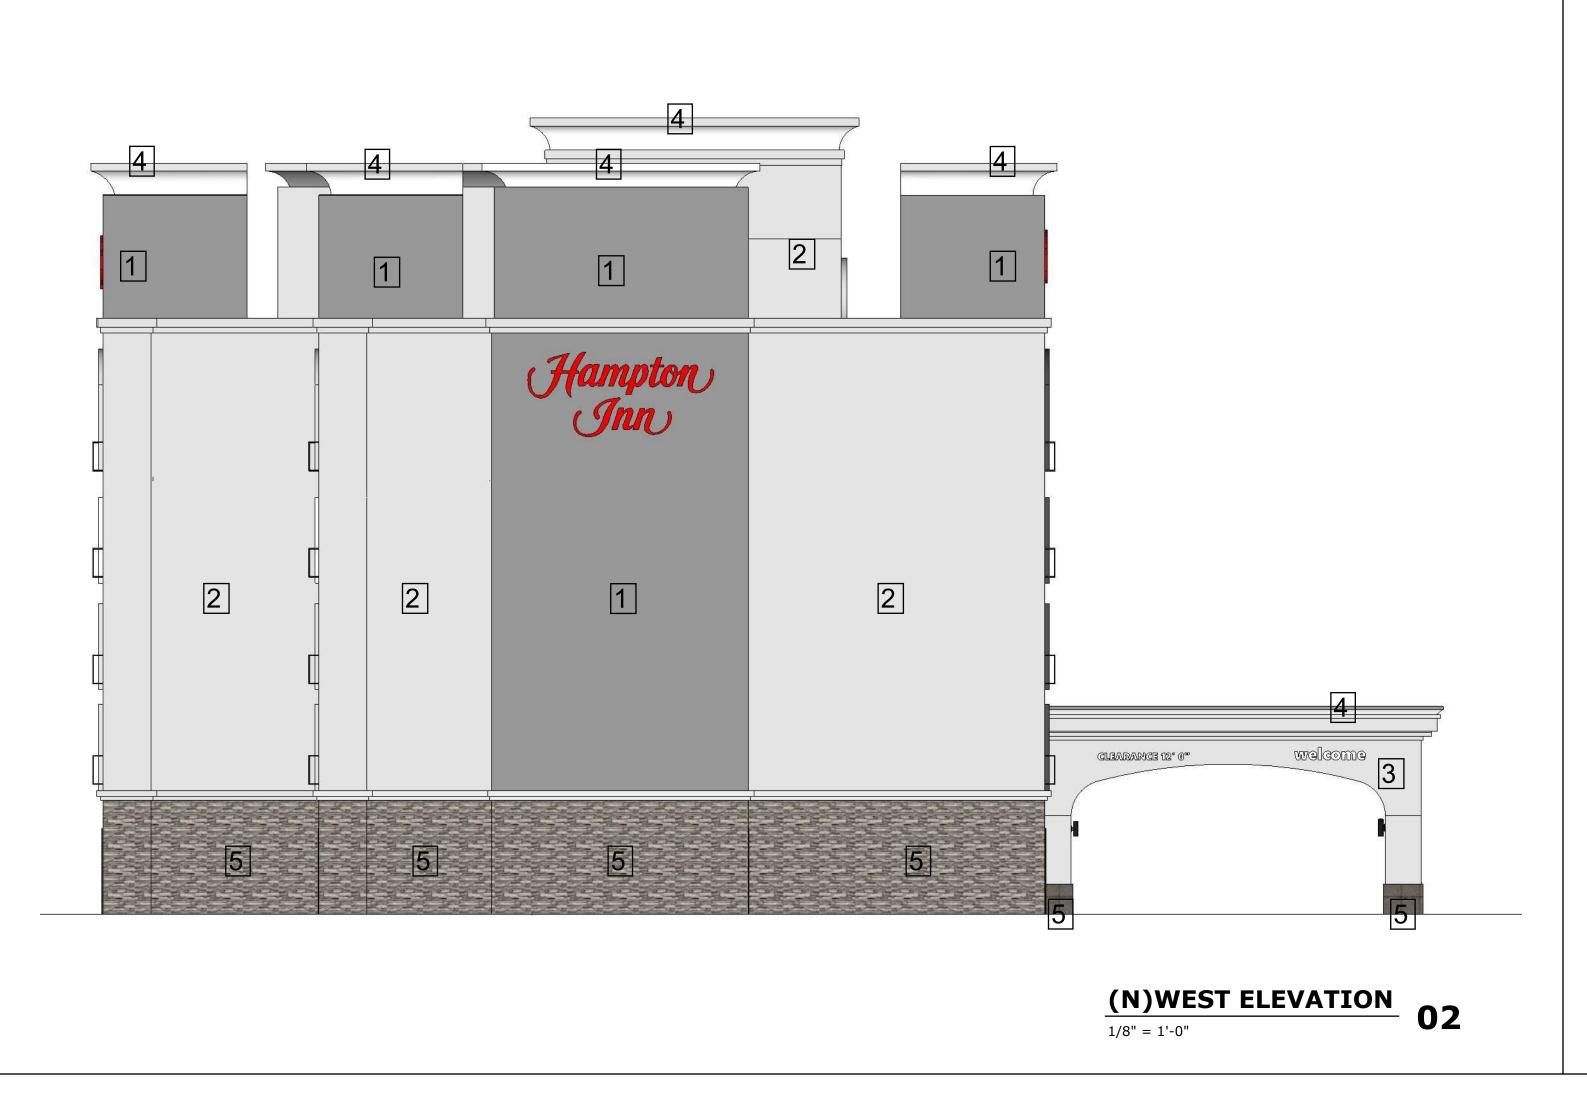
CARSON


767 EAST ALBERTONI STREET CARSON, CA 90746

767 EAST ALBERTONI STREET CARSON, CA 90746

- BENJAMIN MOORE AF-710 SECRET
- BENJAMIN MOORE HC-166 KENDALL CHARCOAL

- BENJAMIN MOORE HC-169 COVENTRY GRAY
- BENJAMIN MOORE OC-130 CLOUD WHITE



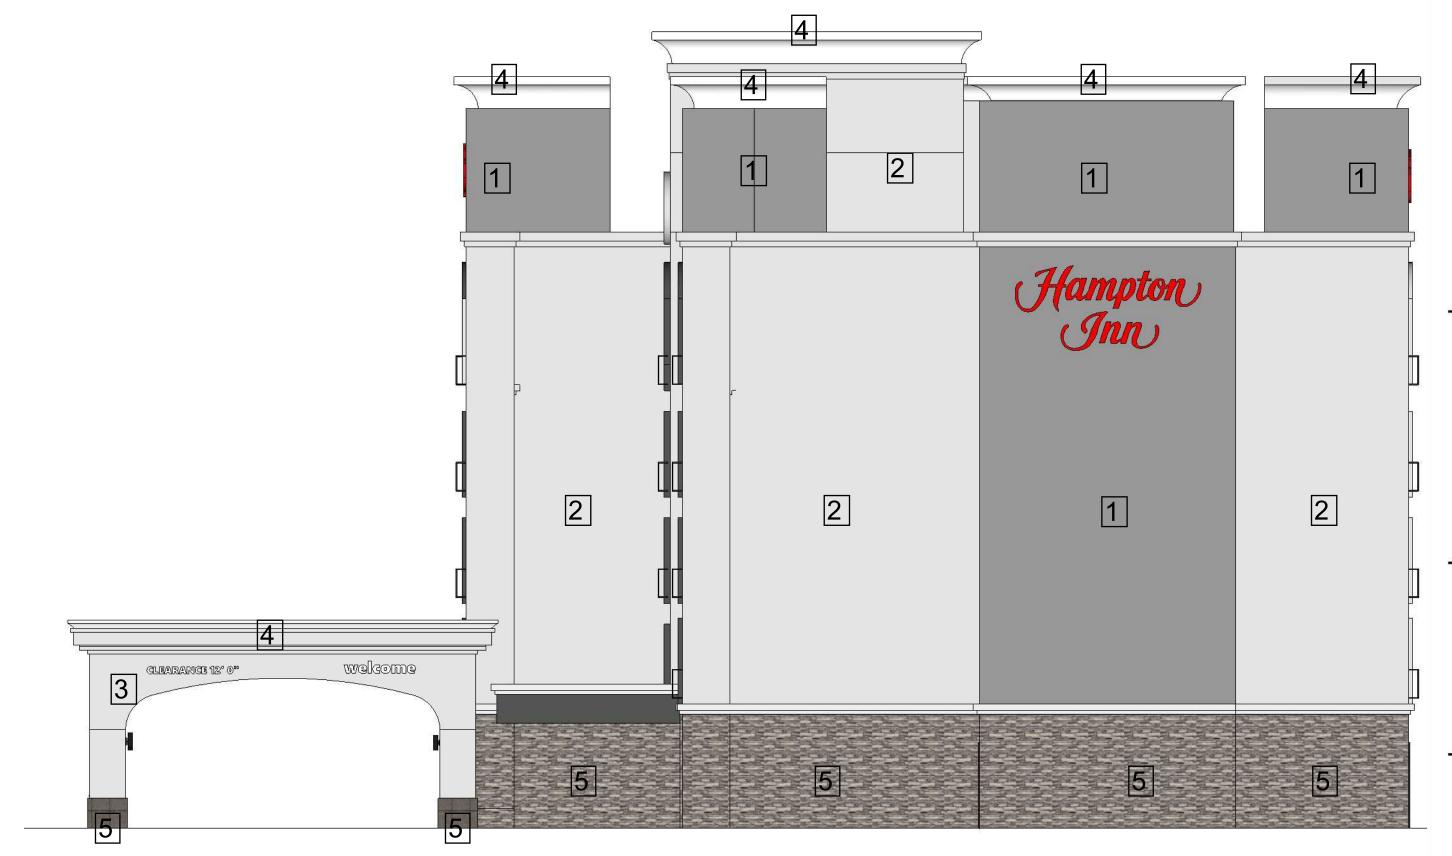

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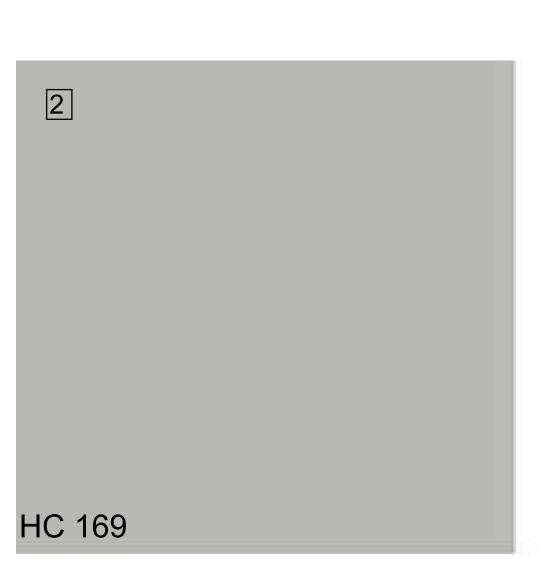
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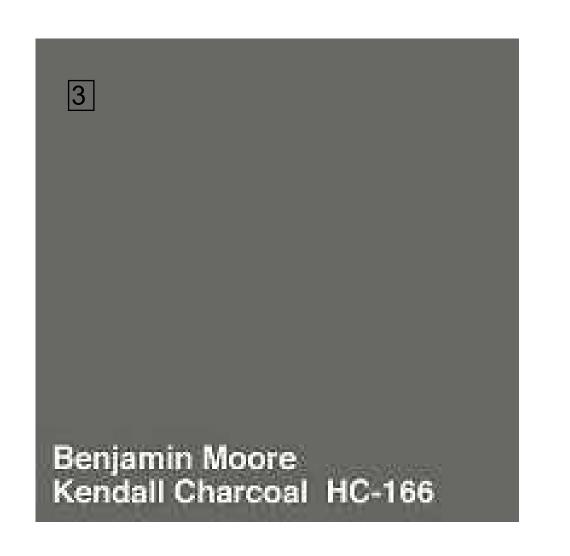
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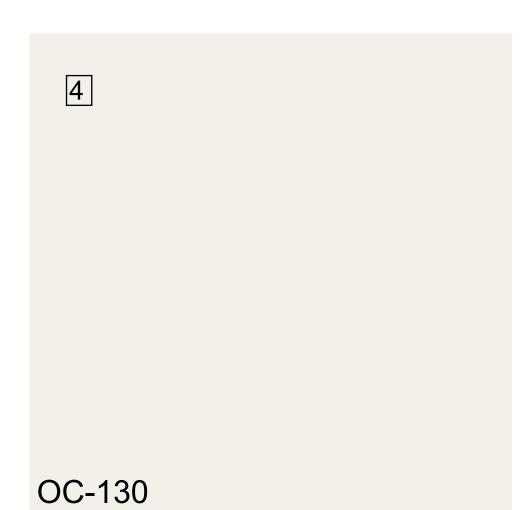
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- BENJAMIN MOORE HC-166 KENDALL CHARCOAL
 - BENJAMIN MOORE OC-130 CLOUD WHITE
- BRICK TILE CORONADO HONEY LEDGE HURON

Benjamin Moore Secret AF-710







BRICK TILE CORONADO HONEY LEDGE HURON

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(N)EAST ELEVATION 01

1636

PROPOSED EXTERIOR

1/8"=1'-0"







RENDERING 3
SCALE: N/A



RENDERING 2

SCALE: N/A

02



RENDERING 1
SCALE: N/A

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PROPOSED EXTERIOR

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