CARSON LOFTS 21240-21250 SOUTH MAIN STREET, CARSON CA 90745

OWNER:	ONSULTANTS ARCHITECT:			
NANCY KIM	NOLO DESIC 2173 LOMITA	SN STUDIO BLVD. SUITE # 201 LOMITA, CA 90717	1. ADDF	RESS:
	PHONE: (310) E-MAIL: artast	464-8404 pai@gmail.com	2. CROS	SS STREET:
OWNER REPRESENTATIVES: -	STRUCTURAL EN -	IGINEER:		BLOCK & LC
-	-		4. ZONII	INC
SURVEY:	MECHANICAL & F	PLUMBING ENGINEER:		JECT DESCRI
BRUCE BORNEMANN 1814 W 247TH ST. LOMITA, CA 90717 PHONE: (310) 467-2333	-			
GEOTECHNICAL CONSULTANT:	ELECTRICAL ENG	GINEER:	6. CODE	ES USED:
-	-			-0 0020.
LANDSCAPE:	CIVIL ENGINEER:			
- -	-			
DEFERRED SUBMITTA	ALS	APPLICABLE CODES		
1 - AUTOMATIC FIRE SPRINKLER PLANS.		IFORNIA BUILDING CODE 2020 COUNTY OF LOS ANGELES BUILDING CODES		TING SITE CC
		ALONG WITH ALL AMENDMENTS IFORNIA PLUMBING CODE	8. LOT A	AREA
	• 2019 CAL	IFORNIA MECHANICAL CODE IFORNIA ELECTRICAL CODE	9. DENS	SITY
	• 2019 CAL	IFORNIA FIRE CODE IFORNIA ENERGY CODE - TITLE 24 IFORNIA GREEN BUILDING STANDARDS CODE		
		INTY OF LOS ANGELES FIRE CODE		UPANCY
		SCOPE OF WORK		STRUCTION -
		RY APARTMENT BUILDING WITH PARKING AT GRADE. EE T-002 FOR PROJECT DATA ***		BACKS
				DING AREA
		NOTE	15. LOT (COVERAGE
		NOTE	16. VEHI	ICLE PARKIN
			17. CA GI	REEN REQ'T
A/C AIR CONDITIONING ABV. ABOVE ADJ. ADJUSTABLE A.F.F. ABOVE FINISH FLOOR AL. ALUMINUM	ABBREVIATIONS FIN. FINISH FIX. FIXTURE FL. FLUORESCENT FLASH. FLASHING FLR. FLOOR	PL. PLATE / PROPERTY LINE PLUMB. PLUMBING PLYWD. PLYWOOD PR. PAIR	17. CA G	REEN REQ'T
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	PR	OJECT	SU	MMAF	RY		
		LOT A - 21250 LOT B - 21240					
REET:		MAIN STREET	CORNE	R OF 213TH S	TREET		
K & LOT:		#7334-002-007 #7334-002-008					
		CG-D (CHANG	E TO NE		PLAN)		
DESCRIPTION	:	2 NEW 3-STO	ry Buili	DINGS W/ PAF	KING AT	GRADE: (30	FT. HIGH)
		LOT A (21250 LOT B (21240					3
ED:			ounty (Dments Rnia plu Rnia me(Rnia ele Rnia fir Rnia ene Rnia gri	DF LOS ANGL S IMBING CODE CHANICAL CO CTRICAL COI E CODE ERGY CODE - EEN BUILDING	DE DE TITLE 24 S STANDA	RDS CODE	LONG WITH
	ONS	VACANT LOT					
		LOT A = 12, LOT B = 10, TOTAL LOT A	564 SF		N STREET		
		MAX. DENSIT 40 per Acre ; 40 per Acre ;		SITY ALLOWE 11 UNITS 9 UNITS	D DE	NSITY PRON 11 UNIT 8 UNIT	S
CY		R2					
CTION TYPE		TYPE - VA					
5		*SEE SITE PL	AN				
ORIES	3						
AREA		4: 21250 Main S B: 21240 Main S		= 12,3 = 10,5			
RAGE		A: 21250 MAIN \$ B: 21240 MAIN \$,	49 SF (58 38 SF (5		
PARKING	42 CC	VERED (NOT E	NCLOSE	D) PARKING /	AREAS		
REQ'TS:	4.3 B) Plu app	plumbing fixture: 03 mbing fixtures @ ilicable standard: gation controllers) fittings s s listed in	shall be installe the 2016 CPC	d in accor	dance with th I401.1	e

PLUMBING: -ELECTRICAL: - -

SYMBOLS (PARTIAL LIST)


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BUILDING SECTION NUMBER SHEET NUMBER	<u>2 1</u> (W1)	WALL TYF OF MULTI
DETAIL NUMBER SHEET NUMBER	\bigcirc	NOTED
ELEVATION, X REFERENCE OR DATUM	RA#	REDUCER SEE SCHE
DOOR NUMBER	ES#	SEALANT SEE SCHE
WINDOW LETTER(S)	FRS#	FIRE RET
REVISION NUMBER WITH CLOUD	100 ELEC	ROOM RE
ACCESSORY NUMBER, REFER TO ACCESSORY		WOOD FI
SCHEDULE		WOOD CO
COLUMNS - SIZE AS NOTED ON STRUCTURAL SHEETS		WOOD BL
FLUSH SURFACES		PLYWOOD
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NOT IN CONTRACT BY OTHERS N.I.C. HAS TO BE WRITTEN	*	DETAIL NI LETTER S


WITH DASHED LINES) KEYNOTE
WALL TYPE W/ LOCATION OF MULTIPLE LAYERS WH/ NOTED
REDUCER STRIP / FLOOR ASSEMBLY - SEE SCHEDULE
SEALANT DESIGNATION - SEE SCHEDULE
FIRE RETARDANT SEALANT - SEE SCHEDULE
ROOM REFERENCE
WOOD FINISH
WOOD CONTINUOUS
WOOD BLOCKING
PLYWOOD
GYP BD
DETAIL NUMBER / LETTER SHEET NUMBER


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		DESIGN STUDIO
		2173 LOMITA BLVD. #201 LOMITA CALIFORNIA 90717 Architect: ART ASHAI, AIA 2173 LOMITA BLVD. #201 LOMITA CALIFORNIA 90717 PHONE: 424-263-5888 email: artashai@gmail.com
SHEET INDEX		Copyright: This drawing is the property of DESIGNER, and it is not to be reproduced or copied in whole or part. It is not to be used for any other project and is to be returned upon request. The DESIGNER retains all copyrights for this document. Owner:
CIVIL: C-001 SURVEY I OF 3 GRADING AND DRAINAGE TITLE SHEET	ARCHITECTURAL: T-001 TITLE SHEET T-002 PROJECT DATA	NANCY KIM -
STRUCTURAL:	A-001 SITE PLAN A-003 OPEN SPACE PLAN A-101 FIRST FLOOR OVERALL PLAN A-102 SECOND FLOOR OVERALL PLAN A-103 THIRD FLOOR OVERALL PLAN A-104 ROOF PLAN A-111 BUILDING A - UNIT PLANS A-112 BUILDING A - UNIT PLANS A-113 BUILDING A - UNIT PLANS A-121 BUILDING B - UNIT PLANS A-122 BUILDING B - UNIT PLANS A-123 BUILDING B - UNIT PLANS A-124 BUILDING B - UNIT PLANS A-201 ELEVATIONS A-202 ELEVATIONS A-202 ELEVATIONS A-202 SECTIONS A-301 SECTIONS A-302 SECTIONS A-302 SECTIONS LO TITLE SHEET L.0 GROUND FLOOR CONCEPTUAL PLAN L.1 SECOND FLOOR CONCEPTUAL PLAN L.2.0 PLANT PALETTE	CARSON LOFTS 21240 MAIN STREET & 21250 MAIN STREET CARSON, CALIFORNIA 90745
		PROJECT INFORMATION: Project Title : CARSON APARTMENTS 21240 Main Street Carson, CA 90745 21250 Main Street Carson, CA 90745 LEGAL DESCRIPTION : APN: 7334-002-007 APN: 7334-002-008
VICINITY MAP		ATHAR ASIIAI ↓ ↓ ↓ ↓ ↓ ↓ ↓ ↓ ↓ ↓ ↓ ↓ ↓
	LOT-A 21250 SOUTH MAIN STREET (PROPOSED 8-UNIT APT. BLDG) VI-UNIT APT. BLDG) STREET	Rev. # Date/Issue Notes 1
		AS NOTED J-1908 Date : Aug2021 Sheet Number : Drawn : arkihaus Check'd : CTV/RRJ T-001

RECIPROCAL EASEMENT AGREEMENT (REA)

- A REA for reciprocal access, parking, utilities, and waste disposal shall be recorded against both properties (APN 7334-002-007 and APN 7334-002-007) prior to the issuance of building permits.
- The City of Carson shall review and approve the REA prior to recordation.
- The REA shall take effect immediately upon recordation.
- The City of Carson shall be a named third-party beneficiary of the REA. The REA shall not be amended or terminated without prior written consent from the City of Carson.

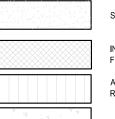BUILDING INFORMATION:

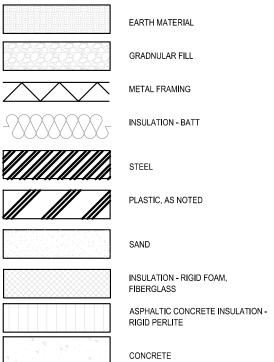21250 M	ain Street, Ca	
Lot Area: Max. Density: Density Allowed: Density Proposed:		
Unit #	Туре	
101	2B + 2Ba	
201	2B + 2Ba	
202	2B + 2Ba	
203	2B + 2Ba	
204	2B + 2Ba	
205	2B + 2Ba	
301	2B + 2Ba	
302	2B + 2Ba	
303	2B + 2Ba	
304	2B + 2Ba	
305	2B + 2Ba	
	TOTAL	
Common	open space	
	Lot Area: Max. Der Density A Density F Unit # 101 201 202 203 204 205 301 302 303 304 305	

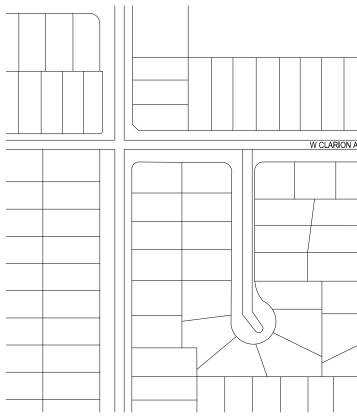Total open space


Parking provided:

Common Flo	or Area
1st Floor =	540 S
2nd Floor =	420 S
3rd Floor =	150 S
TOTAL =	1,110

BUILDING INF

LOT AREA = MAX DENSITY = DENSITY ALLOWED : DENSITY PROPOSE COMMON OPEN SPA PRIVATE OPEN SPAC TOTAL OPEN SPACE PARKING REQUIRED PARKING PROPOSE PROPOSED LOT COV PROPOSED BUILDIN PROPOSED FAR = PROPOSED BLDG. H

PROJECT AREAS

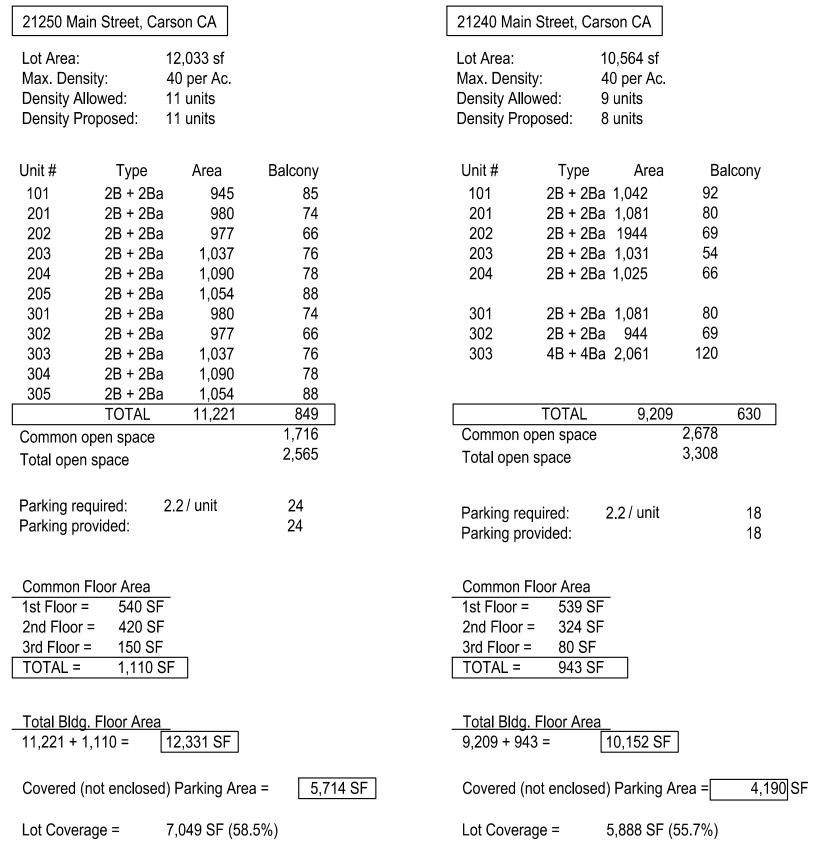

FOF	RMA		0	N :
		\ 		Ν.

	22,597 (0.52 ACRES)
	40 UNITS / ACRE
) =	20.8 UNITS (20 UNITS)
D =	19 UNITS
ACE =	4,394 SF
ACE =	1,479 SF
E =	5,873 SF (309 SF / UNIT)
D =	19 x 2.2 = 41.8= 42 SPACES
ED =	24 + 18 = 42 SPACES (INCLUDING 4 H/C)
OVERAGE =	7,049 + 5,888 = 12,937 SF (57.25%)
NG FLOOR AR	EA = 22,483 SF
	1.0

PROPOSED BLDG. HT. =	39 FT.
(MEASURED TO ROOF LVL.)	

	S T I		
2173 LOMITA LOMITA CALIF			
Architect: ART ASHAI, AIA 2173 LOMITA BLVD. #201 LOMITA CALIFORNIA 90717 PHONE: 424-263-5888 email: artashai@gmail.com			
Copyright : This drawing is the property of DESIGNER, and it is not to be reproduced or copied in whole or part. It is not to be used for any other project and is to be returned upon request. The DESIGNER retains all copyrights for this document. Owner : NANCY KIM -			
CARSON LOFTS	21240 MAIN STREET & 21250 MAIN STREET	CARSON, CALIFORNIA 90745	
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Rev. # Date/Issue 1		Notes	
Sheet Title : PROJ. A AND SU			
Scale : AS NOTED Date : Aug2021		Number : J-1908 et Number :	

Balcony

80

69

66

80

630


18

18

T-002

Drawn: arkihaus

Check'd : CTV/RRJ

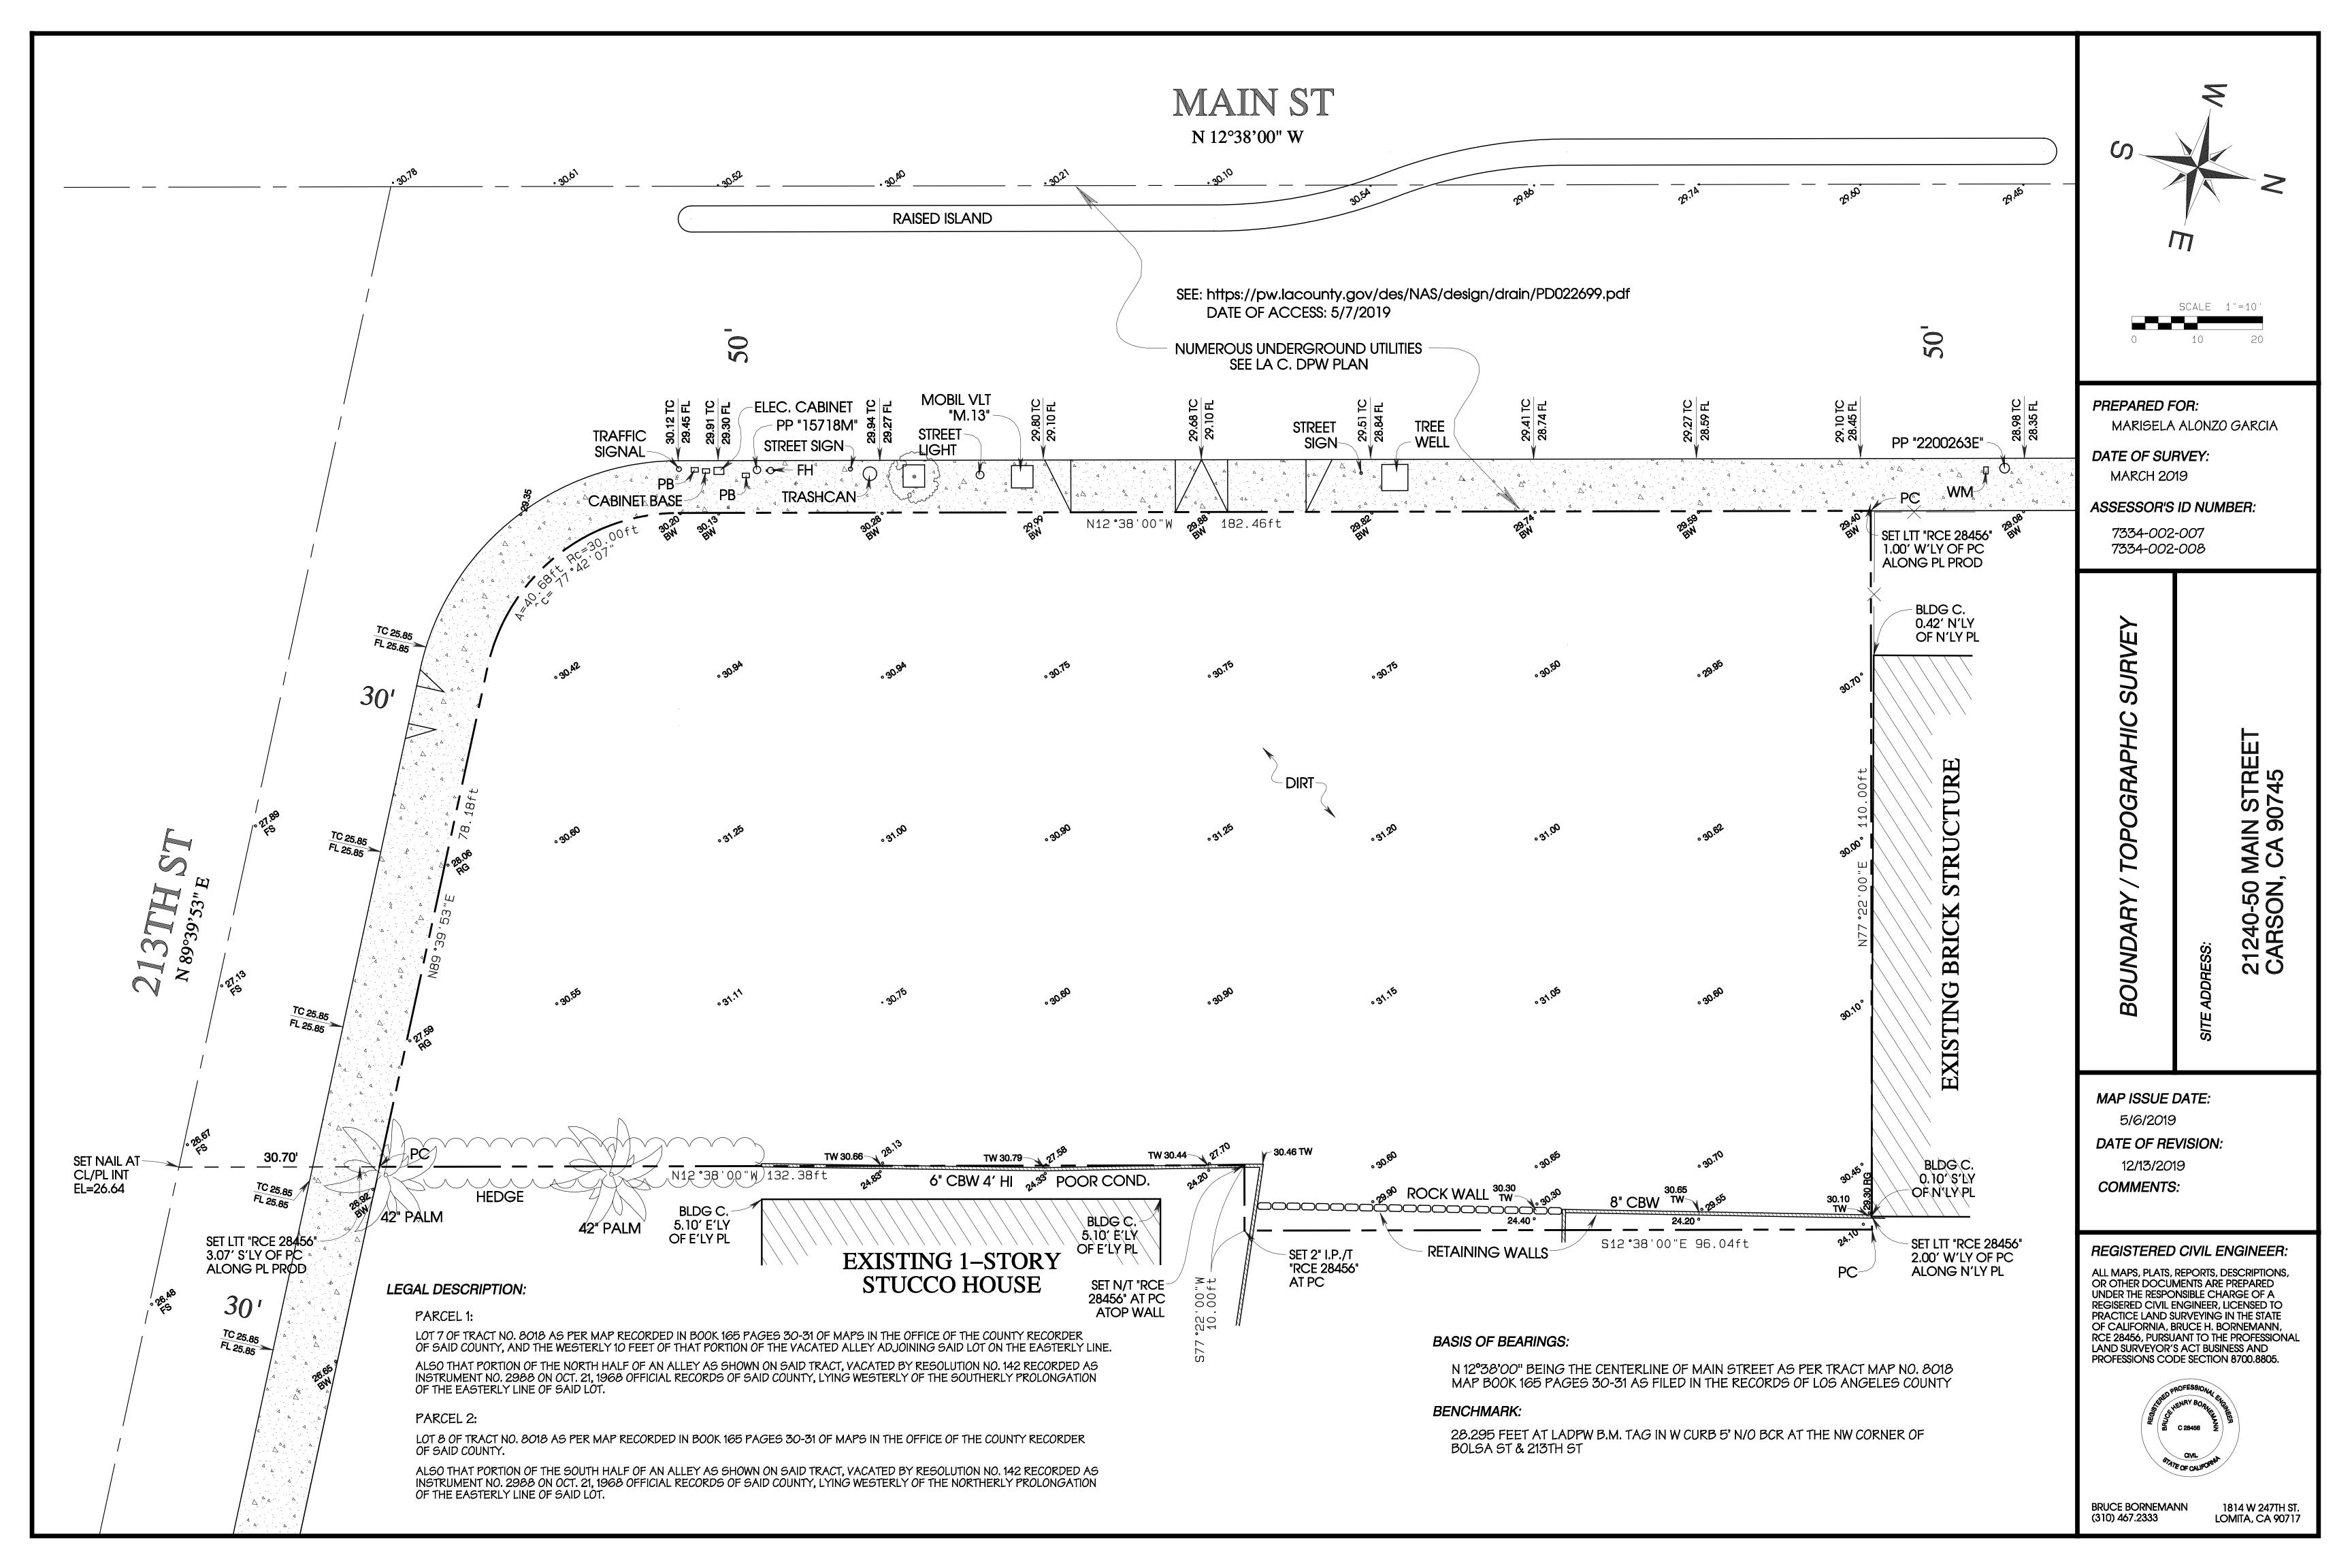

PROJECT INFORMATION:

WATER PURVEYOR: CALIFORNIA WATER SERVICE COMPANY TOTAL LANDSCAPE AREA : 3164 SQUARE FEET

PARCEL INFORMATION : 21240 MAIN STREET & 21250 MAIN STREET CARSON, CA 90745

A.P.N. 7334-002-007 A.P.N. 7334-002-008

GENERAL NOTES:

1. OWNER TO MAINTAIN LANDSCAPE AND IRRIGATION SYSTEM

2. STREET TREES WITHIN THE PUBLIC RIGHT-OF-WAY ARE TO BE PLANTED PER APPROVED STREET IMPROVEMENT PLANS.

3. ALL HARDSCAPES, RETAINING WALLS, SWIMMING POOLS, AND/OR BLOCK WALLS MUST BE REVIEWED AND APPROVED UNDER A SEPARATE PERMIT.

4. ALL PLANTS ARE IN COMPLIANCE WITH MODEL WATER EFFICIENT LANDSCAPE ORDINANCE (MWELO).

5. CONTRACTOR TO PROTECT AND PRESERVE IN PLACE ALL EXISTING SURVEY MONUMENTS. ANY MONUMENT DISTURBED SHALL BE RESET BY A LICENSED LAND SURVEYOR AND THE APPROPRIATE CORNER RECORD MUST BE FILED WITH THE COUNTY OF LOS ANGELES.

6. TREE CANOPIES ARE SHOWN AT FULL MATURITY.

7. AUDIT SHALL BE IN ACCORDANCE WITH THE LATEST STATE OF CALIFORNIA LANDSCAPE WATER MANAGEMENT PROGRAM AS DESCRIBED IN THE LATEST LANDSCAPE IRRIGATION AUDITOR HANDBOOK. THE LANDSCAPE IRRIGATION AUDITS TO BE CONDUCTED BY A QUALIFIED INDIVIDUAL AND THE AUDIT SCHEDULE SHALL BE CONDUCTED AT LEAST ONCE EVERY FIVE YEARS IN ACCORDANCE WITH THE REQUIREMENTS OF TITLE 20, DIVISION 1 OF THE LOS ANGELES COUNTY CODE.

8. TOTAL PROPOSED LANDSCAPE AREA: 3164 S.F.

9. TOTAL TURF AREA = 0 S.F. IS 0% OF TOTAL LANDSCAPE AREA.

10. TOTAL DROUGHT TOLERANT LANDSCAPING AREA = 3164 S.F. IS 100% OF THE TOTAL PROPOSED LANDSCAPE AREA.

11. HYDROZONING IRRIGATION TECHNIQUES SHALL BE INCORPORATED INTO THE LANDSCAPE DESIGN.

12. THIS PROJECT REQUIRES A LANDSCAPE PERMIT. PRIOR TO FINAL, CERTIFICATION FROM A LICENSED LANDSCAPE ARCHITECT SHALL BE PROVIDED TO THE BUILDING OFFICIAL. FINAL CERTIFICATION CAN BE OBTAINED AT THE FOLLOWING: http://dpw.lacounty.gov/bsd/publications/index.cfm


SHEET INDEX

L.0 TITLE SHEET

- L.1.0 CONCEPTUAL PLAN GROUND FLOOR
- L.1.1 CONCEPTUAL PLAN SECOND FLOOR
- L.2 PLANT PALETTE


Site Information		21240-21250 M	AIN ST. CARSON,	CA 90745				re.
	Site Type →	Residential	Allowed ETAF		1			
Annual	Eto (inches/yr) →	42.6	Allowed LTA	. 0.55				
		42.0						
Hydrozone or Planting Description	Plant Fact	or (PF)	Irrigation Method	Irrigation Efficiency (IE)	ETAF (PF/IE)	Hydrozone Area (sqft.)	ETAF x Area	Estimated Total Water Use (gal./yr.)
Regular Landsca	e Areas							
1	0.3	Low	Bubbler	0.81	0.4	22	8	21
2	0.3	Low	Bubbler	0.81	0.4	22	8	21
3	0.3	Low	Drip	0.81	0.4	158	59	1,55
4	0.3	Low	Drip	0.81	0.4	478	177	4,67
5	0.3	Low	Bubbler	0.81	0.4	13	5	13
6	0.3	Low	Drip	0.81	0.4	941	349	9,21
B1	0.3	Low	Bubbler	0.81	0.4	51	19	50
B2	0.3	Low	Drip	0.81	0.4	451	167	4,41
B3	0.3	Low	Bubbler	0.81	0.4	19	7	18
B4	0.3	Low	Drip	0.81	0.4	128	47	1,24
B5	0.3	Low	Drip	0.81	0.4	944	350	9,24
Special Landscap	Areas				SUBTOTAL →	3,227	1,196	31,589
- preser carrescop				1	1		0	
-			-	-	1		0	
	1 1				1		0	
	1		-	1	1		0	1
	4				SUBTOTAL →	0	0	0
							Use (ETWU) →	31,589
							ance (MAWA) →	46,877
							1	
ETAF Calculations					Notes:			
Regular Landscap	e Areas					Water	Efficient	
	Total ETAF x Area		1,196					
	Total Area		3,227			Landscape	Worksheet	
	Average ETAF		0.37		1 0	Adapted from C	alifornia Code of	
					1 3		le 23, Division 2,	
All Landscape Are	as						Model Water	
	Total ETAF x Area		1,196					
	Total Area		3,227	P		Efficient Lands	cape Ordinance	
	Sitewide ETAF		0.37					


SITE WATER USE CALCULATIONS

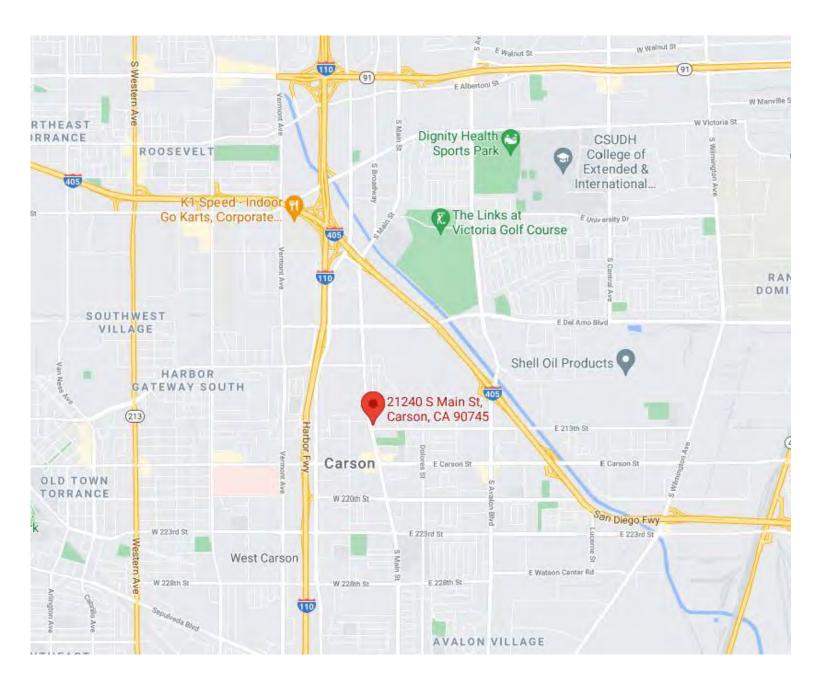

VICINITY MAP


KEY MAP

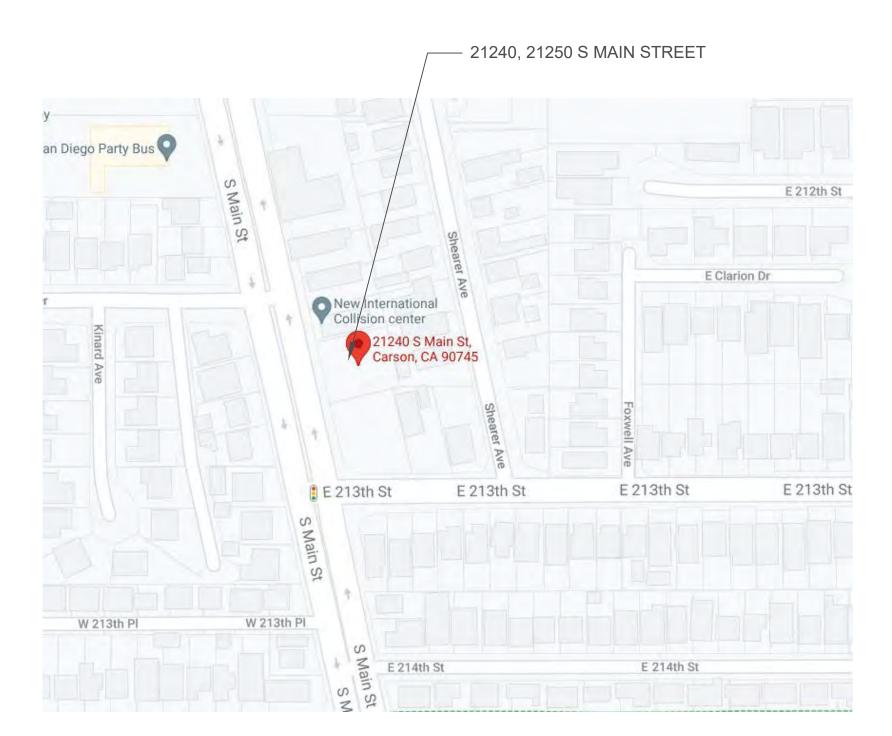


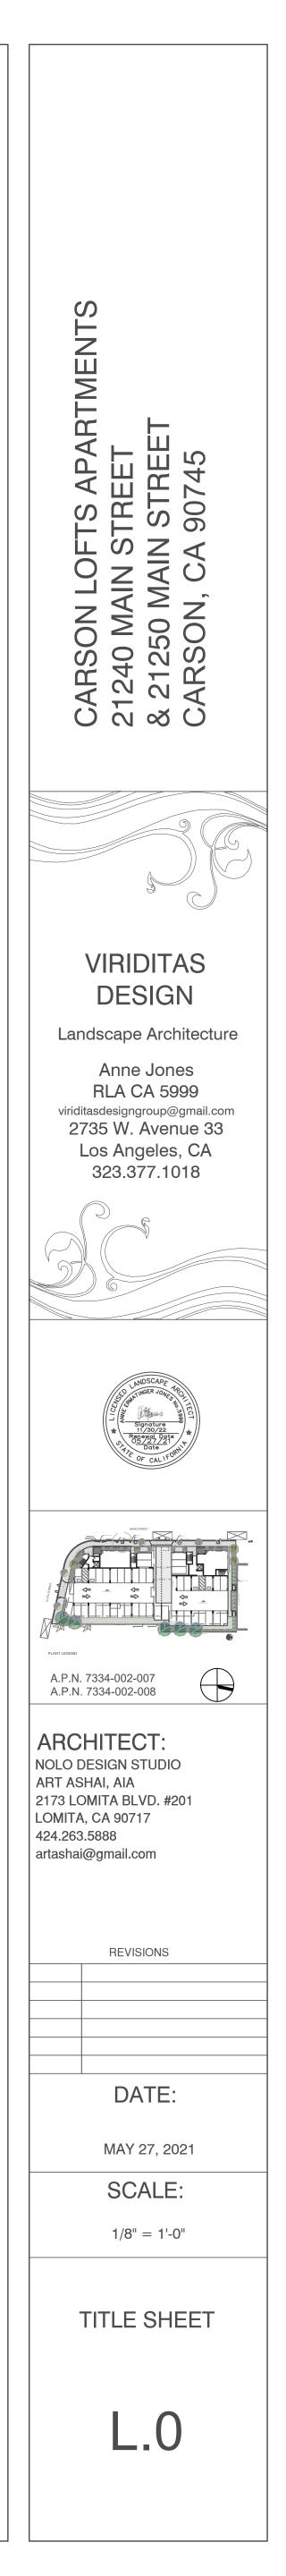

PLANT LEGEND

	BOTANICAL NAME	COMMON NAME	SIZE AT 5 YRS.	PLANT TYPE	WUCOLS RATING						
· · · · · · · · · · · · · · · · · ·	ACHILLEA MILLEFOLIUM	COMMON YARROW	6" X 1'	GROUND COVER	0.3/L		RAPHIOLEPIS INDICA 'CLARA'	INDIAN HAWTHORN	4' X 4'	SHRUB	0.3/L
×	AGAVE ATTENUATA	FOXTAIL AGAVE	2' X 2'	SUCCULENT	0.3/L	•	WESTRINGIA 'BLUE GEM'	BLUE GEM COAST ROSEMARY	6' X 3'	SHRUB	0.3/L
	ALOE STRIATA	CORAL ALOE	2' X 18"	SUCCULENT	0.3/L		WESTRINGIA FRUTICOSA 'GREY BOX'	DWARF COAST ROSEMARY	3' X 3'	SHRUB	0.3/L
	CAREX DIVULSA (TUMULICOLA)	BERKELEY SEDGE	18" X 2'	GRASS LIKE	0.3/L		WESTRINGIA FRUTICOSA 'MUNDII'	MUNDI COAST ROSEMARY	18" X 3'	SHRUB	0.3/L
	<u>GREVILLEA LANIGERA 'COASTAL</u> GEM'	COASTAL GEM	1' X 3'	SHRUB	0.3/L		TREES				
	LANTANA 'NEW GOLD'	NEW GOLD LANTANA	3' X 3'	SHRUB	0.3/L		ARBUTUS MARINA - STANDARD FORM	STRAWBERRY TREE	15' X 12'	TREE	0.3/L
	LAURUS NOBILIS (SHRUB FORM)	SWEET BAY	8' X 4'	SHRUB	0.3/L		GEIJERA PARVIFLORA	AUSTRALIAN WILLOW	14' X 12'	TREE	0.3/L
	LOMANDRA 'NYALLA'	NYALLA MAT RUSH	3' X 3'	GRASS LIKE	0.3/L		PROPOSED PARKWAY TREE	N/A	N/A	TREE	N/A

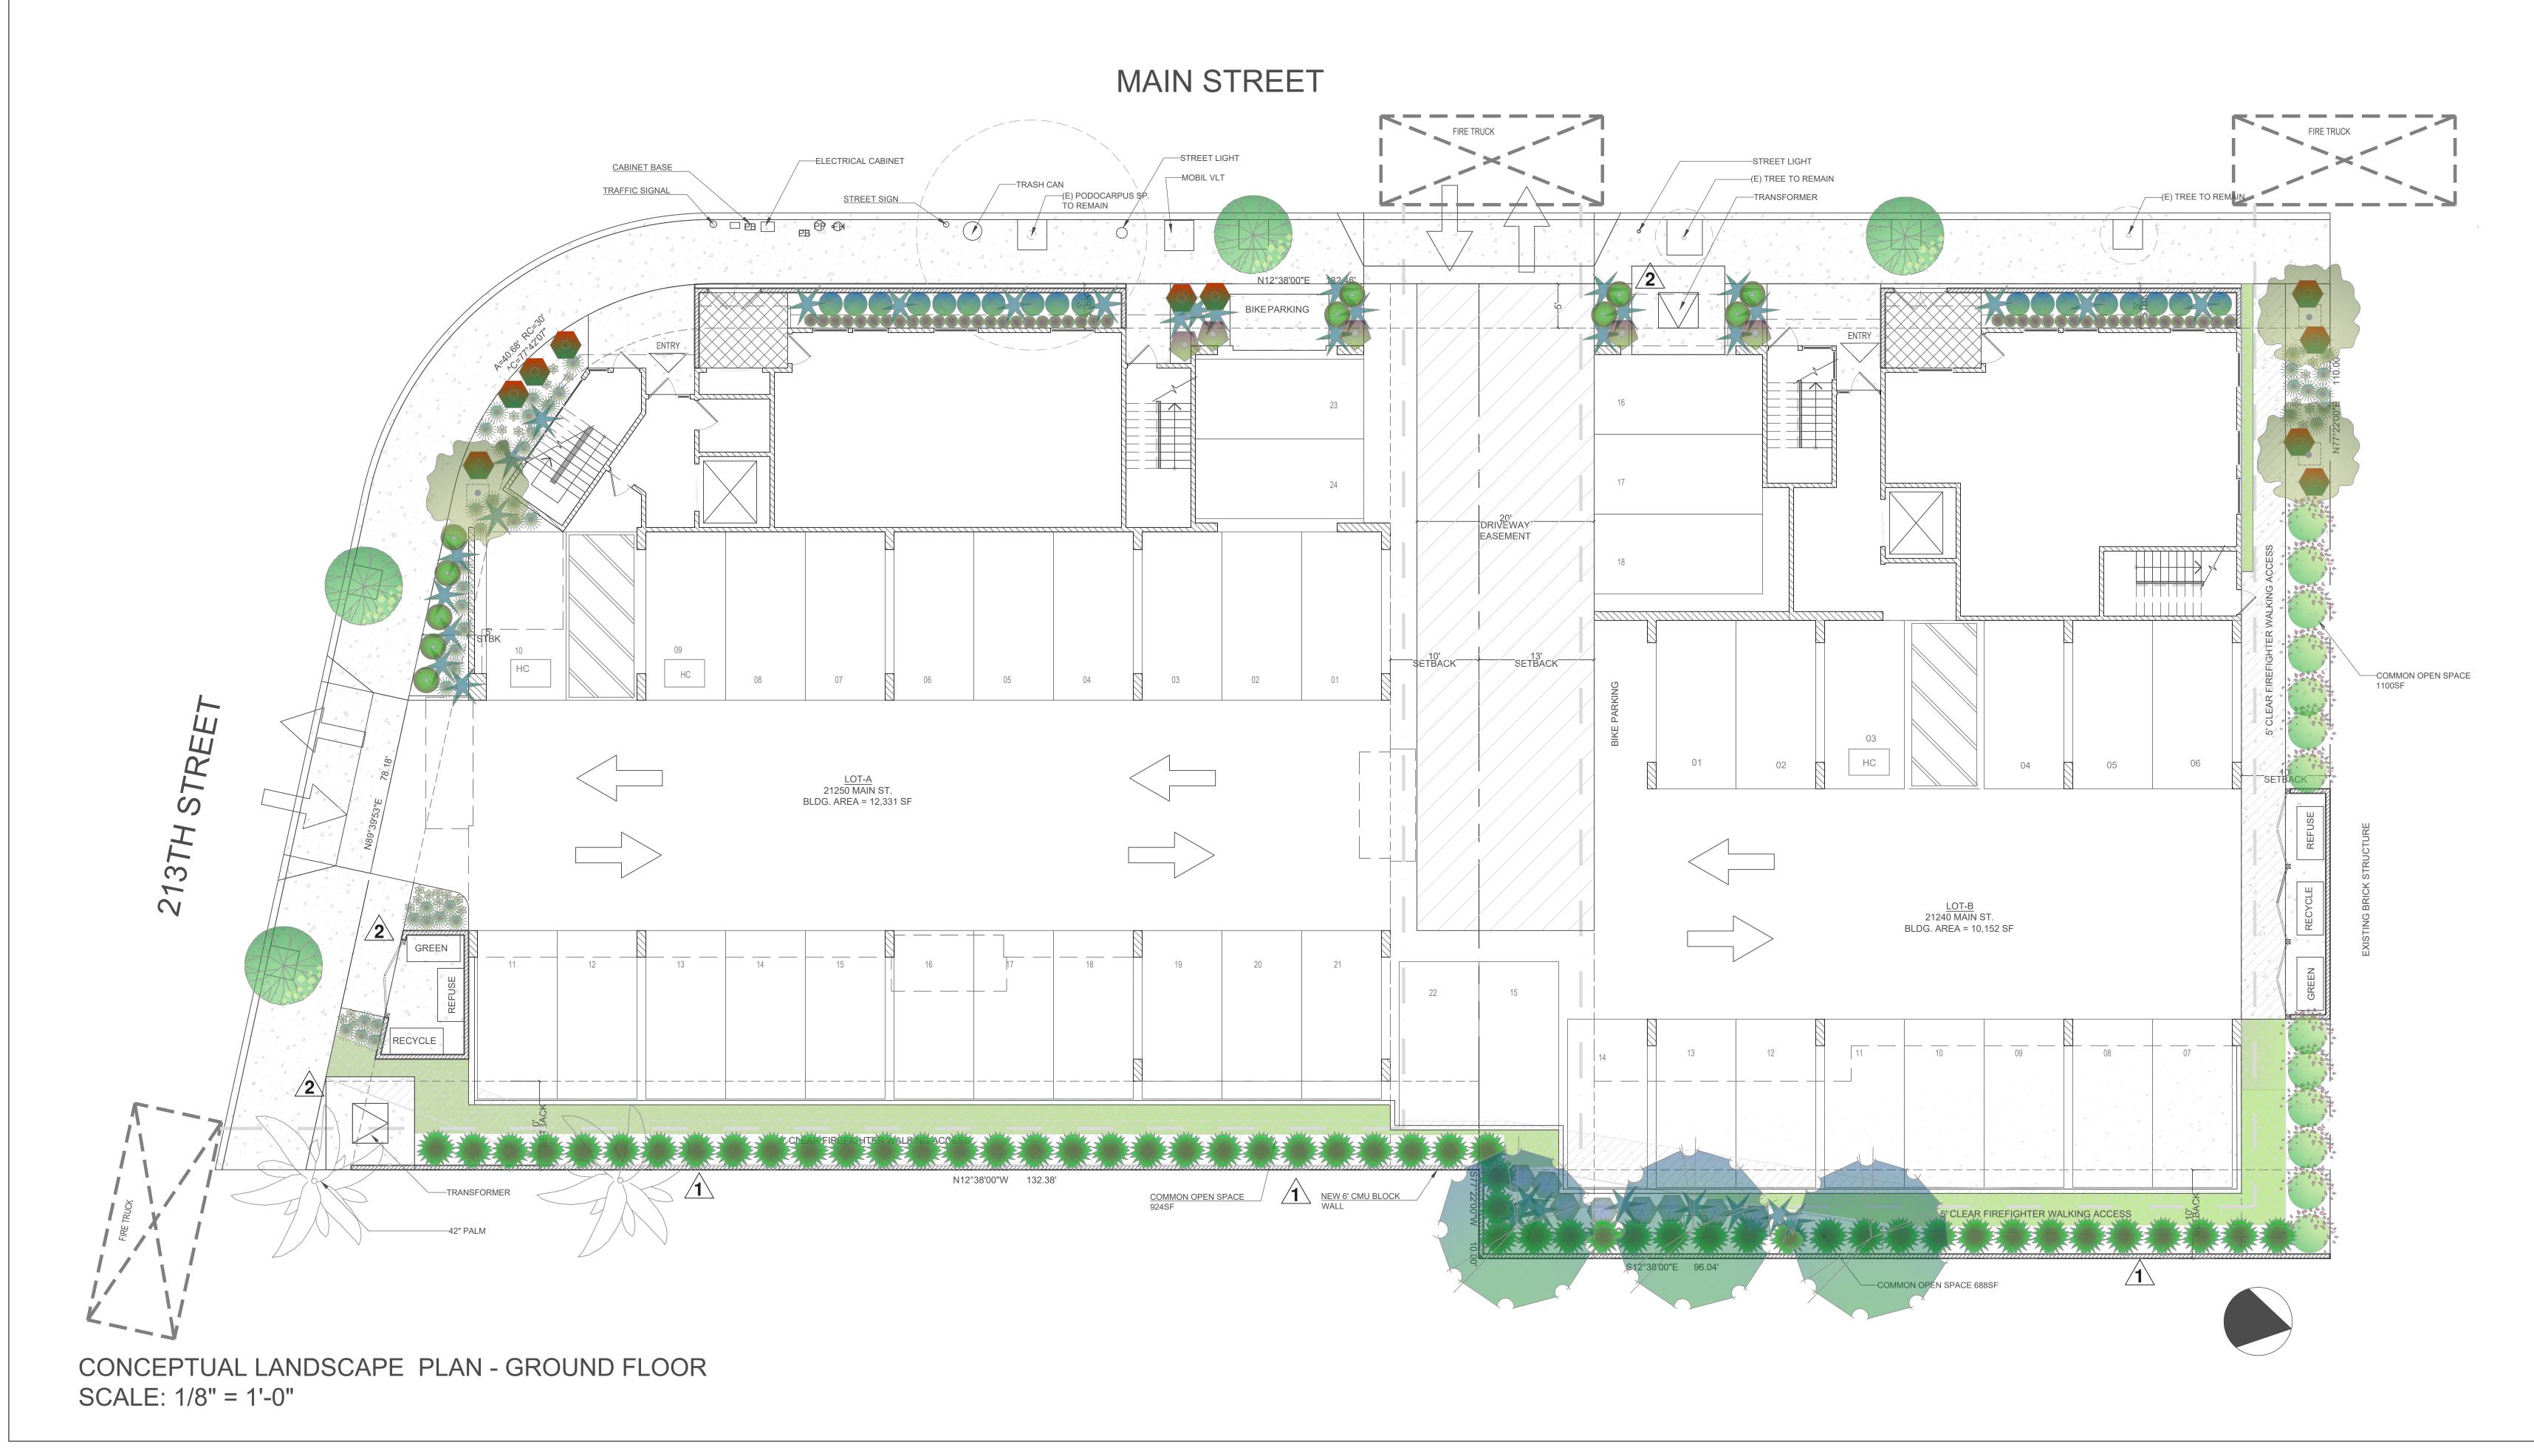


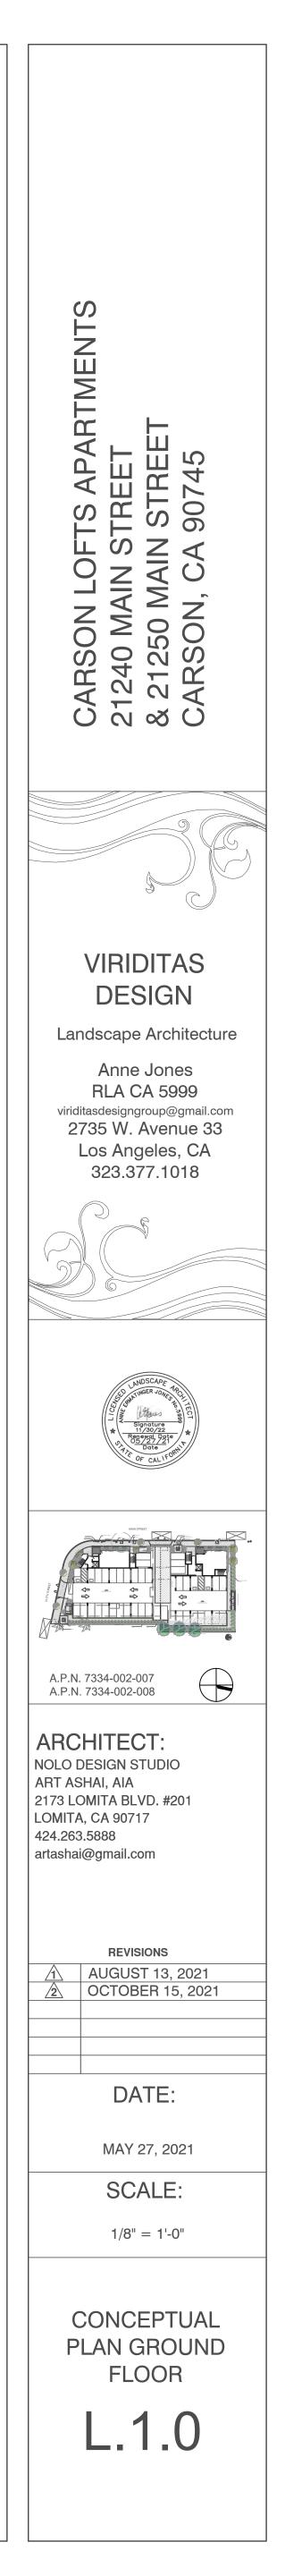


PLANT LEGEND


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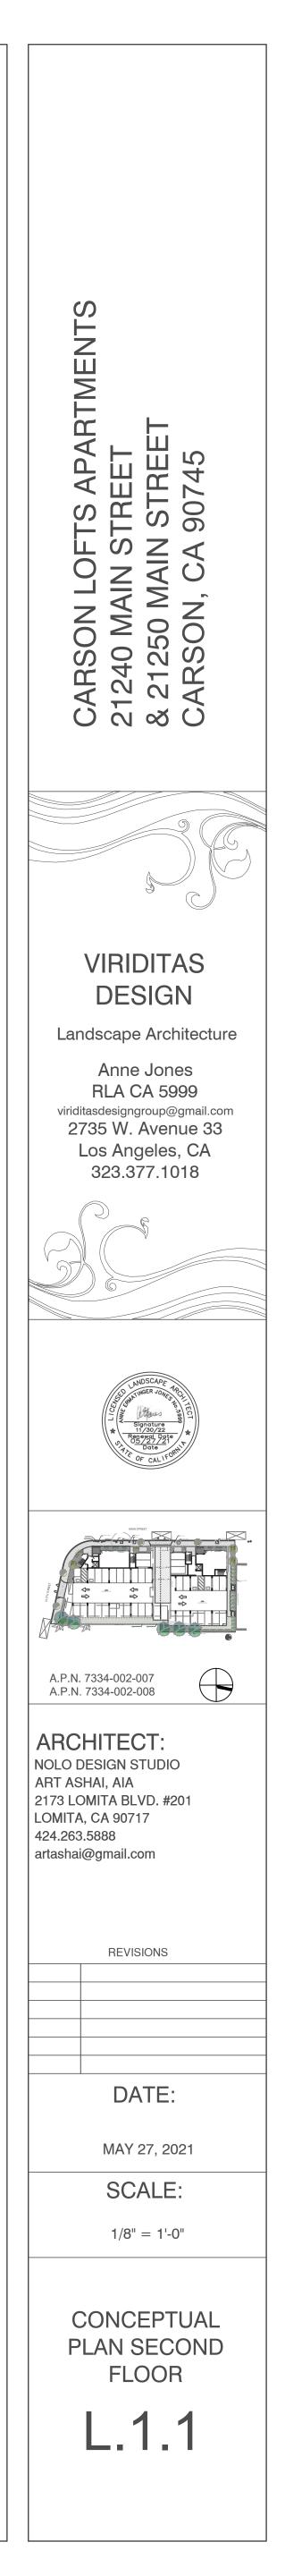
BOTANICAL NAME	COMMON NAME	<u>SIZE AT 5 YRS.</u>	PLANT TYPE	WUCOLS RATING
ECHEVERIA 'VIOLET QUEEN'	VIOLET QUEEN 'HENS AND CHICKS'	6" X 6"	SUCCULENT	0.3/L
ECHEVERIA 'ZORRO'	ZORRO ECHEVERIA	18" X 1'	SUCCULENT	0.3/L
HARDENBERGIA VIOLACEA	PURPLE VINE LILAC	6' X 3'	VINE	0.3/L
KALANCHOE 'OAK LEAF'	DWARF VELVET PLANT	2' X 2'	SUCCULENT	0.3/L
PORTULACARIA AFRA MINIMA	ELEPHANT'S FOOD	>1' X 3'	SUCCULENT	0.3/L
RUSELLIA EQUISETIFORMIS	CORAL FOUNTAIN	3' X 3'	PERENNIAL	0.3/L
TRADESCANTIA 'GREENLEE'	PALE PUMA SPIDERWORT	<1' X 4'	SUCCULENT	0.3/L
XEROSICYOS DANGUYI	SILVER DOLLAR VINE	<1' X 4'	SUCCULENT	0.3/L

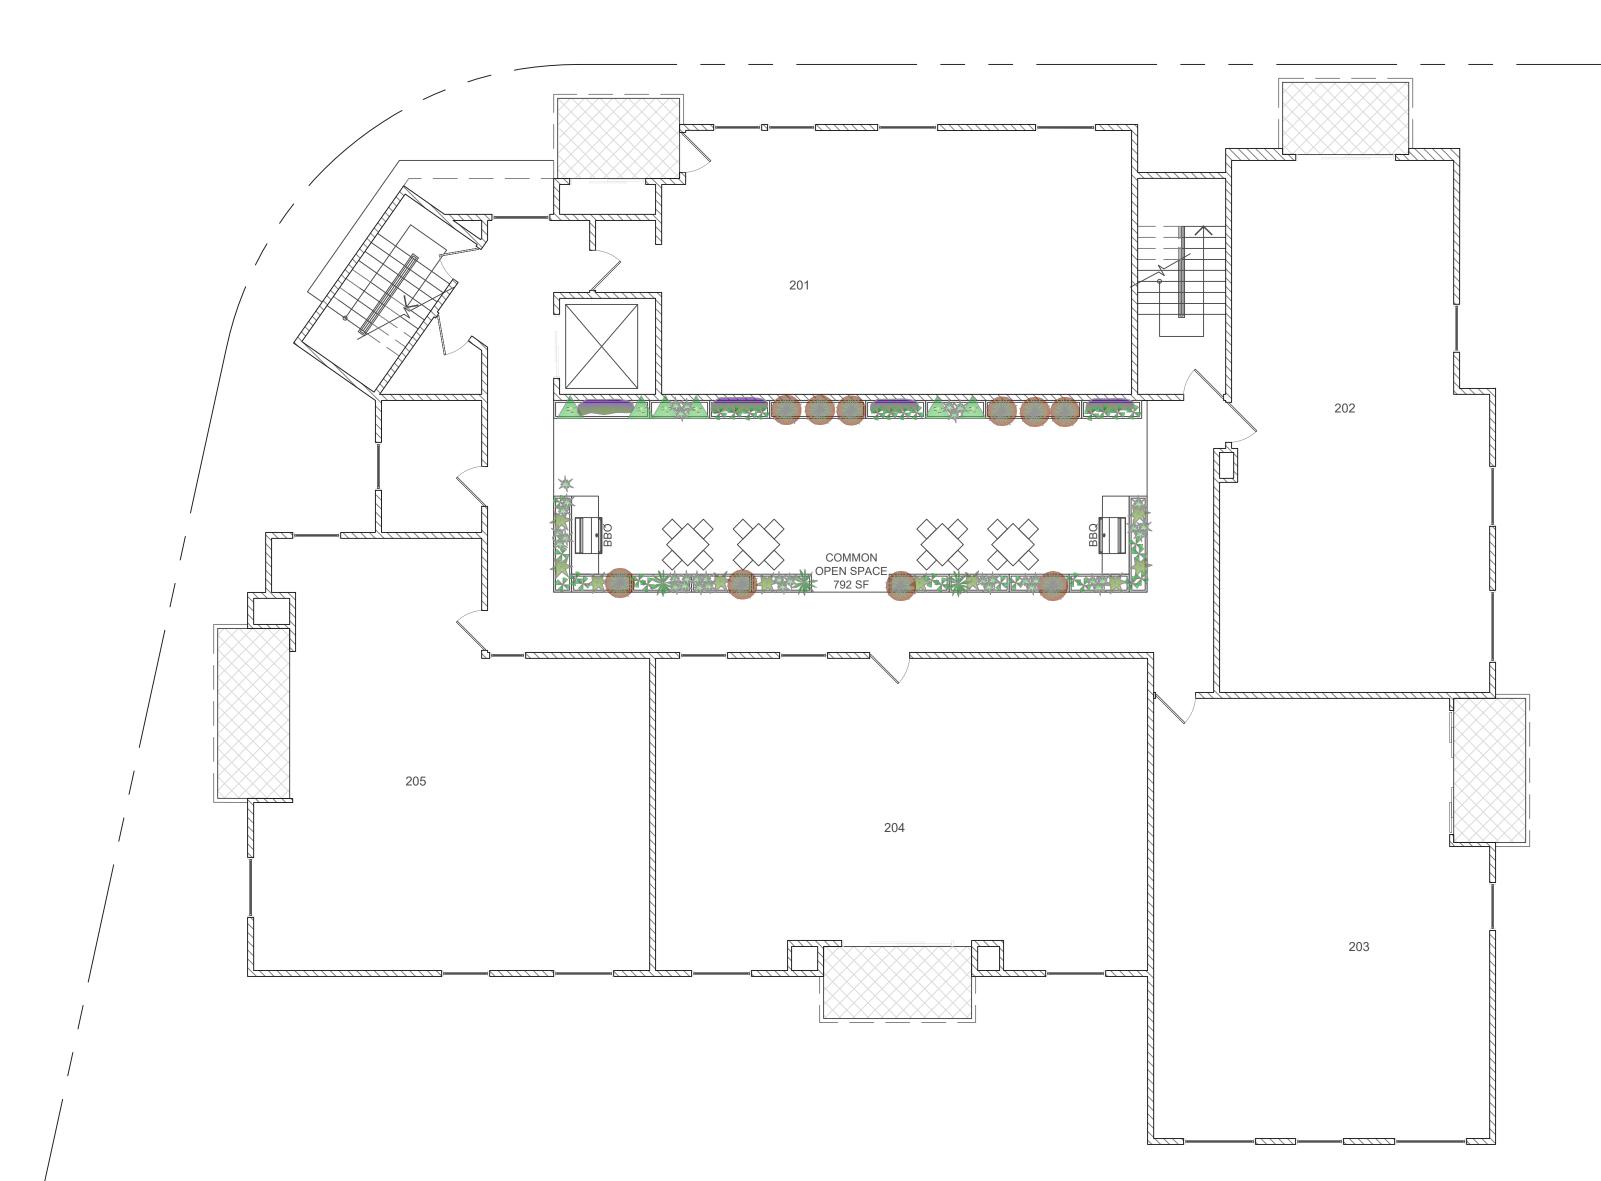

CONCEPTUAL LANDSCAPE PLAN -SECOND FLOOR SCALE: 1/8" = 1'-0"



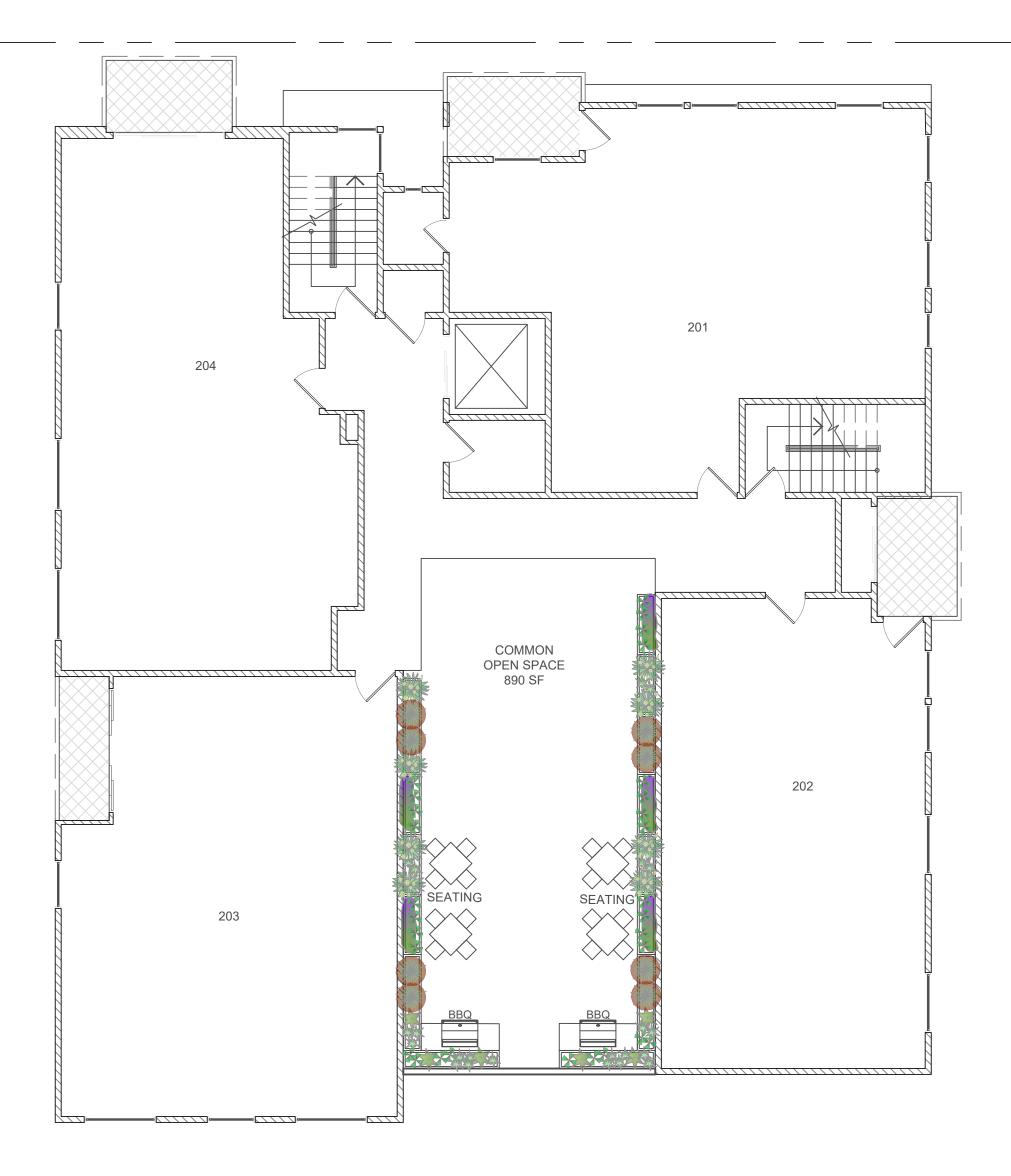

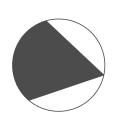





ACHILLEA MILLEFOLIUM COMMON YARROW

AGAVE ATTENUATA FOXTAIL AGAVE



ECHEVERIA 'ZORO' ZORO ECHEVERIA



GREVILLEA LANIGERA 'COASTAL GEM' COASTAL GEM



LAURIS NOBILIS (SHRUB) SWEET BAY



LOMANDRA LOMGIFOLLIA 'NYALLA' NYALLA MAT RUSH



RUSELLIA EQUISETIFORMIS CORAL FOUNTAIN



XEROSICYOS DANGUYI SILVER DOLLAR VINE



TRADESCANTIA 'GREENLEE' PALE PUMA SPIDERWORT



ARBUTUS UNEDO STD. STRAWBERRY TREE

ALOE STRIATA CORAL ALOE

CAREX TUMULICOLA (C. DIVULSA) BERKELEY SEDGE



HARDENBERGIA VIOLACEA PURPLE VINE LILAC



KALANCHOE 'OAK LEAF' DWARF ELEPHANT PLANT





WESTRINGIA 'BLUE GEM' BLUE GEM COAST ROSEMARY

WESTRINGIA FRUTICOSA 'GREY BOX' DWARF COAST ROSEMARY

GEIJERA PARVIFLORA AUSTRALIAN WILLOW

ECHEVERIA 'VIOLET QUEEN' VIOLET QUEEN 'HENS AND CHICKS'





LANTANA GOLDEN YELLOW



RAPHIOLEPIS 'INDICA' INDIA HAWTHORN

WESTRINGIA FRUTICOSA 'MUNDI' LOW COAST ROSEMARY

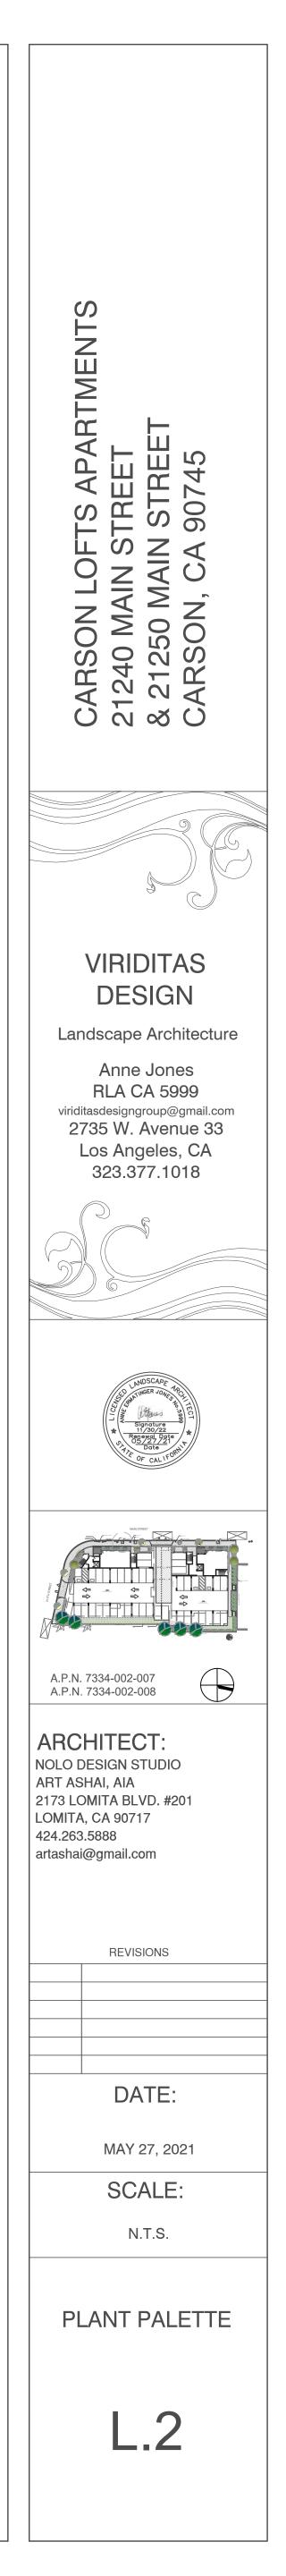


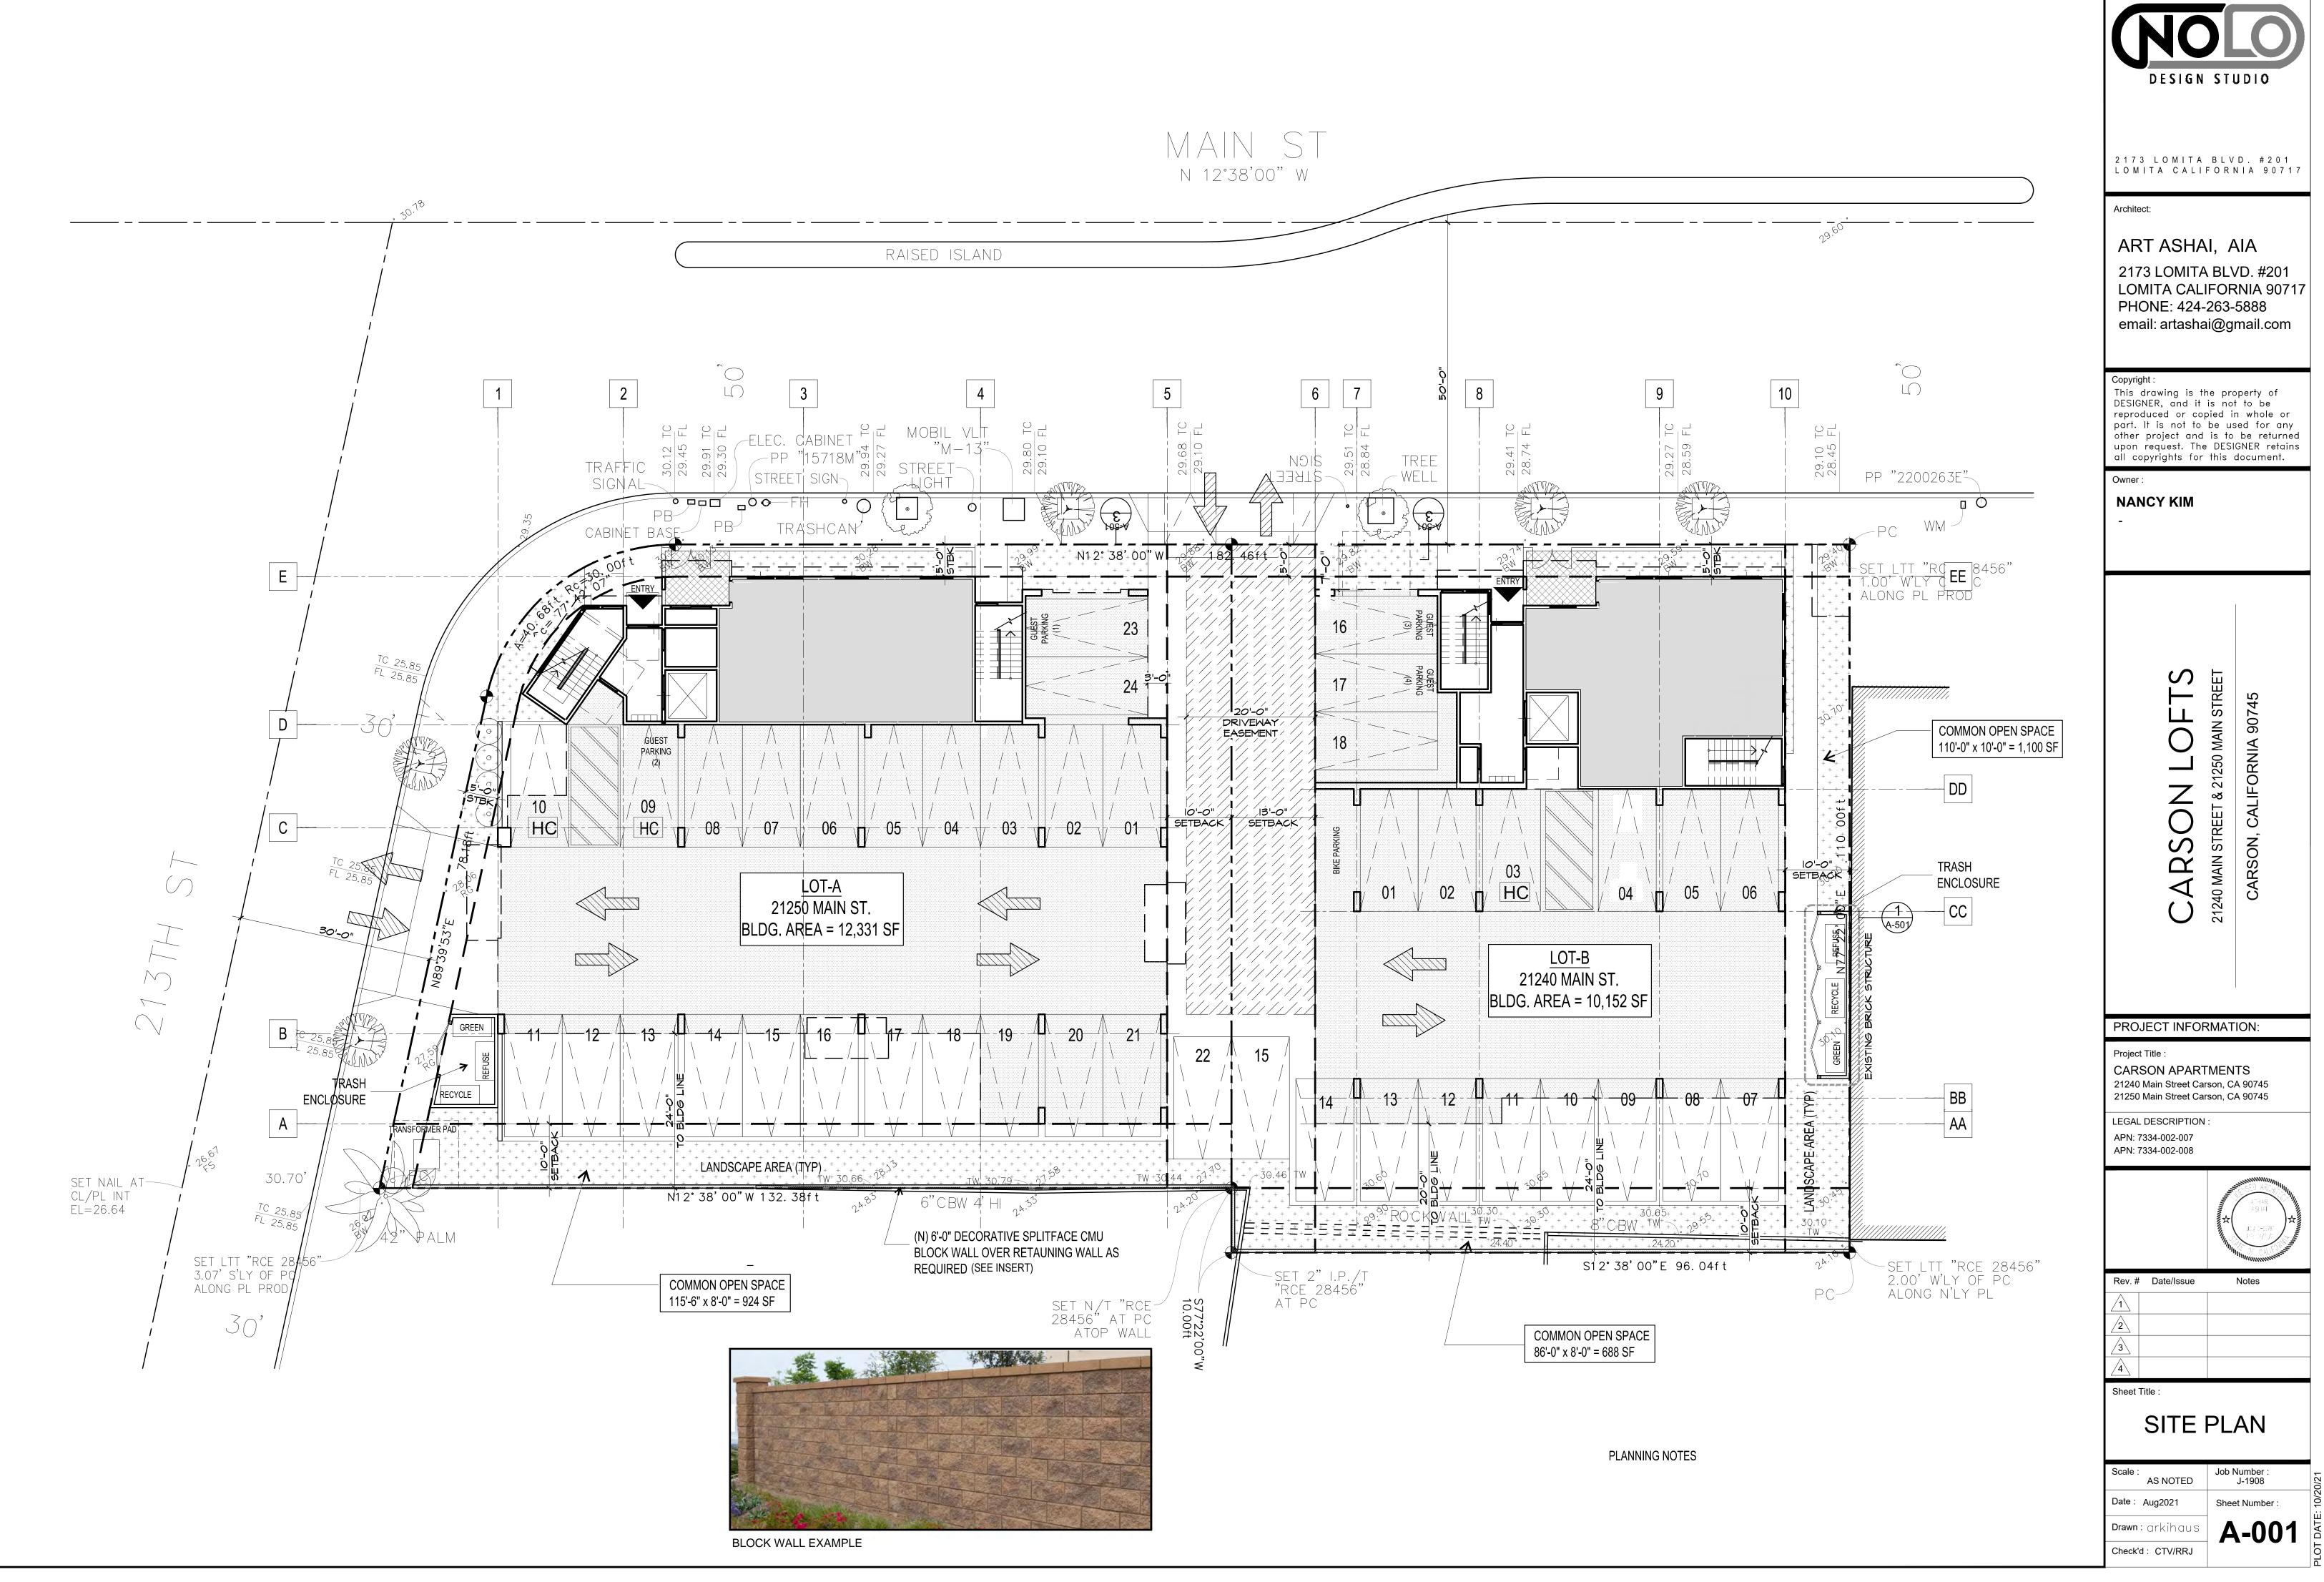


21250 N	IAIN STREET	(LOT A) — OPE	EN SPACE	21240 MAIN STREET (LOT B) - OPEN SPACE				
	APN - 73	34-02-07	APN - 7334-002-008					
UNIT	WIDTH	DEPTH	AREA	UNIT	WIDTH	DEPTH	AREA	
101	10'-0"	9'-0"	90 S.F.	101	10'-10"	9'-0"	98 S.F	
201	10'-6"	7'-0"	74 S.F.	201	11'-6"	7'-0″	81 S.F	
202	11'-2″	6'-4"	71 S.F.	202	10'-6″	7'-0″	74 S.F	
203	12'-0"	6'-4"	76 S.F.	203	12'-0"	4'-6"	54 S.F	
204	12'-4″	6'-4"	78 S.F.	204	11'-2″	6′-4″	71 S.F	
205	14'-10"	6'-4"	94 S.F.	301	11′-6″	7'-0″	81 S.F	
301	10'-10"	7'-0"	76 S.F.	302	9'-10″	7'-0″	69 S.F	
302	11'-2″	6'-4"	71 S.F.	303	12'-0"	4'-6"	54 S.F	
303	12'-0"	6'-4"	76 S.F.	303	11'-2″	6'-4"	71 S.F	
304	12'-4"	6'-4"	78 S.F.	TOTAL PRIV	TOTAL PRIVATE OPEN SPACE		653 s.f	
305	14'-2"	6'-4"	90 S.F.	USEABLE	42'-6″	21'-0"	893 S.F	
TOTAL PRIV	ATE OPEN SP	ACE	874 S.F.	COMMON			1,788 S	
USEABLE	49'-6"	16'-0"	792 S.F.					
COMMON			924 S.F.					
		TOTAL	2,590 S.F.			TOTAL	3,334 S.	
		TREET – LOT			1240 MAIN S			
		OPEN SPACE		SUMMARY OF OPEN SPACES				
FLOOR		ACE	AREA	FLOOR SPACE			AREA	
1 st		/ATE	90 S.F.	1 ST		/ATE	98 S.F.	
	COM	MON	924 S.F.				1,788 S.F.	
				115	TOTAL 1ST		2,900 S.F.	
2 ND		/ATE	393 S.F.	2 ND		/ATE	280 S.F.	
USEABLE		ABLE	792 S.F.			ABLE	893 S.F.	
					TOTAL 2ND		2,358 S.F.	
3 RD	PRI	/ATE	391 S.F.	3 RD		/ATE	275 S.F.	
					TOTAL 3RD	FLOOR:	666 S.F.	
TOTAL OPEN SPACE PROVIDED:								






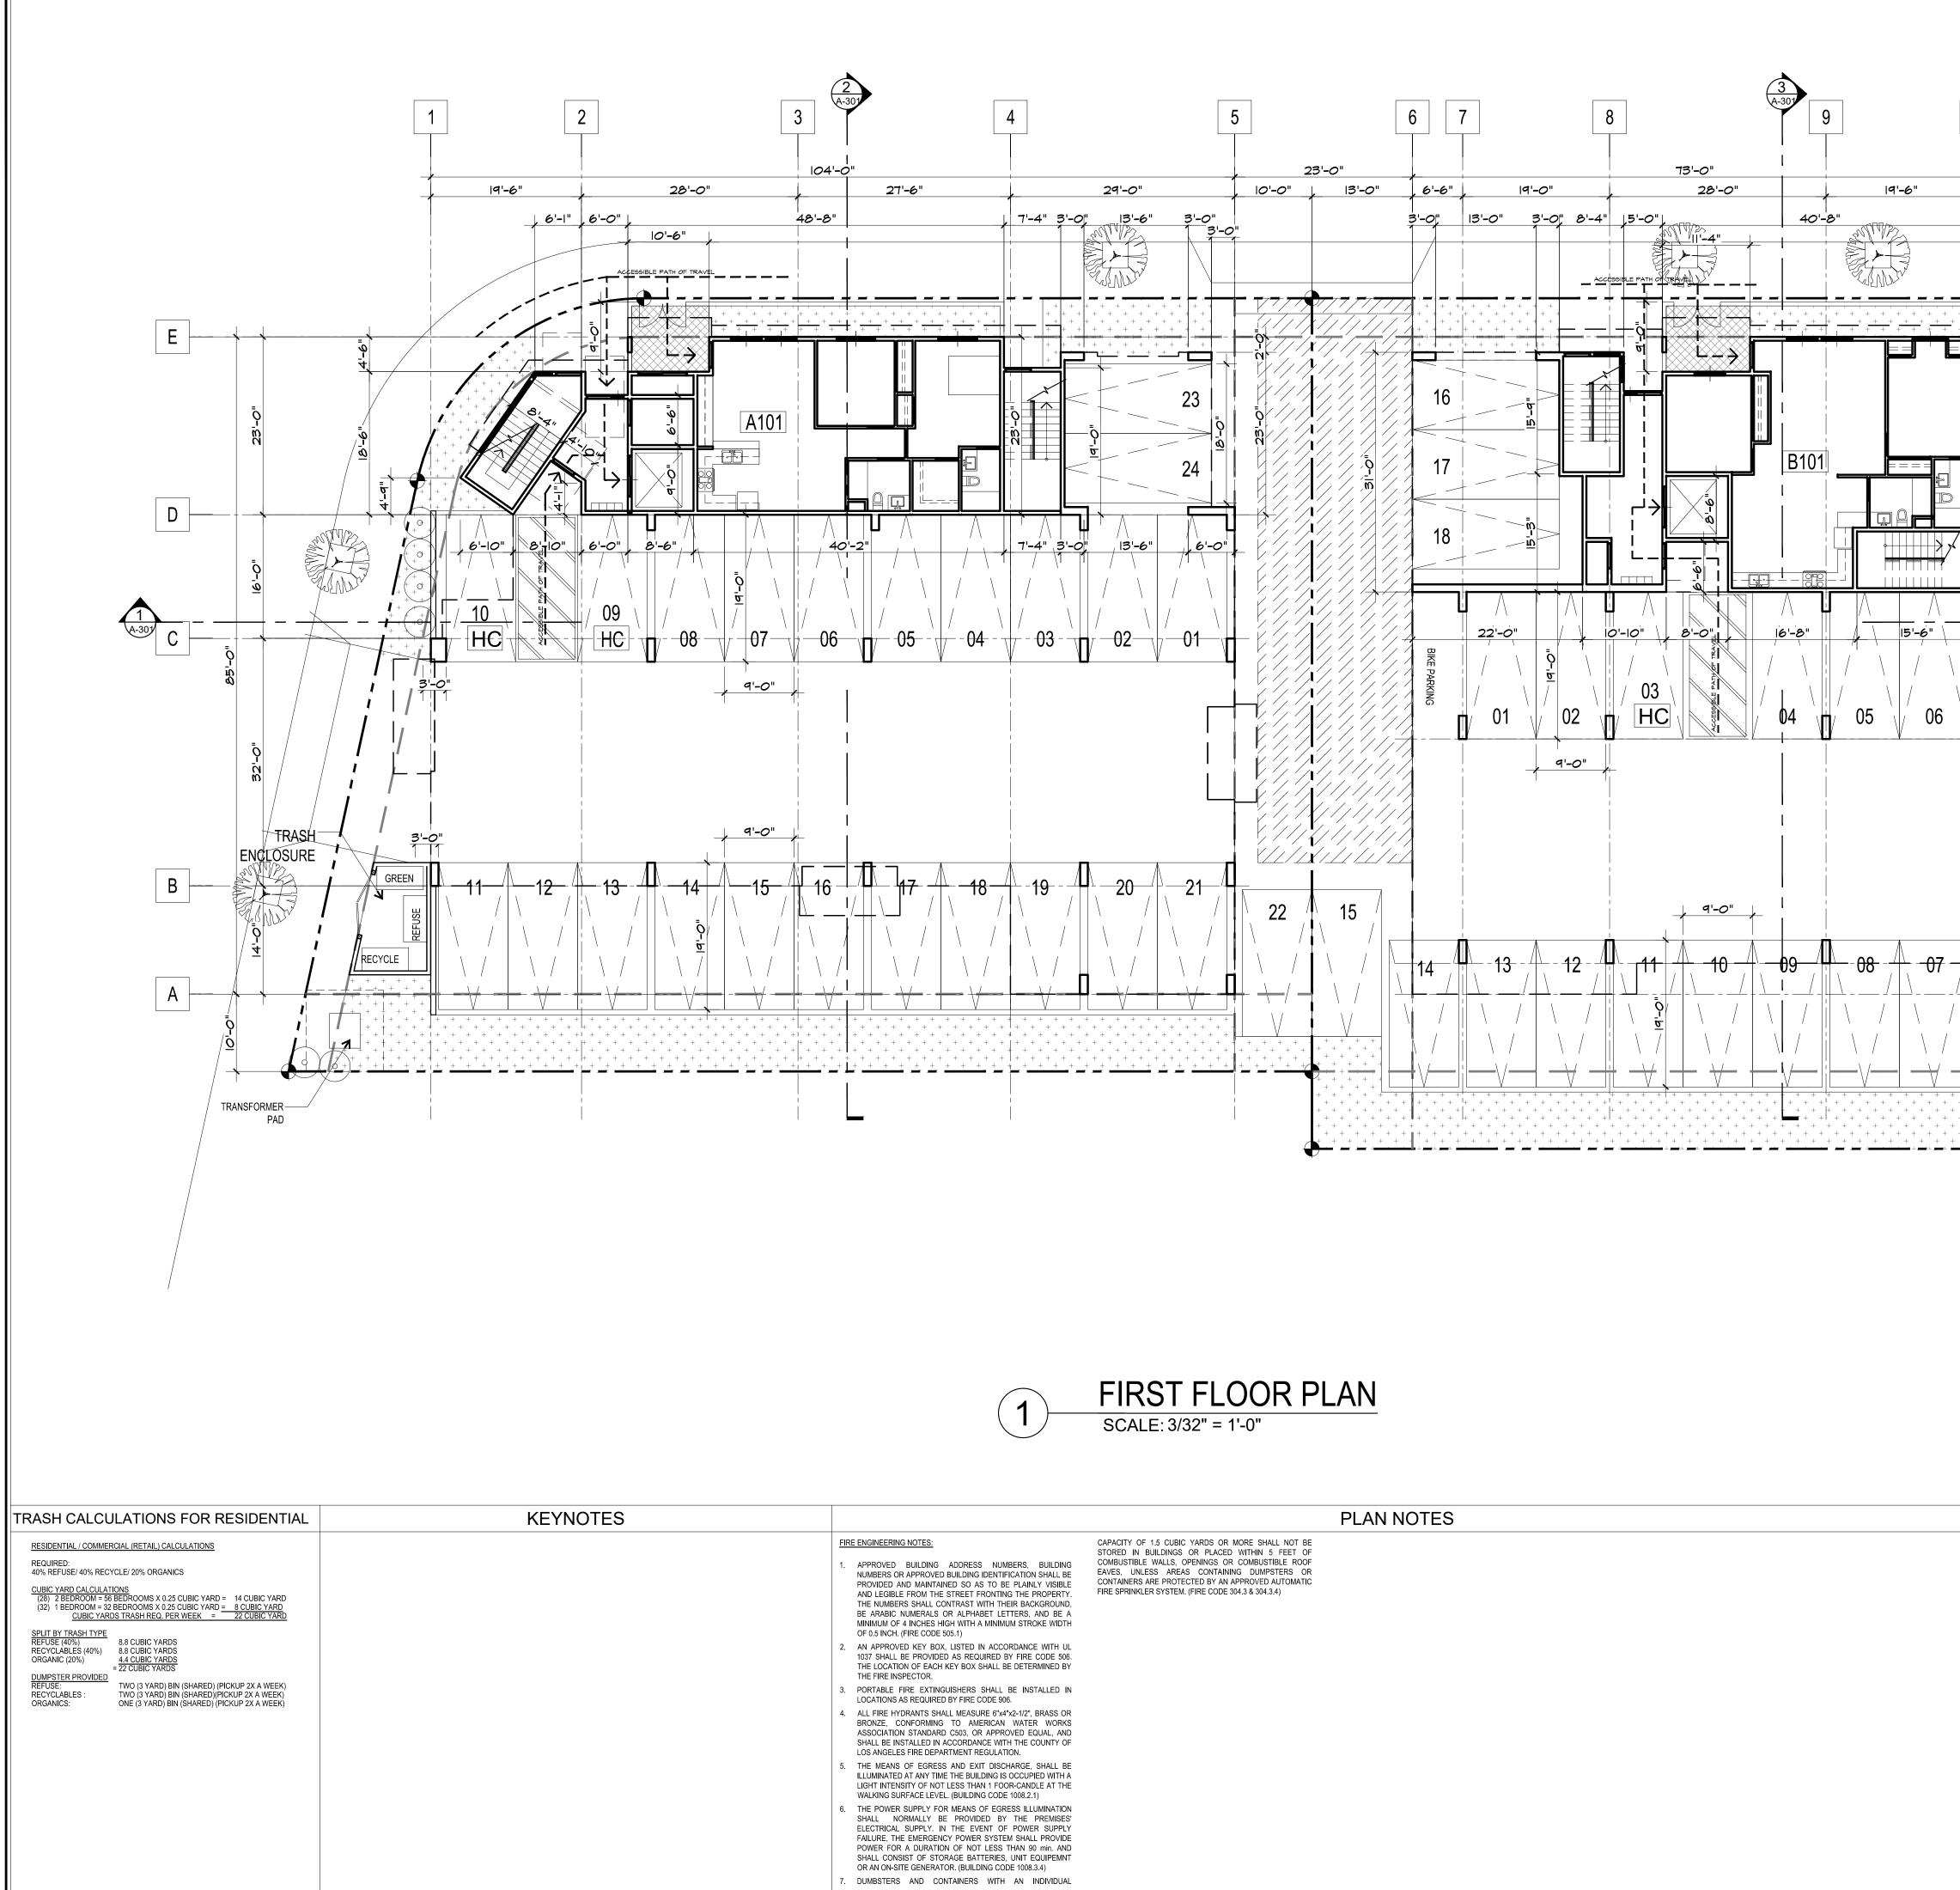


10 BIKE PARKING		DESIGN STUDIO 2173 LOMITA BLVD. #201 LOMITA CALIFORNIA 90717 Architect:
EE		ART ASHAI, AIA 2173 LOMITA BLVD. #201 LOMITA CALIFORNIA 90717 PHONE: 424-263-5888 email: artashai@gmail.com
b c c c c c c c c		DESIGNER, and it is not to be reproduced or copied in whole or part. It is not to be used for any other project and is to be returned upon request. The DESIGNER retains all copyrights for this document. Owner: NANCY KIM -
Image: Comparison of the second se		CARSON LOFTS 21240 MAIN STREET & 21250 MAIN STREET CARSON, CALIFORNIA 90745
		PROJECT INFORMATION: Project Title : CARSON APARTMENTS 21240 Main Street Carson, CA 90745 21250 Main Street Carson, CA 90745
		LEGAL DESCRIPTION : APN: 7334-002-007 APN: 7334-002-008
	WALL TYPES PE OF CONSTRUCTION i & V-A CUPANCY TYPE A ₂ /R ₂ /S ₂ INE STYLE DESCRIPTION DETAIL 10" - 12" THICK CONCRETE WALL	Rev. # Date/Issue Notes 1
		Scale : Job Number : AS NOTED Job Number : Date : Aug2021 Drawn : arkihaus Check'd : CTV/RRJ

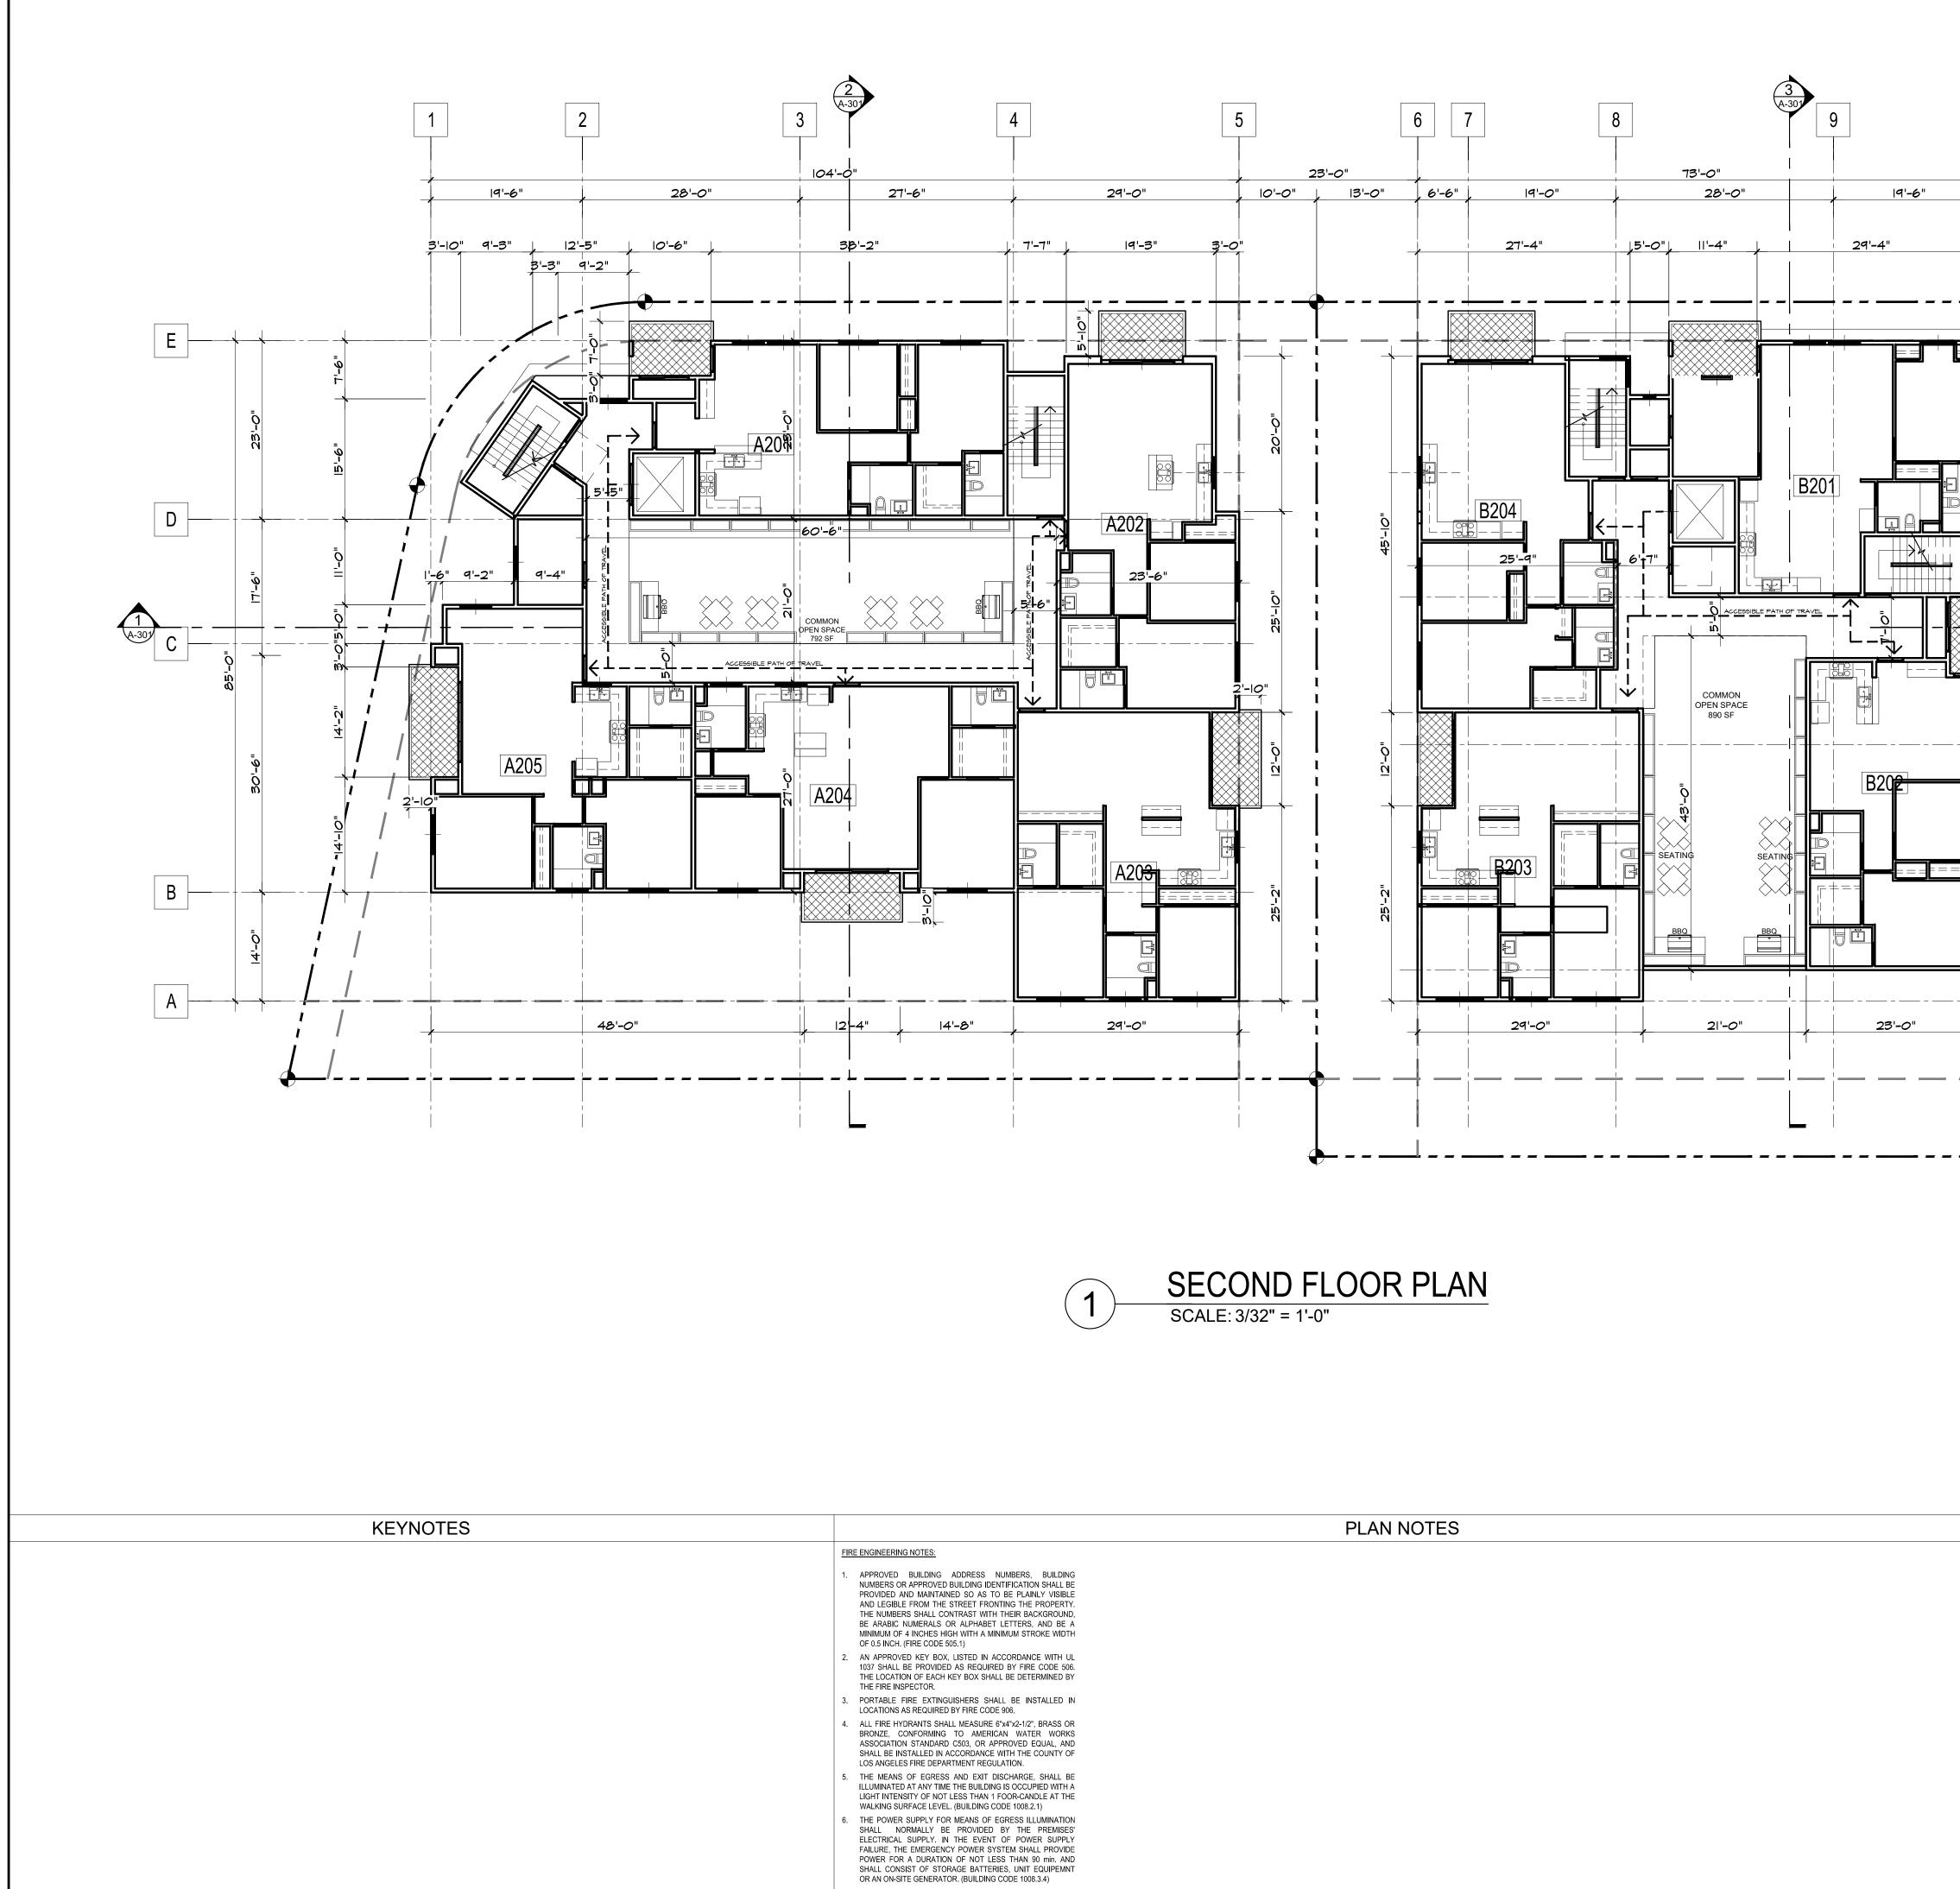


DESIGN STUDIO
2173 LOMITA BLVD. #201 LOMITA CALIFORNIA 90717 Architect: ART ASHAI, AIA 2173 LOMITA BLVD. #201 LOMITA CALIFORNIA 90717 PHONE: 424-263-5888 email: artashai@gmail.com
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DN LOFTS EET & 21250 MAIN STREET CALIFORNIA 90745
CARSON, C.
Project Title : CARSON APARTMENTS 21240 Main Street Carson, CA 90745 21250 Main Street Carson, CA 90745 LEGAL DESCRIPTION : APN: 7334-002-007 APN: 7334-002-008 VALL TYPES
VALL TYPES "Information of the second s
СТІС

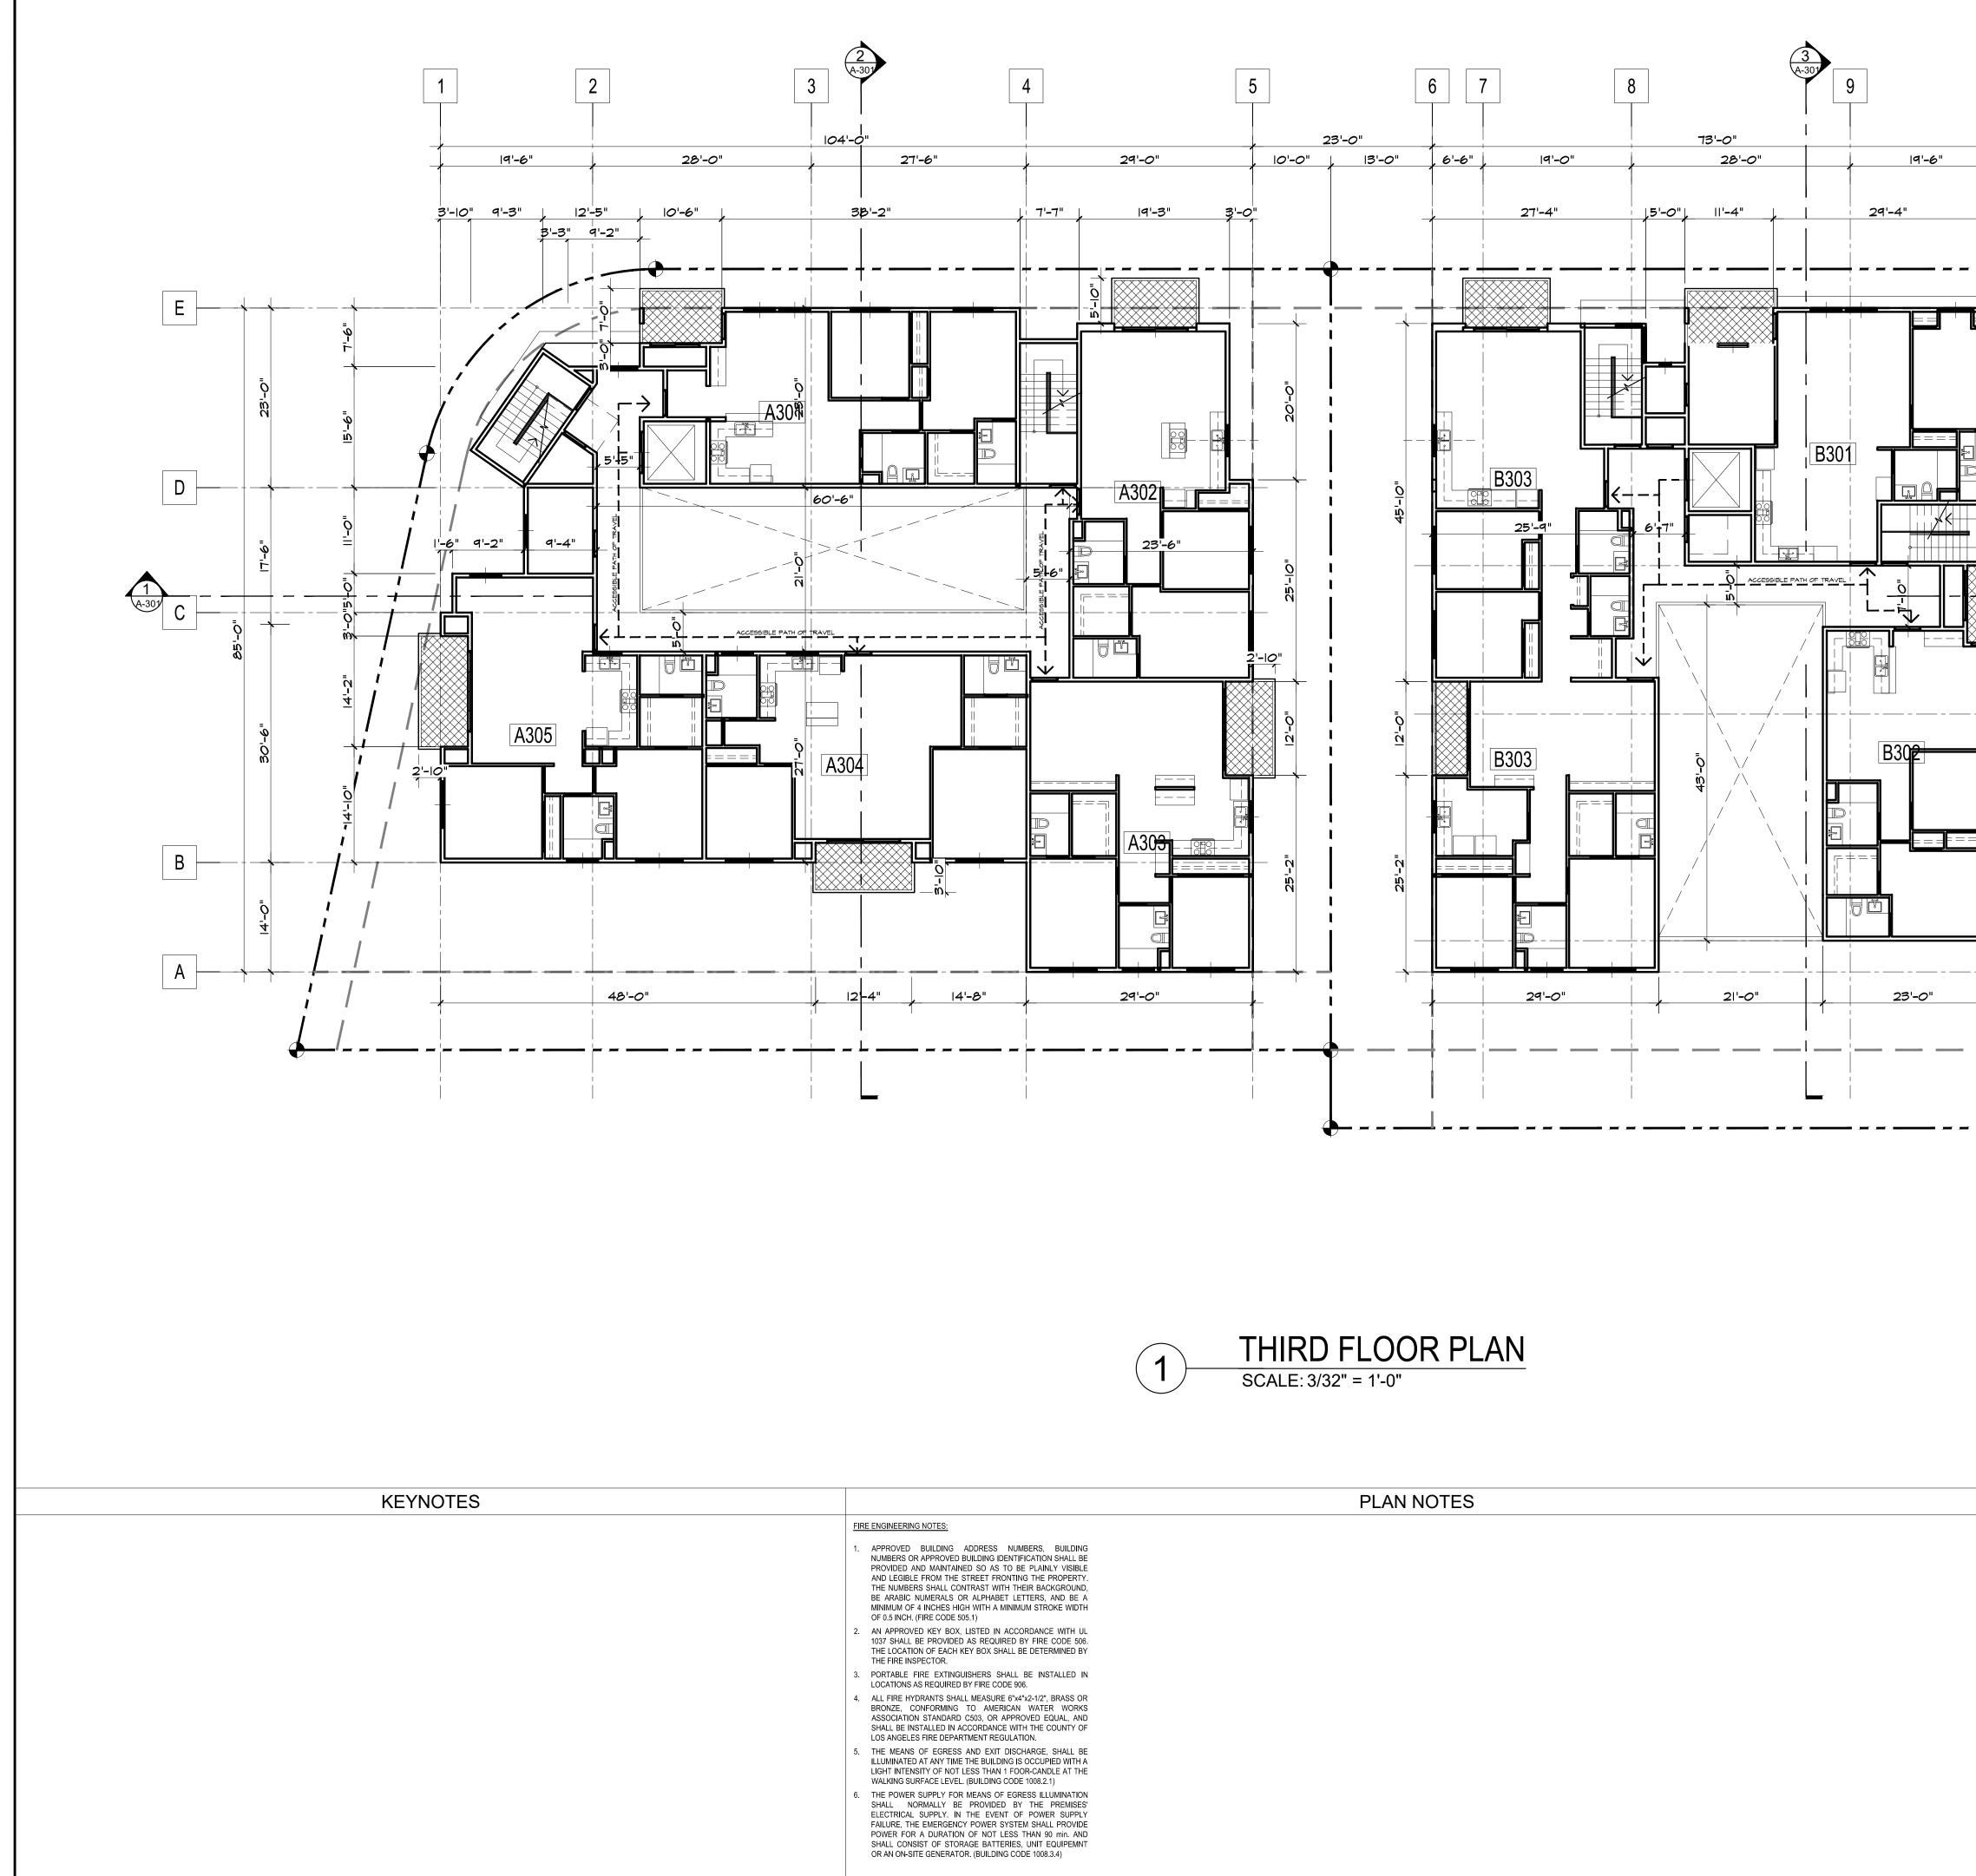

10	DESIGN STUDIO
	2173 LOMITA BLVD. #201 LOMITA CALIFORNIA 90717
	Architect: ART ASHAI, AIA 2173 LOMITA BLVD. #201 LOMITA CALIFORNIA 90717 PHONE: 424-263-5888 email: artashai@gmail.com
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	NANCY KIM -
	SON LOFTS STREET & 21250 MAIN STREET N, CALIFORNIA 90745
	CARSON LOFTS 21240 MAIN STREET & 21250 MAIN STREET CARSON, CALIFORNIA 90745
	PROJECT INFORMATION:
	Project Title : CARSON APARTMENTS 21240 Main Street Carson, CA 90745 21250 Main Street Carson, CA 90745 LEGAL DESCRIPTION : APN: 7334-002-007 APN: 7334-002-008
WALL TYPES TYPE OF CONSTRUCTION I & V-A	ATHAR ASUAL UC.# 0-0285 PP: CAUSE
TYPE OF CONSTRUCTION T& V-A OCCUPANCY TYPE A2/R2/S2 DESCRIPTION DETAIL TAG LINE STYLE DESCRIPTION DETAIL 10" - 12" THICK CONCRETE WALL -3 HOUR RATED 10" - 12" THICK CONCRETE WALL 1 HOUR RATED 1 HOUR RATED CORRIDOR WALL 2 HOUR RATED SHAFT WALL	Rev. # Date/Issue Notes 1
Image: Solution of the second seco	Sheet Title : THIRD FLOOR PLAN
	Scale : AS NOTEDJob Number : J-19081000000000000000000000000000000000000
	Scale : AS NOTEDJob Number : J-19081000000000000000000000000000000000000

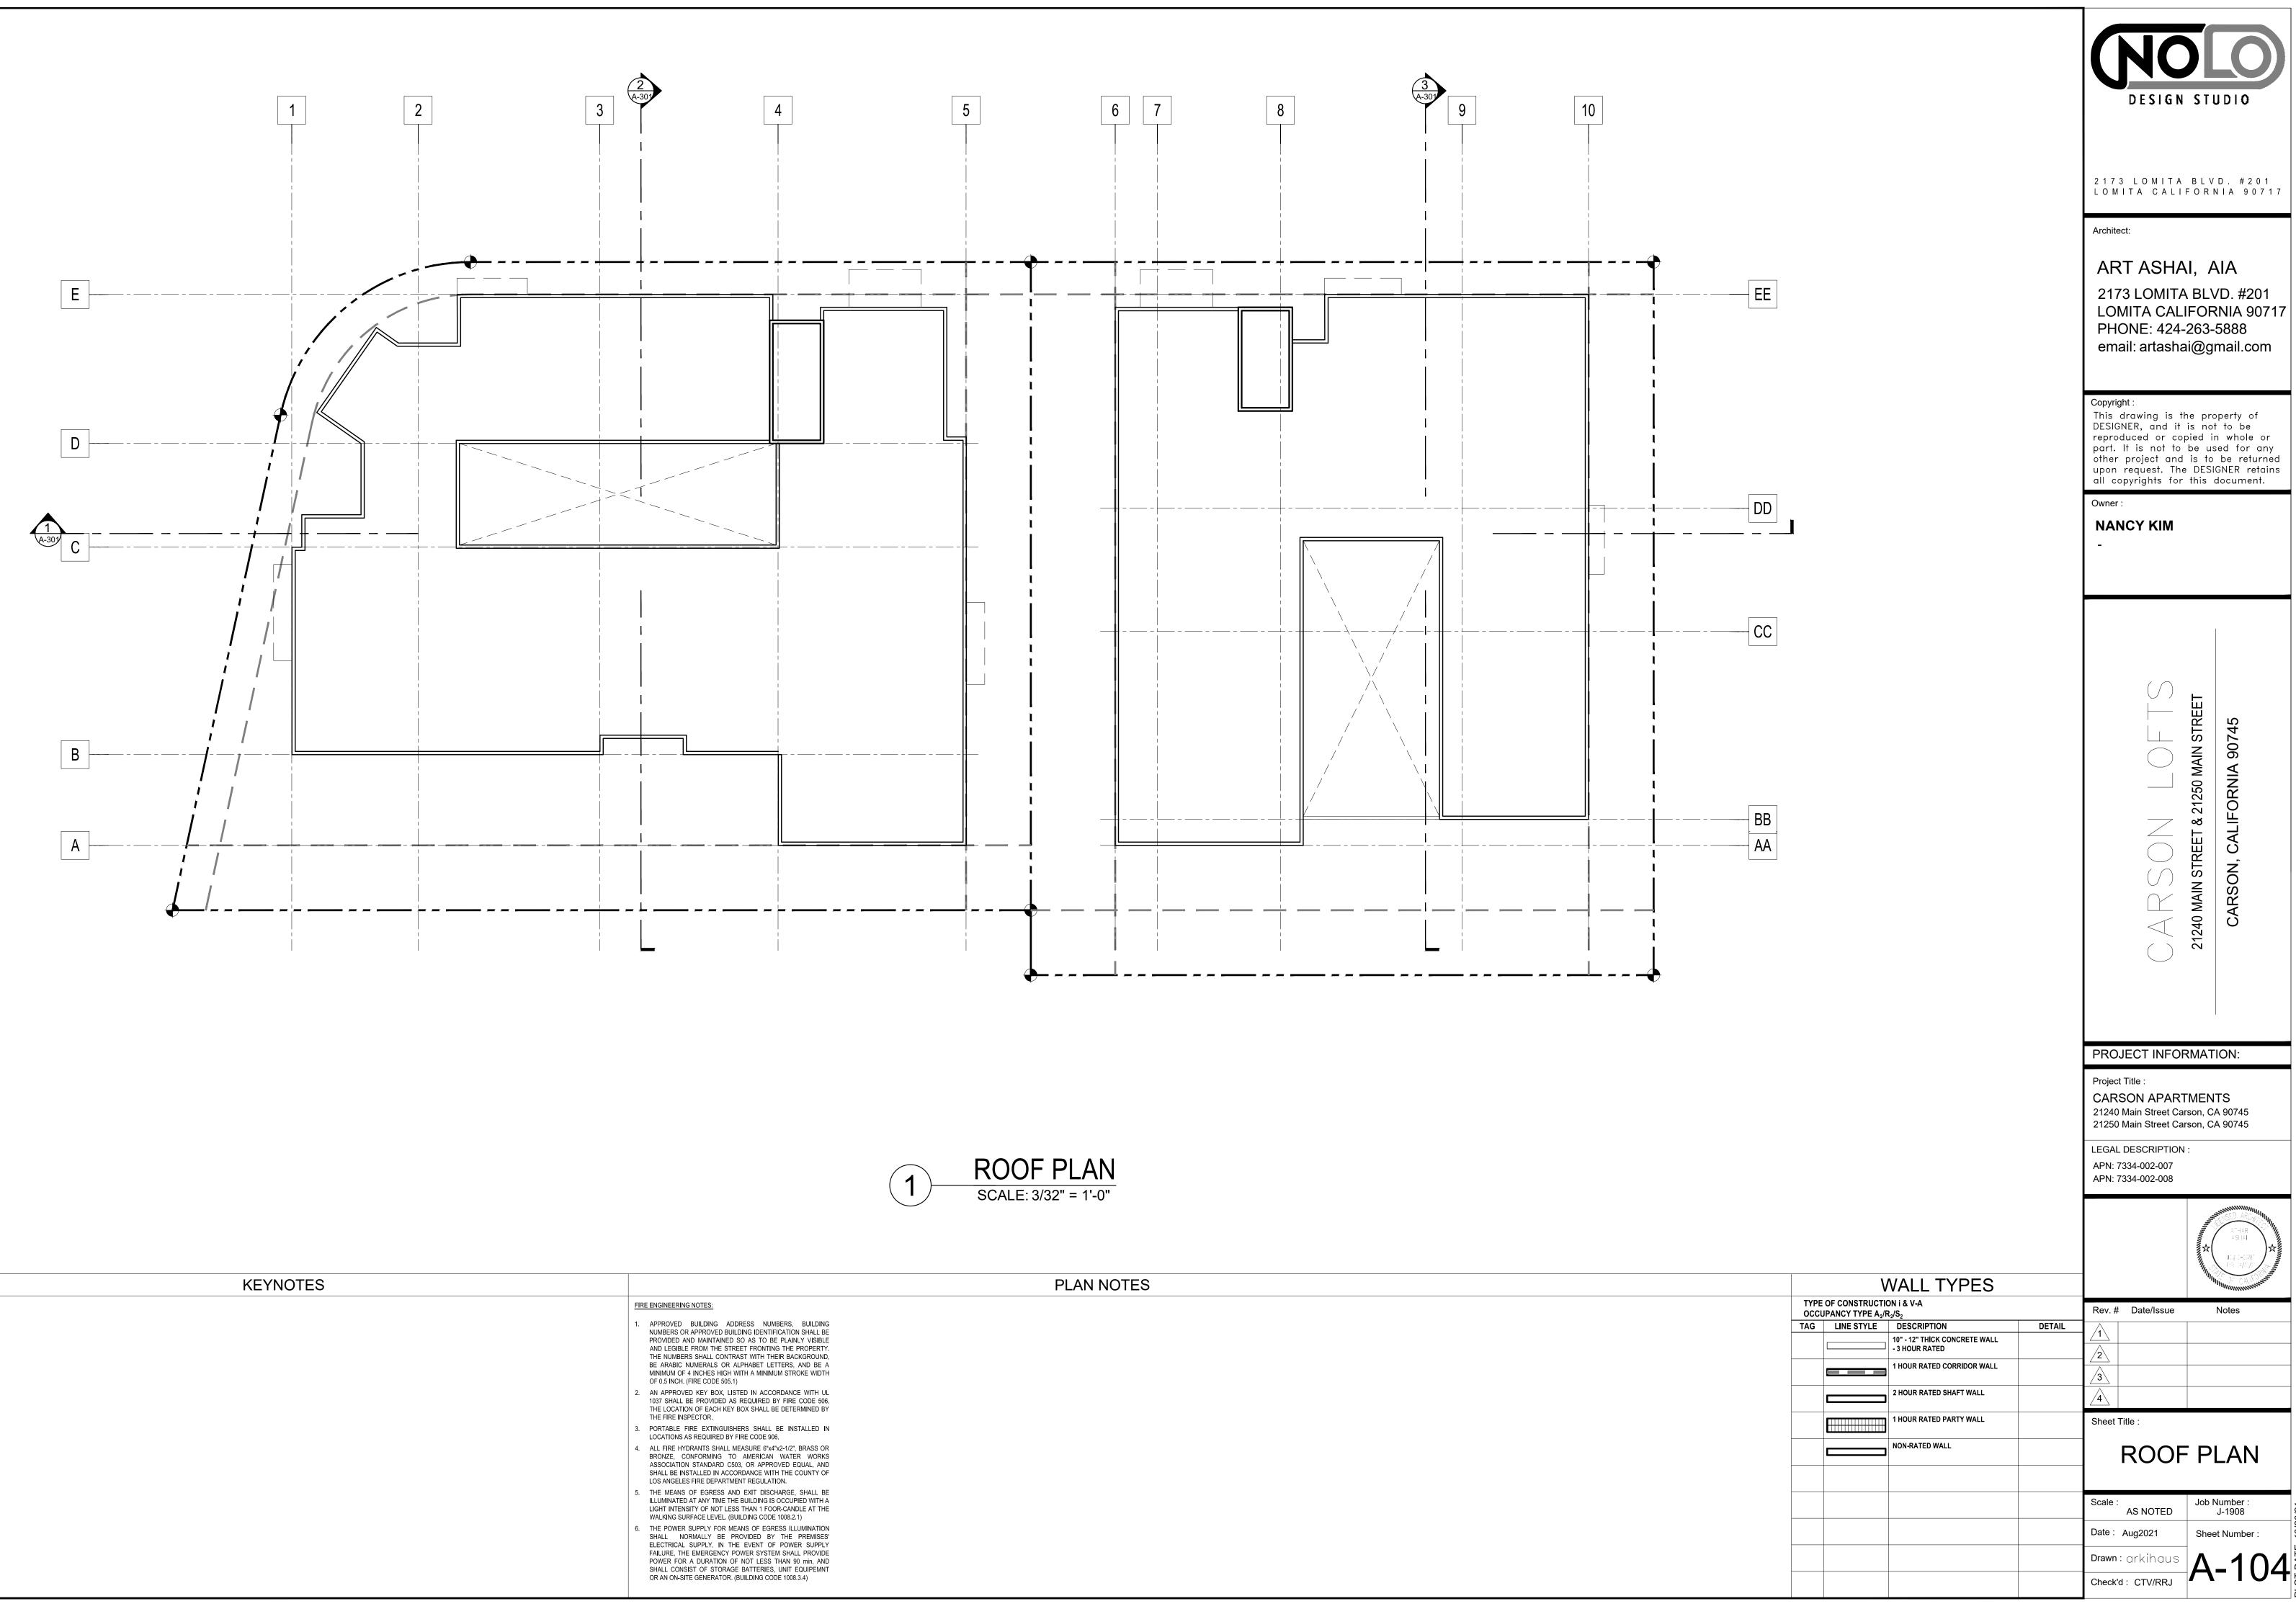




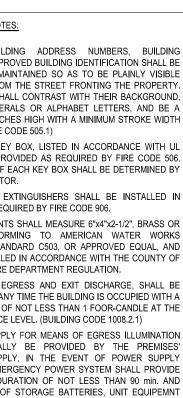




UNIT PLAN 201, 301 - FLOOR PLAN


		2. 3.	COMMON AN PUE ALL TUB/SHOWER	ACCESSIBILITY, REFER TO SHEET A- SLIC AREAS ACCESSIBILITY, REFER TO SHEETS A- AND A- R COMBOS WILL BE UTILIZED FIBERGLASS.	(NC	
		5.	COMPOSITE FLOOUNITS SHALL HAV	MITTED TO BE OF NON-RATED CONSTRUCTION EXCEPTS AS GRAPHICALLY NOTED ON BUILDING OR PLANS. /E AT LEAST A MINIMUM LEAKAGE OF 0.30 CFM50 PER SQUARE FOOT OF ENCLOSURE. UNIT MODEL SEE PLUMBING SCHEDULE.		
		7.	RECESSED LIGHT	TING SHALL BE "BOXED IN" AT FIRE RATED FLOOR/CLG CONDITIONS E MEASURED FROM FACE OF STUD (FOS) UNLESS NOTED OTHERWISE.	DESIGN	STUDIO
		U	NIT PLA	AN LEGEND		
			ELEMENT	DESCRIPTION		
			TYPE A	5/8" GYPSUM BOAR - TAPE, TEXTURE AND PAINT - SATIN LEVEL FIN	2173 LOMITA	
· · · ·]			TYPE B	5/8" GYPSUM BOAR - TAPE, TEXTURE AND PAINT - SEMI GLOSS LEVEL 4 FIN	LOMITA CALIF	[:] ORNIA 90717
+ +			TYPE C	EXTERIOR SOFFIT 5/8 " GYP BOARD TYPR X - TAPE, TEXTURE STUCCO FINISH	Architect:	
				LIMIT OF SOFFIT ABOVE - HEIGHT PER FLOOR PLAN. REFER TO DET 14 & 15/A-		
0			<u>1/2</u> " HS <u>C</u>	FLOOR LEVEL AT DOORS SHALL NOT BE MORE THAN $\frac{1}{2}$ INCH LOWER THAN THRESHOLD AT THE DOORWAY PER C.B.C. SECTION 1008.1.6 AND 1132A. 4.1	ART ASHA	
			Â	FLOOR MATERIAL FLUSH TRANSITION	2173 LOMITA	BLVD. #201 FORNIA 90717
			A	INTERIOR ELEVATION KEY	PHONE: 424-	
			VING ROOM	TROOM NAME FLOOR FINISH CEILING HEIGHT	email: artasha	i@gmail.com
			(00)	DOOR NUMBER - REFER TO DOOR SCHEDULE		
0				WINDOW TYPE - REFER TO WINDOW SCHEDULE	Copyright :	o property of
עַרָּעַ עריים			ο	RECESSED LIGHT FIXTURE (AT AND IC RATED)	This drawing is th DESIGNER, and it reproduced or cop	is not to be
				CEILING FAN	part. It is not to other project and	be used for any is to be returned
			\wedge		upon request. The all copyrights for	
Ø	1			SUPPLY AIR REGISTER	Owner :	
0	l			SUPPLY AIR SIDE WALL REGISTER	NANCY KIM	
	£				-	
			D	EXHAUST AIR REGISTER / FAN - ENERGY STAR COMPLIANT - SEE MECH SMOKE DETECTOR		
			69 60	CARBON MONOXIDE DETECTOR		
			(WA)	WALL TYPE SYMBOL SEE SCHEDULE ON SHEET A AND A-		
			\bigcirc		$(\cap$	
				N KEYNOTES SINK W WITH GARAGE DISPOSAL & HOLE FOR DISHWASHER AIR GAP.		STREET
			PROVIDE ADAPT	ABLE REQUIREMENTS WHERE NOTED/ DULE OF FINISHES.		$\overline{\mathbf{a}}$
		2	ENERGY STAR C	R +/ 24" WIDE DISHWASHER (BOSCH 24" ADA OR APPROVED EQUAL. ERTIFIED). PROVIDE ADAPTABLE REQUIREMENTS. DULE OF FINISHES.		250 MAIN RNIA 90
-	SCALE 3/16" = 1'-0"	02 3	1-HR RATED WAI	SPACE. PROVIDE COLD WATER STUB-OUT IN RECESSED WALL BOX FOR ICE MAKER. PROVIDE LL RECESS WHERE OCCURS IN 1-HR RATED WALL ASSEMBLY. PROVIDE ADAPTABLE		RNI
I		(4)	FREE STANDING	. REFER TO SCHEDULE OF FINISHES. RANGE AND OVER THE RANGE MICROWAVE (BOTH ENERGY STAR CERTIFIED) – VERIFY AND NCES PER MANUFACTURER'S REQUIREMENTS. PROVIDE ADAPTABLE REQUIREMENTS. PROVIDE		& 21 .IFO
			15" BREADBOAR			
		(5) (6)	12" DEEP UPPER			μ μ
		(7)		VASHER AND DRYER – STACKED	$\left(\right)$	40 MAIN ST CARSON
		9	ULTRA-LOW FLU REQUIREMENTS	SH TOILET - REFER TO DETAIL FOR ACCESSIBILITY		CAI CAI
		(10)	32" x 60" TUB/SH PRIOR TO FRAM	OWER - VERIFY UNIT DIMENSIONS WITH MANUFACTURER ING		212
	+		ASSEMBLY	ICINE CABINET. PROVIDE 1- HR RATED WALL RECESS WHERE OCCURS IN 1 -HR RATED WALL		
	<u>→</u>	(12) (13)		AB BAR. PROVIDE SOLID BLOCKING CONCEALED WITHIN WALL CENTERED ON BAR LOCATION AB BAR. PROVIDE SOLID BLOCKING CONCEALED WITHIN WALL CENTERED ON BAR LOCATION		
+ +		(14)		L - REFER TO ELECTRICAL DRAWINGS FOR SOME INFORMATION F. LOCATE POLE 66" ABOVE FINISH FLOOR. PROVIDE 2x6 BLOCKING WITHIN		
		(15)		CH END & CENTER OF POLE FOR POLE HARDWARE. VERIFY SHELF BRACKETS & PROVIDE BLOCKING ACCORDINGLY.	PROJECT INFOR	
		(16) (17)	GRAB BAR	ED HORIZONTAL FAN COIL UNIT. (SEE MECHANICAL PLANS) VERIFY UNIT DIMENSIONS AND	Project Title :	
			CLEARANCE REC	QUIREMENTS PRIOR TO FRAMING AND SETTING DROPPED CEILING HEIGHT. PROVIDE MINIMUM JFACTURE ACCESS PANEL COMPATIBLE WITH F.C.U. PAINT PANEL TO MATCH CEILING.	CARSON APART	
<u>M_</u>	-3		NOT GREATER T	DLD. FLOOR LEVEL CHANGES GREATER THAN $\frac{1}{4}$ " AT DOORWAYS SHALL BE BEVELED OR SLOPED HAN ONE UNIT VERTICAL IN TWO UNITS % SLOPE). REFER TO DETAILS AT ENTRY DOOR AT BALCONY SLIDING DOOR	21240 Main Street Car 21250 Main Street Car	
	<u>4</u>	(19)		AT +48"AFF - SEE ELEC	LEGAL DESCRIPTION	:
		20) (21)	ACCESSIBLE CO UNIT SIGNAGE	MPLIANT LAVATORY	APN: 7334-002-007 APN: 7334-002-008	
		(22) (23)		FER AT HIGH LEVEL INSIDE CEILING SPACE WITH CEILING ACCESS - SEE PLUMBING VATER METER DISPLAY. MOUNT HT. AT 4' - 0". ABOVE FINISH FLOOR TO TOP OF DISPLAY		
	++	(24)	15" MIN. BREADB			ATHAR
		(25)		ANKLESS WATER HEATER. SEE PLUMBING DRAWINGS. ED CLEARANCES WITH MFR PRIOR TO FRAMING		A"HAR ASIIAI UC.g. 0-2078 PPE: 24/25/27
MSTR BATH 5'-0" × 80"	" 0 - 0	(26) (27)	SMOKE DETECT			
		(28)		RAIL - REFER TO EXTERIOR ELEVATIONS.	Rev. # Date/Issue	Notes
	↓	(29) (30)		WALL - REFER TO EXTERIOR ELEVATION FT - CONTRACTOR TO VERIFY WITH MECHANICAL DRAWINGS		
		31		UST LOUVER - SEE MECHANICAL	2	
5'-10"		32	GUTTER		3	
	1	(33) (34)	SCUPPER CEILING BREAK			
		35		FFIT VENT - SEE DETAIL	Sheet Title :	ING A-
		(36)	NOT USED			PLANS
					_	
					Scale : AS NOTED	Job Number : J-1908
					Date : Aug2021	Sheet Number :
					Drawn: arkihaus	A-111
-	SCALE 3/16" = 1'-0"	(01)			Check'd : CTV/RRJ	_

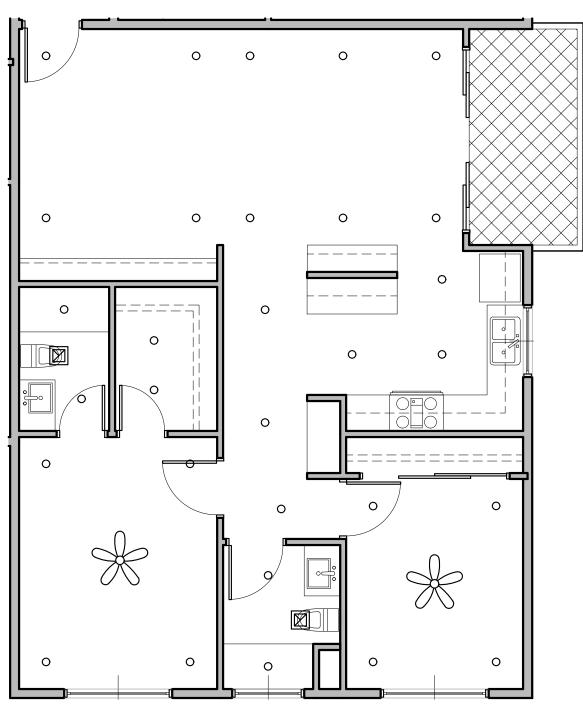


UNIT PLAN 203, 303 - REFLECTED CEILING PLAN




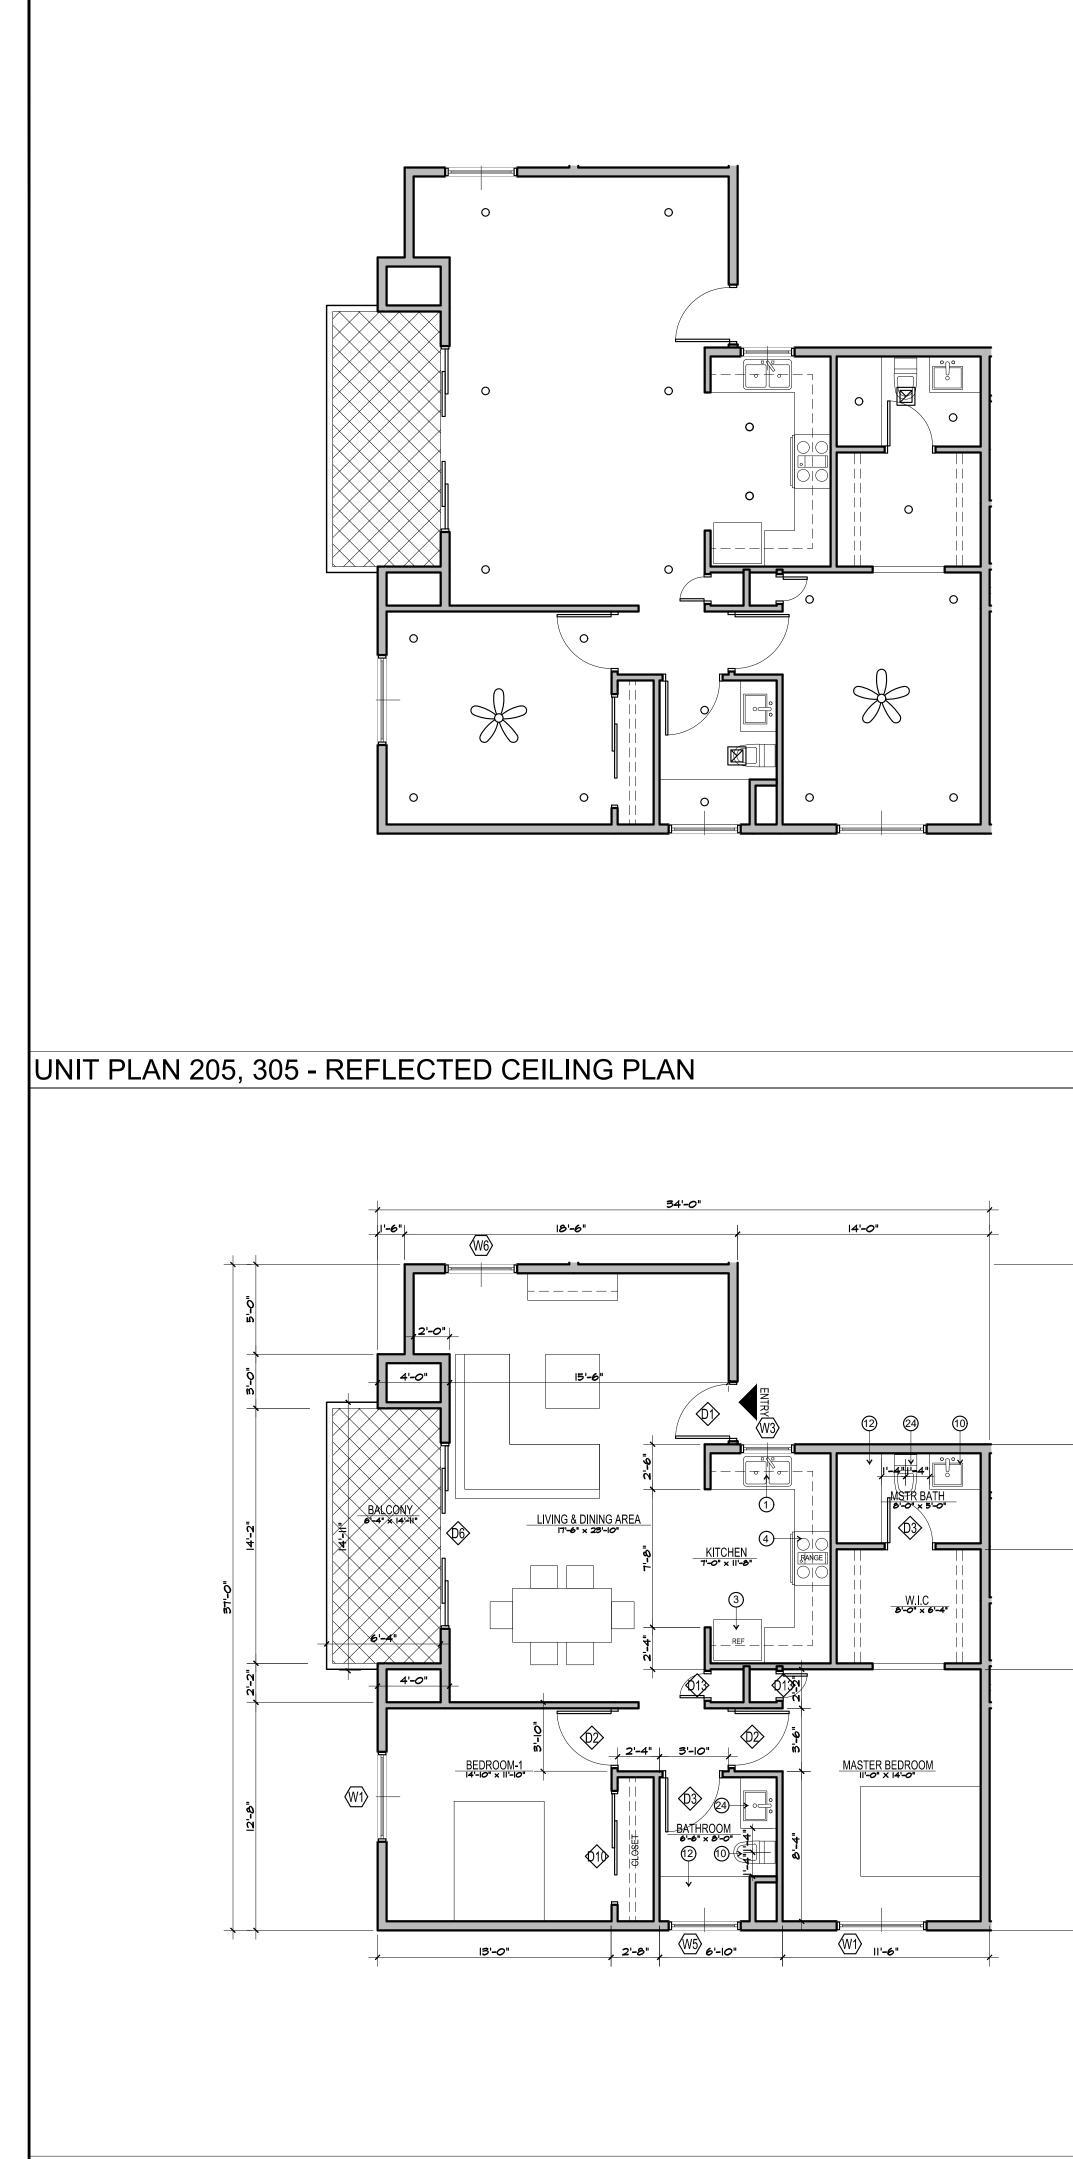

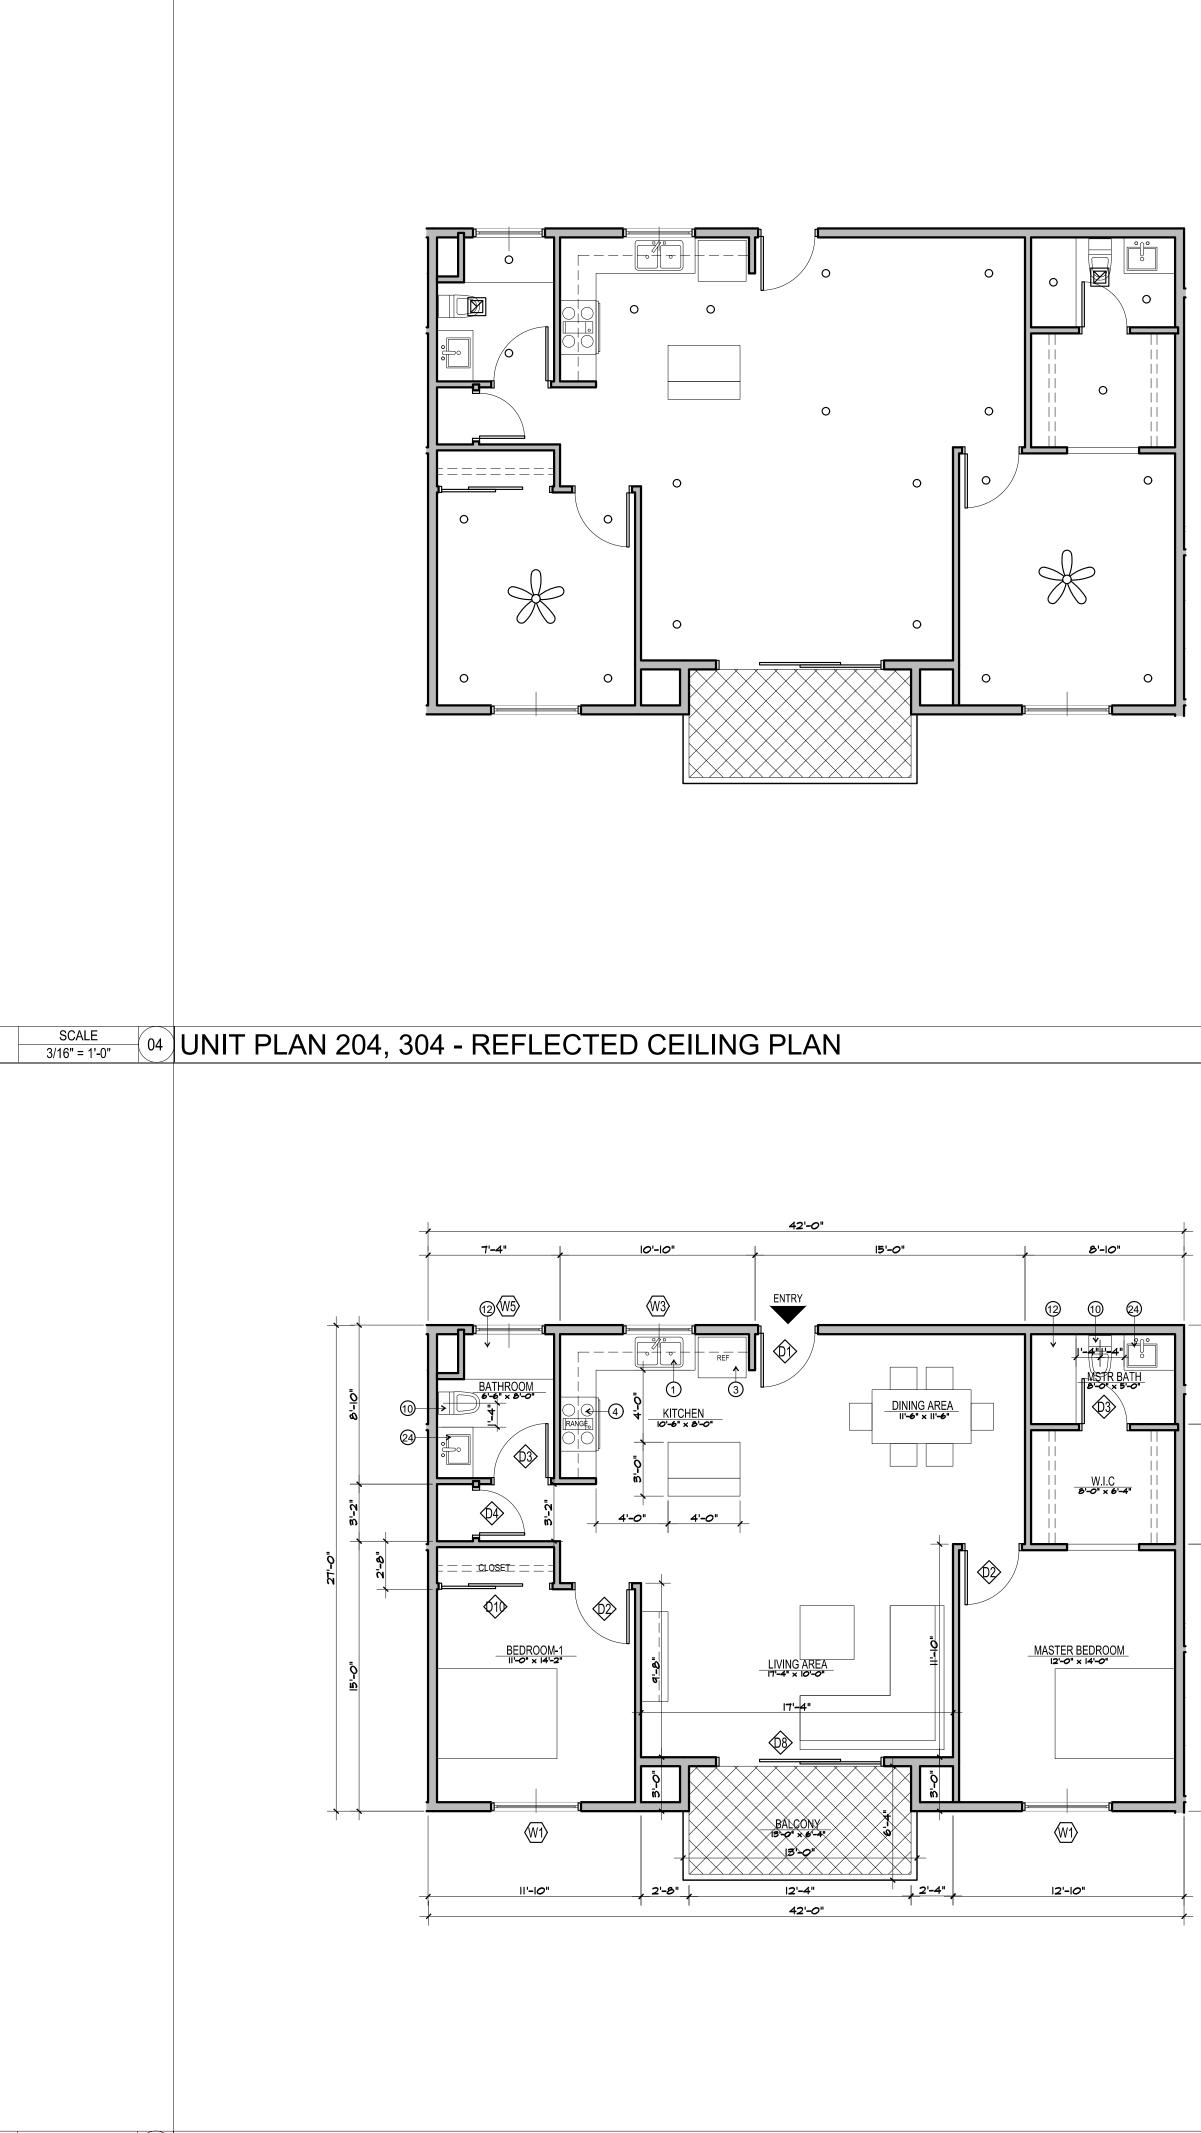


	GENERA	AL NOTES		
	2. COMMON AN P	IS ACCESSIBILITY, REFER TO SHEET A- UBLIC AREAS ACCESSIBILITY, REFER TO SHEETS A- AND A- ED COMPAGE WILL BE LITH IZED FOR A AS		
	4. WALLS ARE PE COMPOSITE FL			
	6. WATER HEATE 7. RECESSED LIG	AVE AT LEAST A MINIMUM LEAKAGE OF 0.30 CFM50 PER SQUARE FOOT OF ENCLOSURE. R UNIT MODEL SEE PLUMBING SCHEDULE. HTING SHALL BE "BOXED IN" AT FIRE RATED FLOOR/CLG CONDITIONS	DESIGN S	TUDIO
		RE MEASURED FROM FACE OF STUD (FOS) UNLESS NOTED OTHERWISE.		
	ELEMENT	DESCRIPTION		
	TYPE A	5/8" GYPSUM BOAR - TAPE, TEXTURE AND PAINT - SATIN LEVEL FIN		
	TYPE B	5/8" GYPSUM BOAR - TAPE, TEXTURE AND PAINT - SEMI GLOSS LEVEL 4 FIN	2173 LOMITA B LOMITA CALIFO	
	TYPE C	EXTERIOR SOFFIT 5/8 " GYP BOARD TYPR X - TAPE, TEXTURE STUCCO FINISH		
		LIMIT OF SOFFIT ABOVE - HEIGHT PER FLOOR PLAN. REFER TO DET 14 & 15/A	Architect:	
	<u> </u>	FLOOR LEVEL AT DOORS SHALL NOT BE MORE THAN $\frac{1}{2}$ INCH LOWER THAN THRESHOLD AT THE DOORWAY PER C.B.C. SECTION 1008.1.6 AND 1132A. 4.1	ART ASHAI,	AIA
	HS C	FLOOR MATERIAL FLUSH TRANSITION	2173 LOMITA E	BLVD. #201
		INTERIOR ELEVATION KEY	LOMITA CALIF PHONE: 424-26	
		ROOM NAME FLOOR FINISH	email: artashai@	
	9'-0"	CEILING HEIGHT		
		DOOR NUMBER - REFER TO DOOR SCHEDULE WINDOW TYPE - REFER TO WINDOW SCHEDULE	Copyright :	
		RECESSED LIGHT FIXTURE (AT AND IC RATED)	This drawing is the DESIGNER, and it is	
			reproduced or copie part. It is not to be	d in whole or used for any
		CEILING FAN	other project and is upon request. The D all copyrights for th	ESIGNER retains
		SUPPLY AIR REGISTER	Owner:	is document.
		SUPPLY AIR SIDE WALL REGISTER		
		RETURN AIR REGISTER	-	
] ++-	RETURN AIR SIDE WALL REGISTER		
		EXHAUST AIR REGISTER / FAN - ENERGY STAR COMPLIANT - SEE MECH		
	60	SMOKE DETECTOR		
	60	CARBON MONOXIDE DETECTOR		
	(WA)	WALL TYPE SYMBOL SEE SCHEDULE ON SHEET A- AND A-		
	UNIT PL	AN KEYNOTES		-
	(1) DOUBLE BOWI	. SINK W WITH GARAGE DISPOSAL & HOLE FOR DISHWASHER AIR GAP. PTABLE REQUIREMENTS WHERE NOTED/		45
	REFER TO SCH	HEDULE OF FINISHES. FER +/ – 24" WIDE DISHWASHER (BOSCH 24" ADA OR APPROVED EQUAL.		
SCALE	ENERGY STAR	CERTIFIED). PROVIDE ADAPTABLE REQUIREMENTS. IEDULE OF FINISHES.		AIN A
3/16" = 1'-0" 02	1-HR RATED W	IR SPACE. PROVIDE COLD WATER STUB-OUT IN RECESSED WALL BOX FOR ICE MAKER. PROVIDE ALL RECESS WHERE OCCURS IN 1-HR RATED WALL ASSEMBLY. PROVIDE ADAPTABLE IS. REFER TO SCHEDULE OF FINISHES.		ALIFORNIA
	INSTALL APPL	IG RANGE AND OVER THE RANGE MICROWAVE (BOTH ENERGY STAR CERTIFIED) VERIFY AND ANCES PER MANUFACTURER'S REQUIREMENTS. PROVIDE ADAPTABLE REQUIREMENTS. PROVIDE	<u> </u>	s Ľ-,
	15" BREADBOA 5 24" DEEP BASI	RD EA SIDE. E CABINET WITH COUNTERTOP		CA
	6 12" DEEP UPP			Š Š
		WASHER AND DRYER – STACKED		CARSON
	9 ULTRA-LOW FI REQUIREMEN	USH TOILET - REFER TO DETAIL FOR ACCESSIBILITY IS		U U
	(10) 32" x 60" TUB/S PRIOR TO FRA	HOWER - VERIFY UNIT DIMENSIONS WITH MANUFACTURER MING		
	ASSEMBLY	DICINE CABINET. PROVIDE 1- HR RATED WALL RECESS WHERE OCCURS IN 1 -HR RATED WALL		
		RAB BAR. PROVIDE SOLID BLOCKING CONCEALED WITHIN WALL CENTERED ON BAR LOCATION		
	POLE AND SHE	IEL - REFER TO ELECTRICAL DRAWINGS FOR SOME INFORMATION ELF. LOCATE POLE 66" ABOVE FINISH FLOOR. PROVIDE 2x6 BLOCKING WITHIN		I
	CONCEALED 2	EACH END & CENTER OF POLE FOR POLE HARDWARE. VERIFY SHELF BRACKETS & PROVIDE x BLOCKING ACCORDINGLY.	PROJECT INFORM	ATION:
		ITED HORIZONTAL FAN COIL UNIT. (SEE MECHANICAL PLANS) VERIFY UNIT DIMENSIONS AND	Project Title :	
		EQUIREMENTS PRIOR TO FRAMING AND SETTING DROPPED CEILING HEIGHT. PROVIDE MINIMUM NUFACTURE ACCESS PANEL COMPATIBLE WITH F.C.U. PAINT PANEL TO MATCH CEILING.	CARSON APARTM 21240 Main Street Carsor	
	NOT GREATER	HOLD. FLOOR LEVEL CHANGES GREATER THAN [‡] " AT DOORWAYS SHALL BE BEVELED OR SLOPED THAN ONE UNIT VERTICAL IN TWO UNITS 50% SLOPE). REFER TO DETAILS AT ENTRY DOOR AT BALCONY SLIDING DOOR	21250 Main Street Carson	
		ELL AT +48"AFF - SEE ELEC	LEGAL DESCRIPTION :	
	(21) UNIT SIGNAGE		APN: 7334-002-007 APN: 7334-002-008	
		ETER AT HIGH LEVEL INSIDE CEILING SPACE WITH CEILING ACCESS - SEE PLUMBING WATER METER DISPLAY. MOUNT HT. AT 4' - 0". ABOVE FINISH FLOOR TO TOP OF DISPLAY		
	24) 15" MIN. BREAU	DBOARD		x=+aR A=+A A=+A A=+A A=+A A=+A A=+A A=+A A=+
		TANKLESS WATER HEATER. SEE PLUMBING DRAWINGS. RED CLEARANCES WITH MFR PRIOR TO FRAMING		☆ UC.# 0-26787 FV3- 12/71/21
	(26) SMOKE DETEC (27) CARBON MON	CTOR DXIDE DETECTOR		The ALL STREET
			Rev. # Date/Issue	Notes
		V WALL - REFER TO EXTERIOR ELEVATION		
		AUST LOUVER - SEE MECHANICAL	2	
	32) GUTTER			
	33 SCUPPER 34 CEILING BREA	κ		
		OFFIT VENT - SEE DETAIL		
	(36) NOT USED			
			UNIT P	
			Scale : J AS NOTED	ob Number : J-1908
			Date : Aug2021 S	Sheet Number :
			Drawn : arkihaus	4-113
SCALE 3/16" = 1'-0"			Check'd : CTV/RRJ	

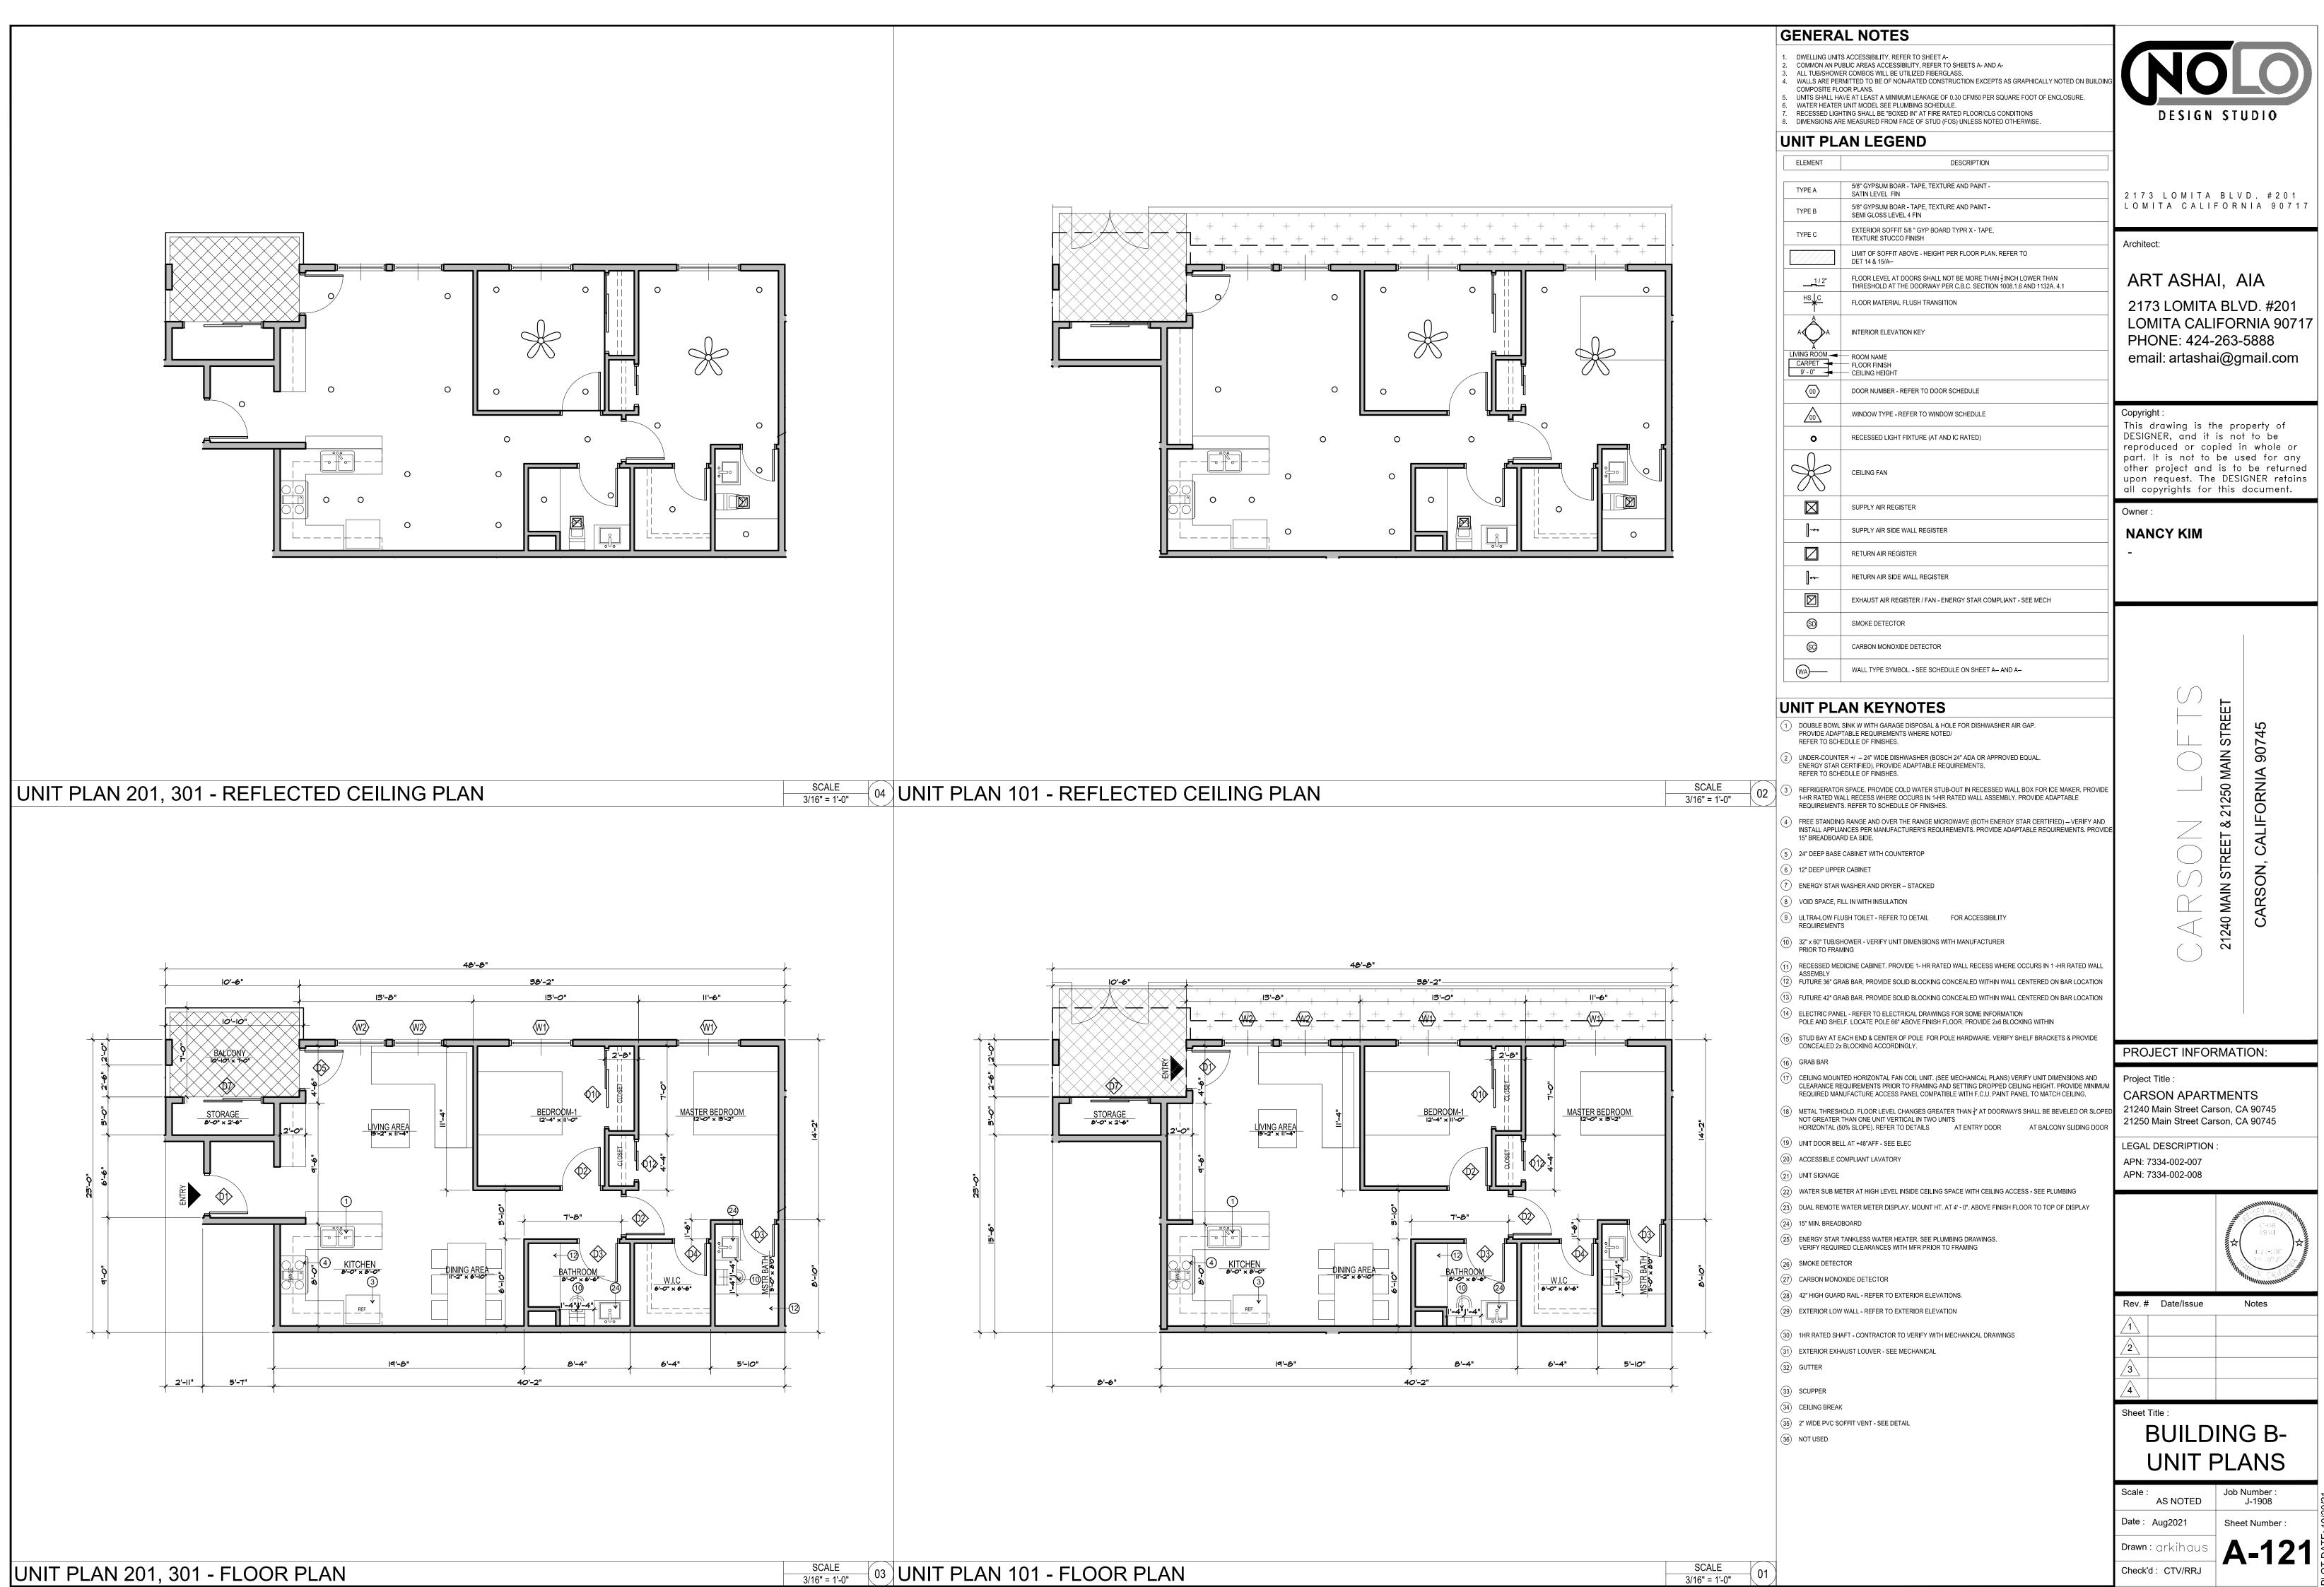

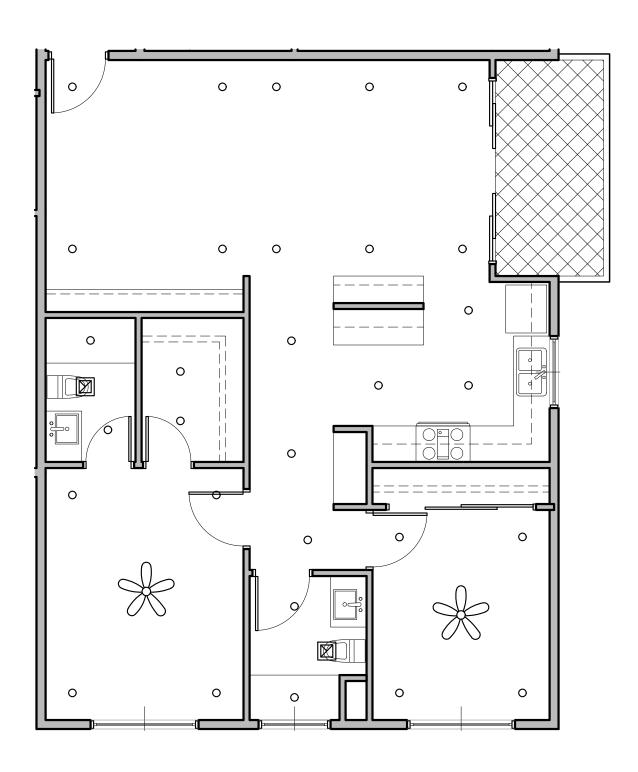



UNIT PLAN 203 - REFLECTED CEILING PLAN

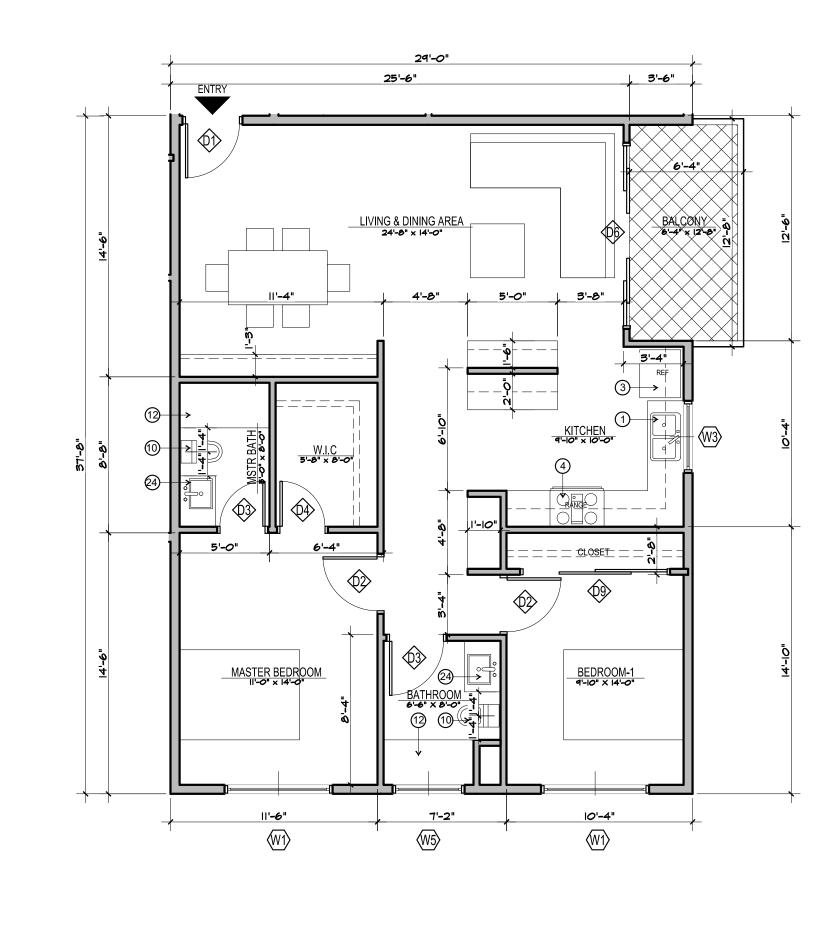




		GENERA			
		1. DWELLING UNITS 2. COMMON AN PU	S ACCESSIBILITY, REFER TO SHEET A- BLIC AREAS ACCESSIBILITY, REFER TO SHEETS A- AND A-		
		3. ALL TUB/SHOWE 4. WALLS ARE PER COMPOSITE FLC	R COMBOS WILL BE UTILIZED FIBERGLASS. MITTED TO BE OF NON-RATED CONSTRUCTION EXCEPTS AS GRAPHICALLY NOTED ON BUILDING	(NC	
		6. WATER HEATER 7. RECESSED LIGH	UNIT MODEL SEE PLUMBING SCHEDULE. TING SHALL BE "BOXED IN" AT FIRE RATED FLOOR/CLG CONDITIONS E MEASURED FROM FACE OF STUD (FOS) UNLESS NOTED OTHERWISE.	DESIGN	STUDIO
		UNIT PL	AN LEGEND		
		ELEMENT			
		TYPE A	5/8" GYPSUM BOAR - TAPE, TEXTURE AND PAINT - SATIN LEVEL FIN 5/8" GYPSUM BOAR - TAPE, TEXTURE AND PAINT -	2173 LOMITA LOMITA CALIF	
		TYPE B	SEMI GLOSS LEVEL 4 FIN EXTERIOR SOFFIT 5/8 " GYP BOARD TYPR X - TAPE,		
			TEXTURE STUCCO FINISH LIMIT OF SOFFIT ABOVE - HEIGHT PER FLOOR PLAN. REFER TO DET 14 & 15/A	Architect:	
0		<u>1/2"</u>	FLOOR LEVEL AT DOORS SHALL NOT BE MORE THAN $\frac{1}{2}$ INCH LOWER THAN THRESHOLD AT THE DOORWAY PER C.B.C. SECTION 1008.1.6 AND 1132A. 4.1	ART ASHA	I, AIA
			FLOOR MATERIAL FLUSH TRANSITION	2173 LOMITA	
		A	INTERIOR ELEVATION KEY	PHONE: 424-2	FORNIA 90717 263-5888
		LIVING ROOM	- ROOM NAME - FLOOR FINISH - CEILING HEIGHT	email: artasha	i@gmail.com
			DOOR NUMBER - REFER TO DOOR SCHEDULE		
0			WINDOW TYPE - REFER TO WINDOW SCHEDULE	Copyright : This drawing is th	
		• •	RECESSED LIGHT FIXTURE (AT AND IC RATED)	DESIGNER, and it i reproduced or cop part. It is not to	ied in whole or
		X	CEILING FAN	other project and upon request. The all copyrights for	is to be returned DESIGNER retains
			SUPPLY AIR REGISTER	Owner:	40041110111.
0			SUPPLY AIR SIDE WALL REGISTER	NANCY KIM	
				-	
			RETURN AIR SIDE WALL REGISTER EXHAUST AIR REGISTER / FAN - ENERGY STAR COMPLIANT - SEE MECH		
		50 50	SMOKE DETECTOR		
		©	CARBON MONOXIDE DETECTOR		
			WALL TYPE SYMBOL SEE SCHEDULE ON SHEET A- AND A-		
			AN KEYNOTES		
		PROVIDE ADAP	SINK W WITH GARAGE DISPOSAL & HOLE FOR DISHWASHER AIR GAP. TABLE REQUIREMENTS WHERE NOTED/ EDULE OF FINISHES.		STREE1
		2 UNDER-COUNTE ENERGY STAR	ER +/ – 24" WIDE DISHWASHER (BOSCH 24" ADA OR APPROVED EQUAL. CERTIFIED). PROVIDE ADAPTABLE REQUIREMENTS. EDULE OF FINISHES.		
	SCALE 3/16" = 1'-0" 02	3 REFRIGERATOR 1-HR RATED WA	R SPACE. PROVIDE COLD WATER STUB-OUT IN RECESSED WALL BOX FOR ICE MAKER. PROVIDE ALL RECESS WHERE OCCURS IN 1-HR RATED WALL ASSEMBLY. PROVIDE ADAPTABLE		21250 MAIN ORNIA 90
		(4) FREE STANDING	S. REFER TO SCHEDULE OF FINISHES. G RANGE AND OVER THE RANGE MICROWAVE (BOTH ENERGY STAR CERTIFIED) VERIFY AND NCES PER MANUFACTURER'S REQUIREMENTS. PROVIDE ADAPTABLE REQUIREMENTS. PROVIDE	$\overline{}$	-IFOI
		15" BREADBOAF			CAL
		6 12" DEEP UPPER	R CABINET WASHER AND DRYER – STACKED	\sim	N STREI SON, C
		8 VOID SPACE, FI	LL IN WITH INSULATION JSH TOILET - REFER TO DETAIL FOR ACCESSIBILITY		21240 MAIN ST CARSON
		REQUIREMENTS (10) 32" x 60" TUB/SH	S HOWER - VERIFY UNIT DIMENSIONS WITH MANUFACTURER		C C
	_	PRIOR TO FRAM			
	_	12 FUTURE 36" GR	AB BAR. PROVIDE SOLID BLOCKING CONCEALED WITHIN WALL CENTERED ON BAR LOCATION AB BAR. PROVIDE SOLID BLOCKING CONCEALED WITHIN WALL CENTERED ON BAR LOCATION		
		14 ELECTRIC PANE	EL - REFER TO ELECTRICAL DRAWINGS FOR SOME INFORMATION .F. LOCATE POLE 66" ABOVE FINISH FLOOR. PROVIDE 2x6 BLOCKING WITHIN		
		CONCEALED 2x	ACH END & CENTER OF POLE FOR POLE HARDWARE. VERIFY SHELF BRACKETS & PROVIDE BLOCKING ACCORDINGLY.	PROJECT INFOR	MATION:
			TED HORIZONTAL FAN COIL UNIT. (SEE MECHANICAL PLANS) VERIFY UNIT DIMENSIONS AND QUIREMENTS PRIOR TO FRAMING AND SETTING DROPPED CEILING HEIGHT. PROVIDE MINIMUM	Project Title :	
<u>OM</u>	=_	REQUIRED MAN	IUFACTURE ACCESS PANEL COMPATIBLE WITH F.C.U. PAINT PANEL TO MATCH CEILING. OLD. FLOOR LEVEL CHANGES GREATER THAN $\frac{1}{4}$ " AT DOORWAYS SHALL BE BEVELED OR SLOPED	CARSON APART 21240 Main Street Car	son, CA 90745
	<u>.4</u> ゆ	NOT GREATER - HORIZONTAL (5	THAN ONE UNIT VERTICAL IN TWO UNITS 0% SLOPE). REFER TO DETAILS AT ENTRY DOOR AT BALCONY SLIDING DOOR I. AT +48"AFF - SEE ELEC	21250 Main Street Car	
		20 ACCESSIBLE CO	DMPLIANT LAVATORY	LEGAL DESCRIPTION APN: 7334-002-007	
			TER AT HIGH LEVEL INSIDE CEILING SPACE WITH CEILING ACCESS - SEE PLUMBING	APN: 7334-002-008	
		(23) DUAL REMOTE (24) 15" MIN. BREAD	WATER METER DISPLAY. MOUNT HT. AT 4' - 0". ABOVE FINISH FLOOR TO TOP OF DISPLAY BOARD		ATHAR ASUAL LE # 0-2578 PC: 24/5/77
		25) ENERGY STAR	TANKLESS WATER HEATER. SEE PLUMBING DRAWINGS. ED CLEARANCES WITH MFR PRIOR TO FRAMING		
MSTR BA	<u>e</u> 0	26 SMOKE DETECT 27 CARBON MONO	TOR XIDE DETECTOR		MANNA PE CALO
▶			D RAIL - REFER TO EXTERIOR ELEVATIONS. WALL - REFER TO EXTERIOR ELEVATION	Rev. # Date/Issue	Notes
 			AFT - CONTRACTOR TO VERIFY WITH MECHANICAL DRAWINGS		
5'-10"	_	31) EXTERIOR EXH/	AUST LOUVER - SEE MECHANICAL	<u>2</u> <u>3</u>	
ľ		(33) SCUPPER		<u> </u>	
		34 CEILING BREAK 35 2" WIDE PVC SC	DFFIT VENT - SEE DETAIL	Sheet Title :	
		36 NOT USED		BUILDI	
				UNIT F	'LANS
				Scale : AS NOTED	Job Number : J-1908
				Date : Aug2021	Sheet Number :
				Drawn : arkihaus	A-122
	SCALE 3/16" = 1'-0")		Check'd : CTV/RRJ	

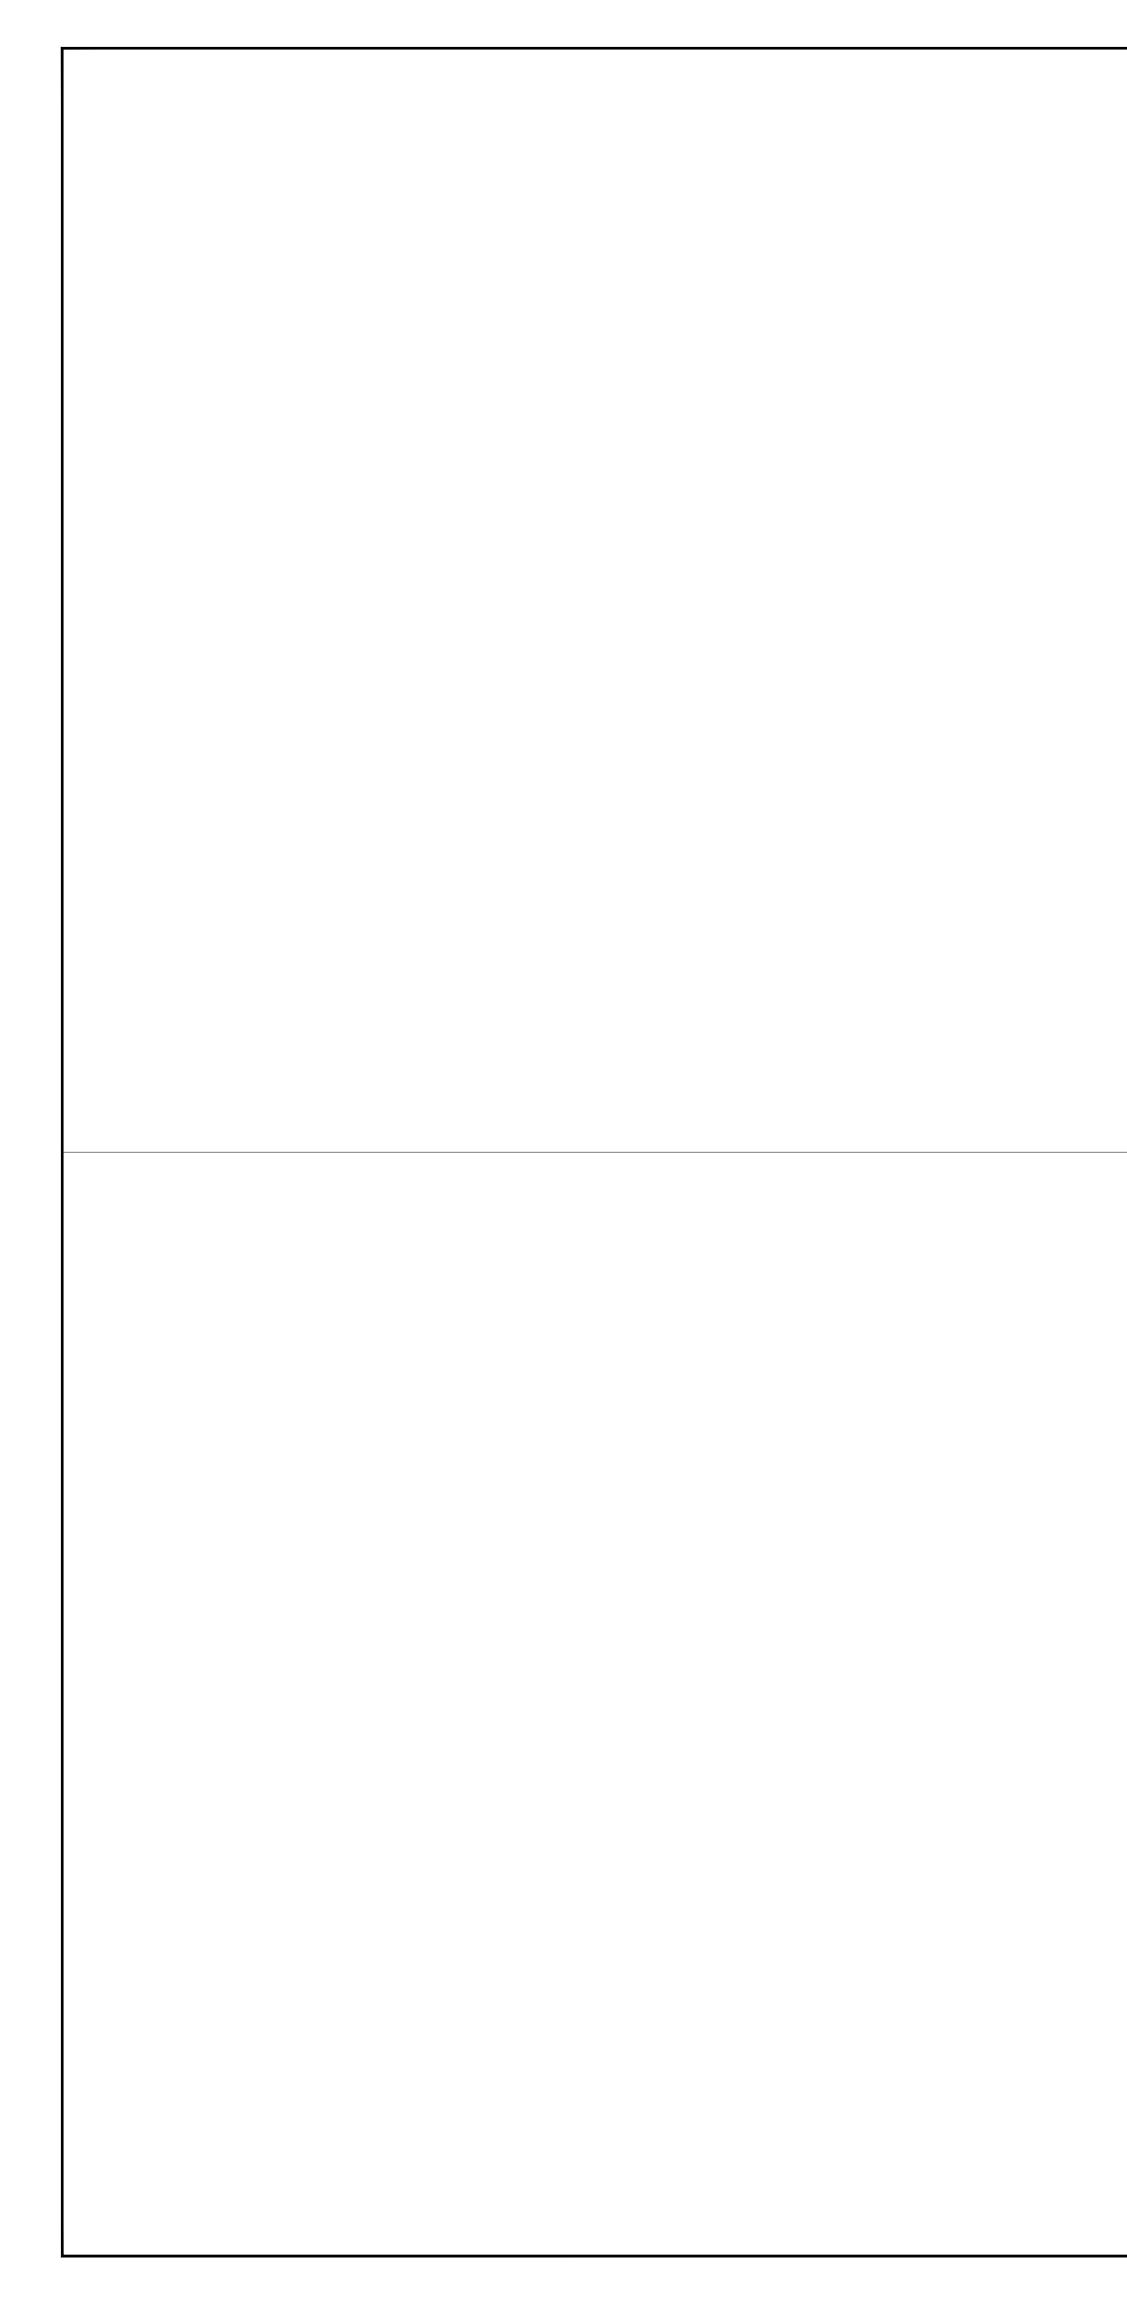

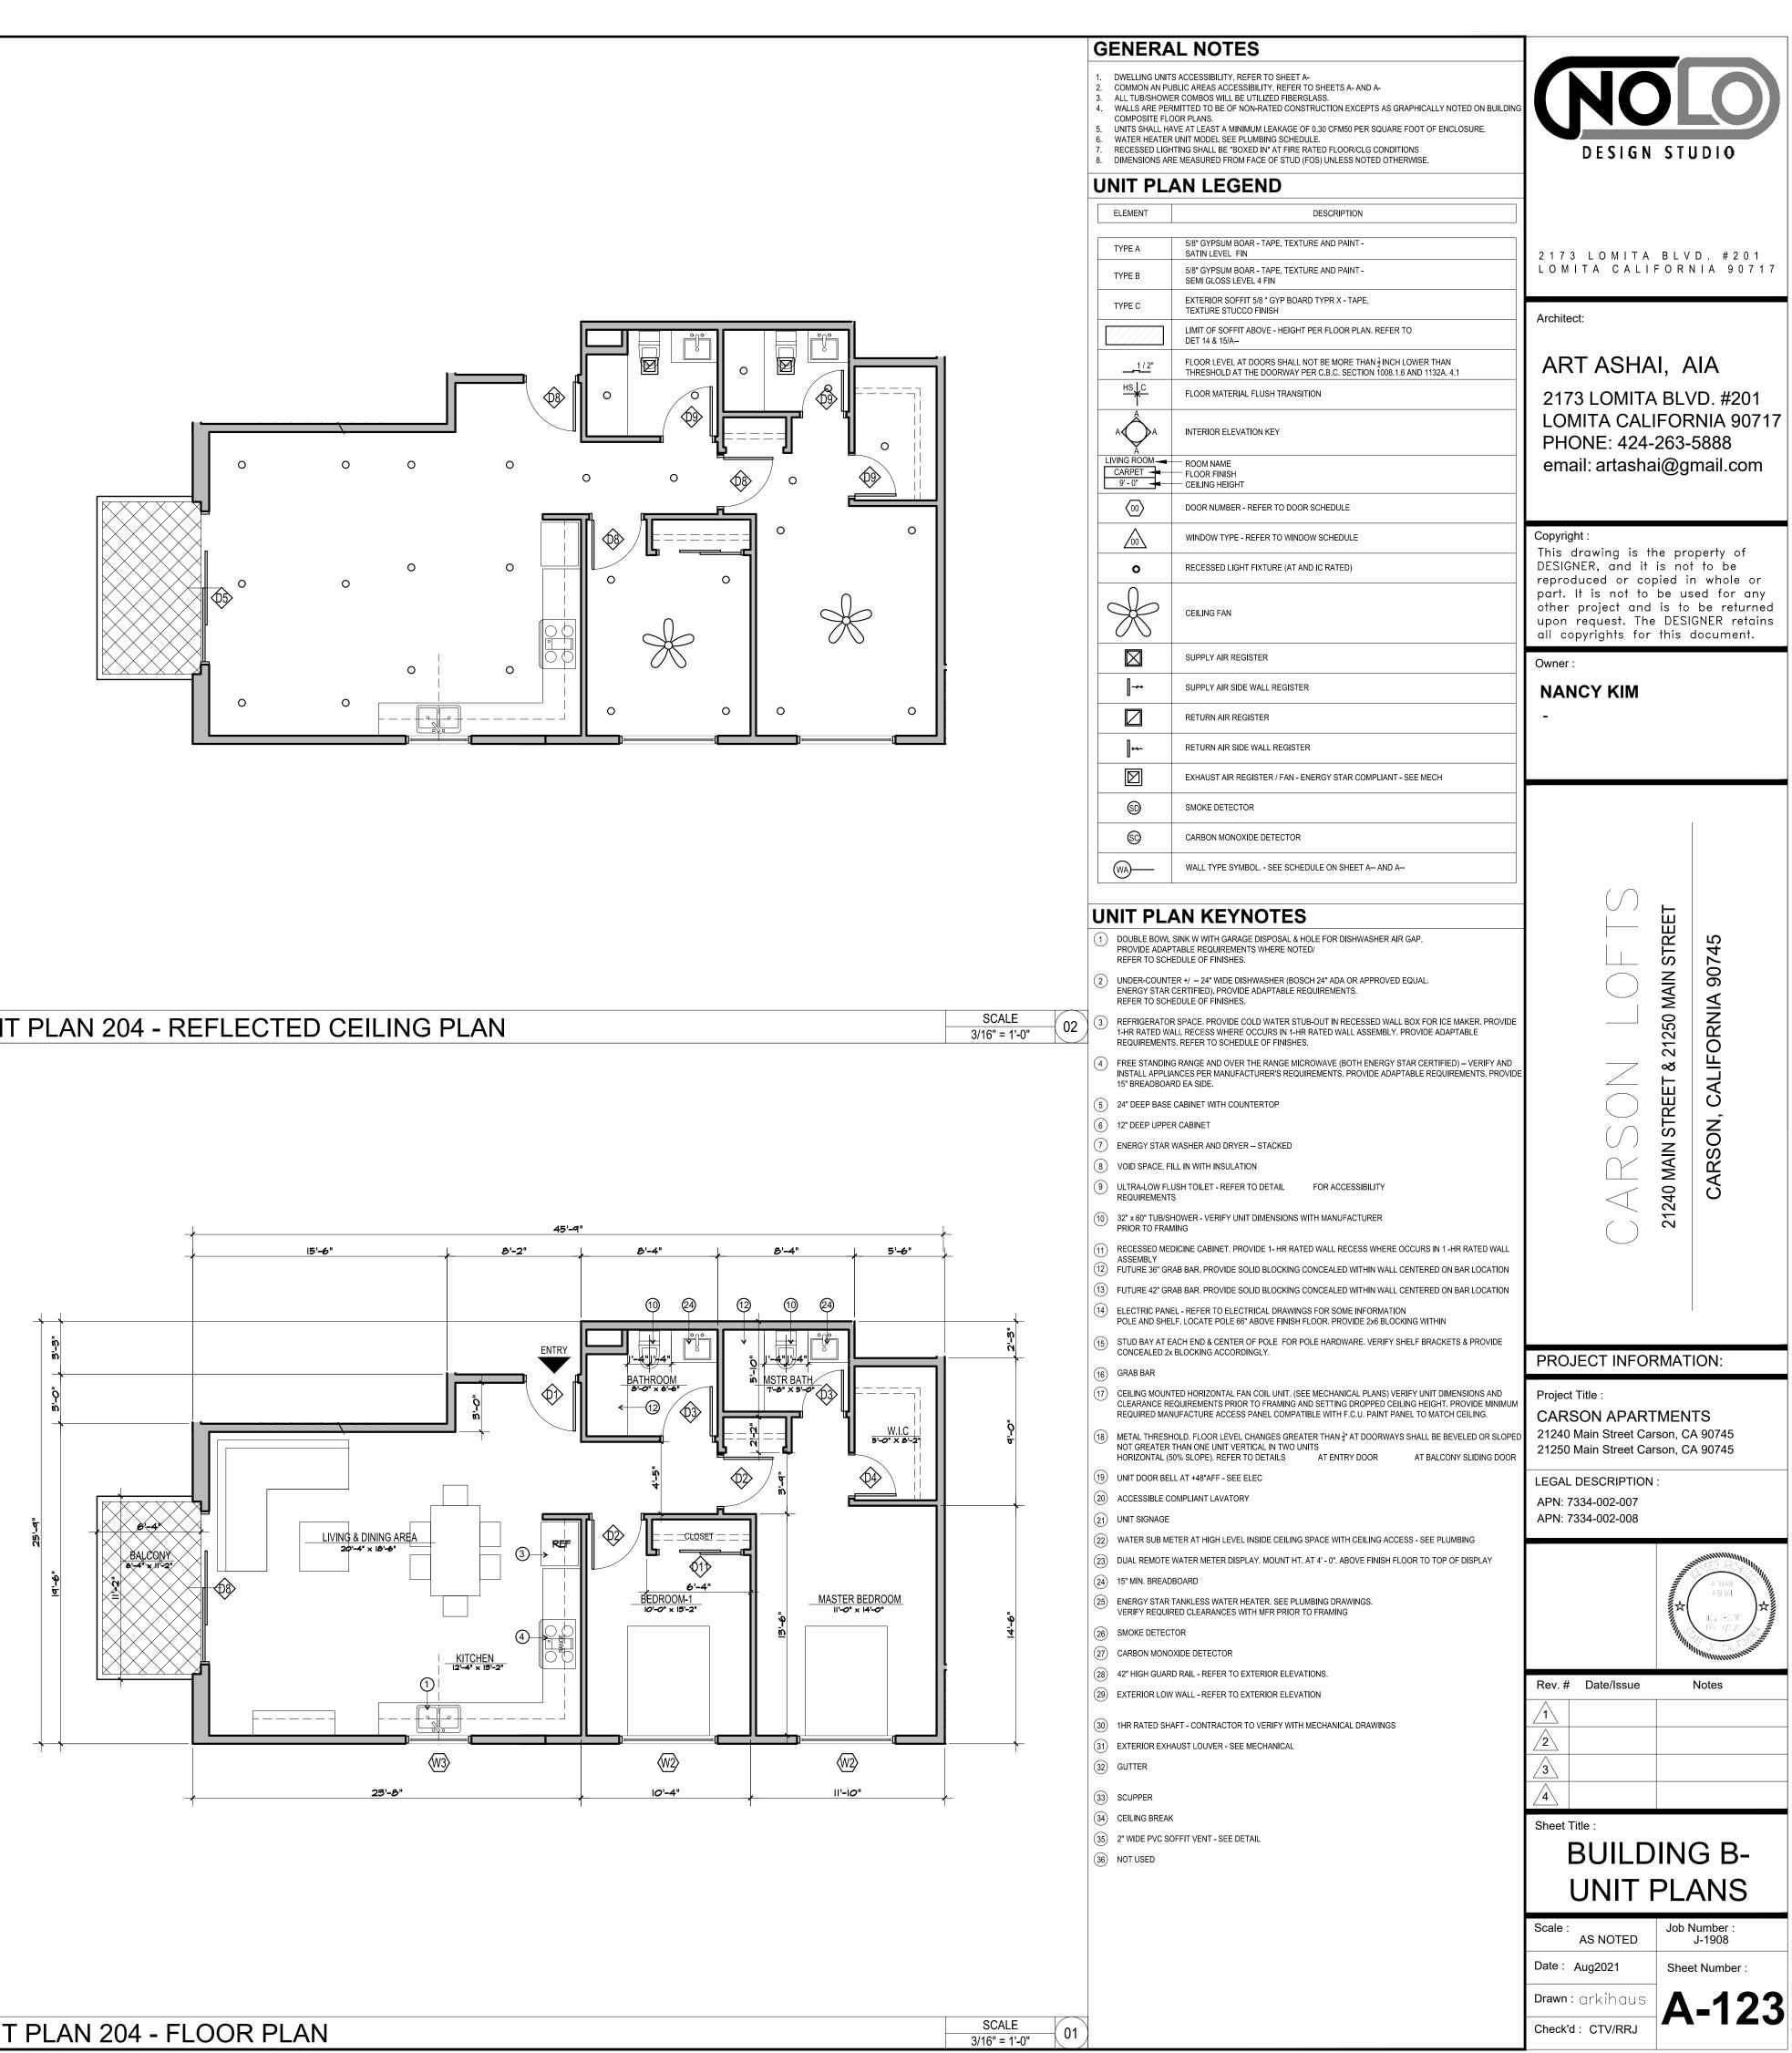


UNIT PLAN 204 - REFLECTED CEILING PLAN




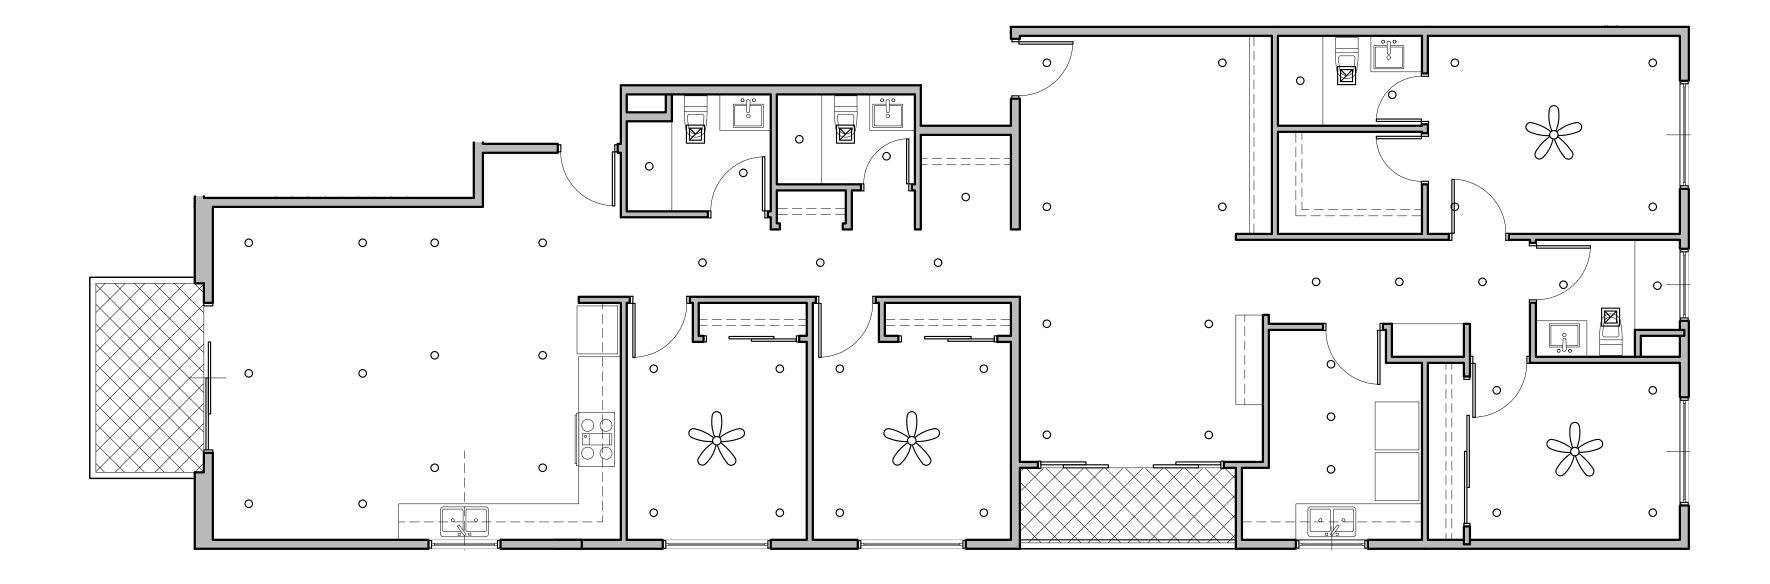


UNIT PLAN 303 - REFLECTED CEILING PLAN

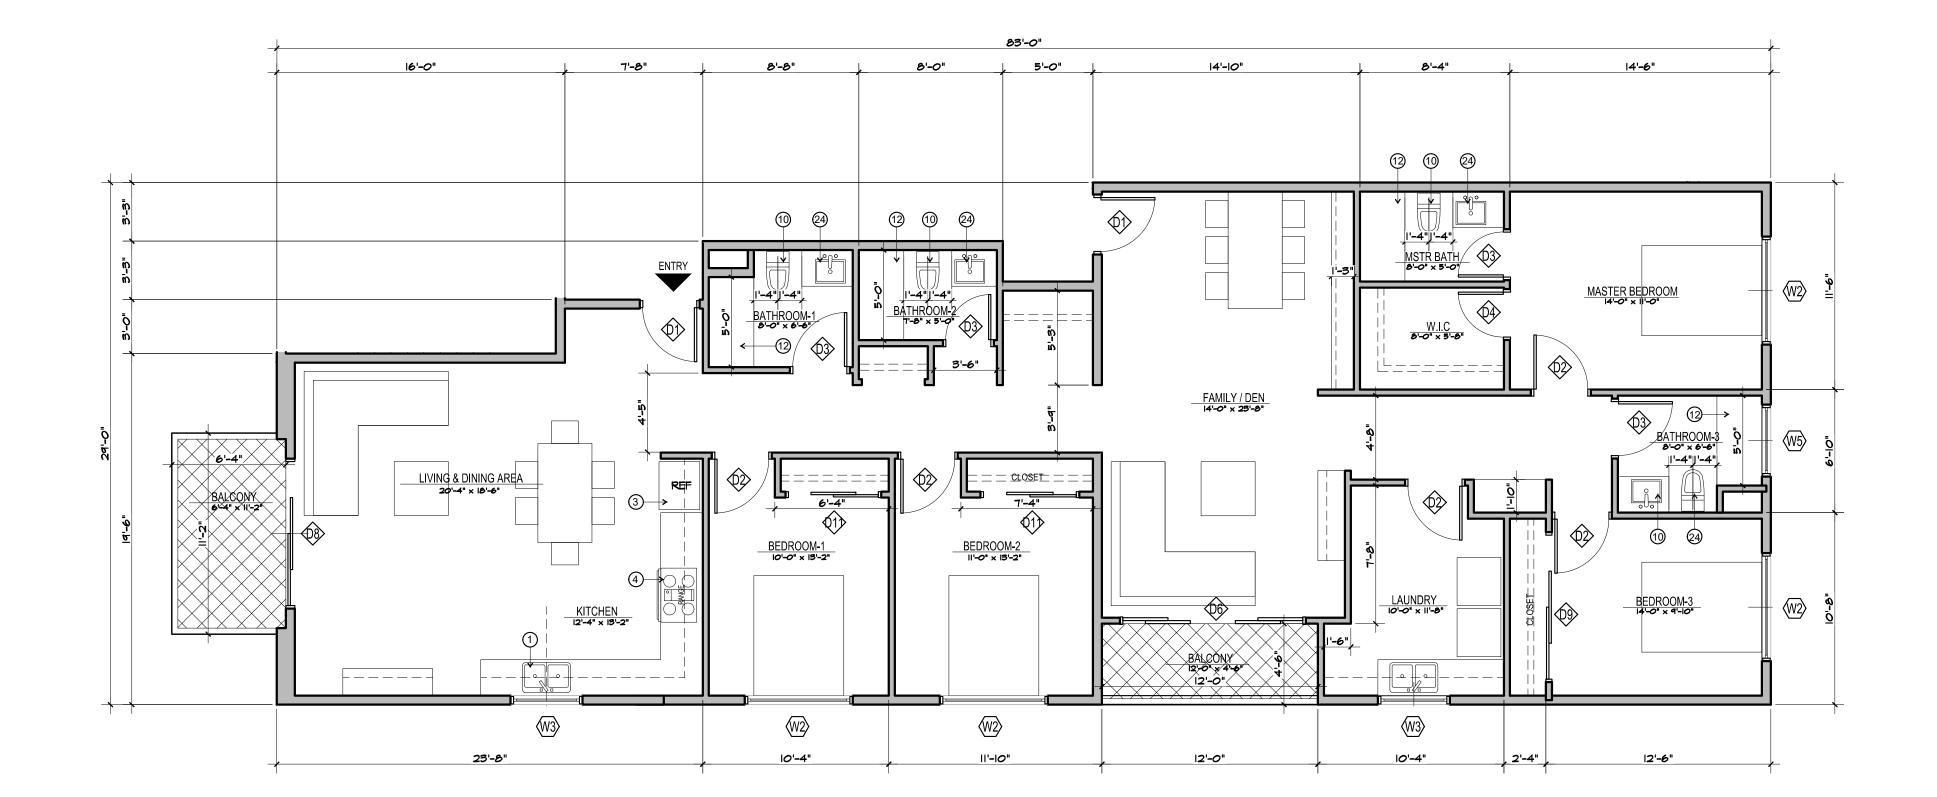


			VELLING UNITS DMMON AN PUE L TUB/SHOWEI ALLS ARE PERI DMPOSITE FLO ITS SHALL HAY ATER HEATER CESSED LIGH MENSIONS ARE IT PL/ EMENT PE A PE B PE C 1/2" HS C A A G ROOM G ROOM C O O	VE AT LEAST A MINIMUM LEAKAGE OF 0.30 CFM50 PER SQUARE FOOT OF ENCLOSURE. UNIT MODEL SEE PLUMBING SCHEDULE. TING SHALL BE "BOXED IN" AT FIRE RATED FLOOR/CLG CONDITIONS EMEASURED FROM FACE OF STUD (FOS) UNLESS NOTED OTHERWISE. AN LEGEND DESCRIPTION 5/8" GYPSUM BOAR - TAPE, TEXTURE AND PAINT - SATIN LEVEL FIN 5/8" GYPSUM BOAR - TAPE, TEXTURE AND PAINT - SKM GLOSS LEVEL 4 FIN EXTENIOR SOFFIT 5/8" GYP BOARD TYPR X - TAPE, TEXTURE STUCCO FINISH LIMIT OF SOFFIT ABOVE - HEIGHT PER FLOOR PLAN. REFER TO DET 14 & 15/A- FLOOR LEVEL AT DOORS SHALL NOT BE MORE THAN ½INCH LOWER THAN THRESHOLD AT THE DOORWAY PER C.B.C. SECTION 1008.1.6 AND 1132A. 4.1 FLOOR MATERIAL FLUSH TRANSITION INTERIOR ELEVATION KEY ROOM NAME PLOOR FINISH CEILING HEIGHT DOOR NUMBER - REFER TO DOOR SCHEDULE WINDOW TYPE - REFER TO WINDOW SCHEDULE RECESSED LIGHT FIXTURE (AT AND IC RATED) CEILING FAN	DESIGN 2 1 7 3 LOMITA LOMITA CALIF Architect: ART ASHA 2173 LOMITA 2173 LOMITA LOMITA CALIF PHONE: 424-2 email: artashai Copyright: This drawing is th DESIGNER, and it i reproduced or cop part. It is not to b other project and upon request. The all copyrights for	BLVD. #201 ORNIA 90717 I, AIA BLVD. #201 FORNIA 90717 263-5888 i@gmail.com
				SUPPLY AIR REGISTER SUPPLY AIR SIDE WALL REGISTER	Owner : NANCY KIM	
				RETURN AIR REGISTER	-	
			 2	RETURN AIR SIDE WALL REGISTER EXHAUST AIR REGISTER / FAN - ENERGY STAR COMPLIANT - SEE MECH		
			 ©D	SMOKE DETECTOR		
			© }	CARBON MONOXIDE DETECTOR WALL TYPE SYMBOL SEE SCHEDULE ON SHEET A AND A		
			-	AN KEYNOTES		ы
SCALE 3/16" = 1'-0"		1 DOP 1 DOP 2 DOP 3 RE1-RE 3 RE1-RE 3 RE1-RE 4 REST 5 24' 6 12' 7 8 9 ULRE 10 REAST 11 12 12 FU 13 FU 14 PO 15 STCC 16 17 17 RE 18 MEXAND 19 UN 21 UN 22 W 23 DU 24 15'	IT PLA DUBLE BOWLS COUDE ADAPT EFER TO SCHE NERGY STAR O EFER TO SCHE ERIGERATOR HR RATED WA EQUIREMENTS REE STANDING STALL APPLIA " BREADBOAR " DEEP UPPER NERGY STAR V OID SPACE, FIL LTRA-LOW FLU EQUIREMENTS " A 60" TUB/SH RIOR TO FRAM ECESSED MED SSEMBLY JTURE 42" GRA LECTRIC PANE DLE AND SHEL TUD BAY AT EA ONCEALED 2X RAB BAR EILING MOUNT LEARANCE REI EQUIRED MANI ETAL THRESH DONCEALED 2X RAB BAR EILING MOUNT LEARANCE REI CONT GREATER TO ONCEALED CON NIT DOOR BELL CONT SIGNAGE VATER SUB ME" UAL REMOTE V S" MIN. BREADE	CABINET WITH COUNTERTOP CABINET VASHER AND DRYER – STACKED LI IN WITH INSULATION ISSH TOILET - REFER TO DETAIL FOR ACCESSIBILITY OWER - VERIFY UNIT DIMENSIONS WITH MANUFACTURER OWER - VERIFY UNIT DIMENSIONS CONCEALED WITHIN WALL CENTERED ON BAR LOCATION AB BAR. PROVIDE SOLID BLOCKING CONCEALED WITHIN WALL CENTERED ON BAR LOCATION AB BAR. PROVIDE SOLID BLOCKING CONCEALED WITHIN WALL CENTERED ON BAR LOCATION L - REFER TO ELECTRICAL DRAWINGS FOR SOME INFORMATION F. LOCATE POLE 66° ABOVE FINISH FLOOR. PROVIDE 2x6 BLOCKING WITHIN ACH END & CENTER OF POLE FOR POLE HARDWARE. VERIFY SHELF BRACKETS & PROVIDE BLOCKING ACCORDINGLY. ED HORIZONTAL FAN COIL UNIT. (SEE MECHANICAL PLANS) VERIFY UNIT DIMENSIONS AND QUIREMENTS PRIOR TO FRAMING AND SETTING DROPPED CEILING HEIGHT. PROVIDE MINIMUM UFACTURE ACCESS PANEL COMPATIBLE WITH F.C.U. PAINT PANEL TO MATCH CEILING. OLD. FLOOR LEVEL CHANGES GREATER THAN ¹ / ₄ AT DOORWAYS SHALL BE BEVELED OR SLOPED THAN ONE UNIT VERTICAL IN TWO UNITS % SLOPE). REFER TO DETAILS AT ENTRY DOOR AT BALCONY SLIDING DOOR L AT +48°AFF - SEE ELEC MUPLIANT LAVATORY TER AT HIGH LEVEL INSIDE CEILING SPACE WITH CEILING ACCESS - SEE PLUMBING WATER METER DISPLAY. MOUNT HT. AT 4' - 0''. ABOVE FINISH FLOOR TO TOP OF DISPLAY BOARD ANKLESS WATER HEATER. SEE PLUMBING DRAWINGS.		MENTS son, CA 90745 son, CA 90745
		(26) SM (27) CA (28) 42'	MOKE DETECT ARBON MONO 2" HIGH GUARE	ED CLEARANCES WITH MFR PRIOR TO FRAMING OR XIDE DETECTOR D RAIL - REFER TO EXTERIOR ELEVATIONS. WALL - REFER TO EXTERIOR ELEVATION	Rev. # Date/Issue	Notes
		31) EX	XTERIOR EXHA	FT - CONTRACTOR TO VERIFY WITH MECHANICAL DRAWINGS NUST LOUVER - SEE MECHANICAL		
			UTTER CUPPER			
		34 CE 35 2" 36 NC	Sheet Title : BUILDI UNIT F			
					Scale : AS NOTED	Job Number : J-1908
					Date: Aug2021 Drawn: arkihaus	Sheet Number :
	SCALE 3/16" = 1'-0"	01			Check'd : CTV/RRJ	A-124

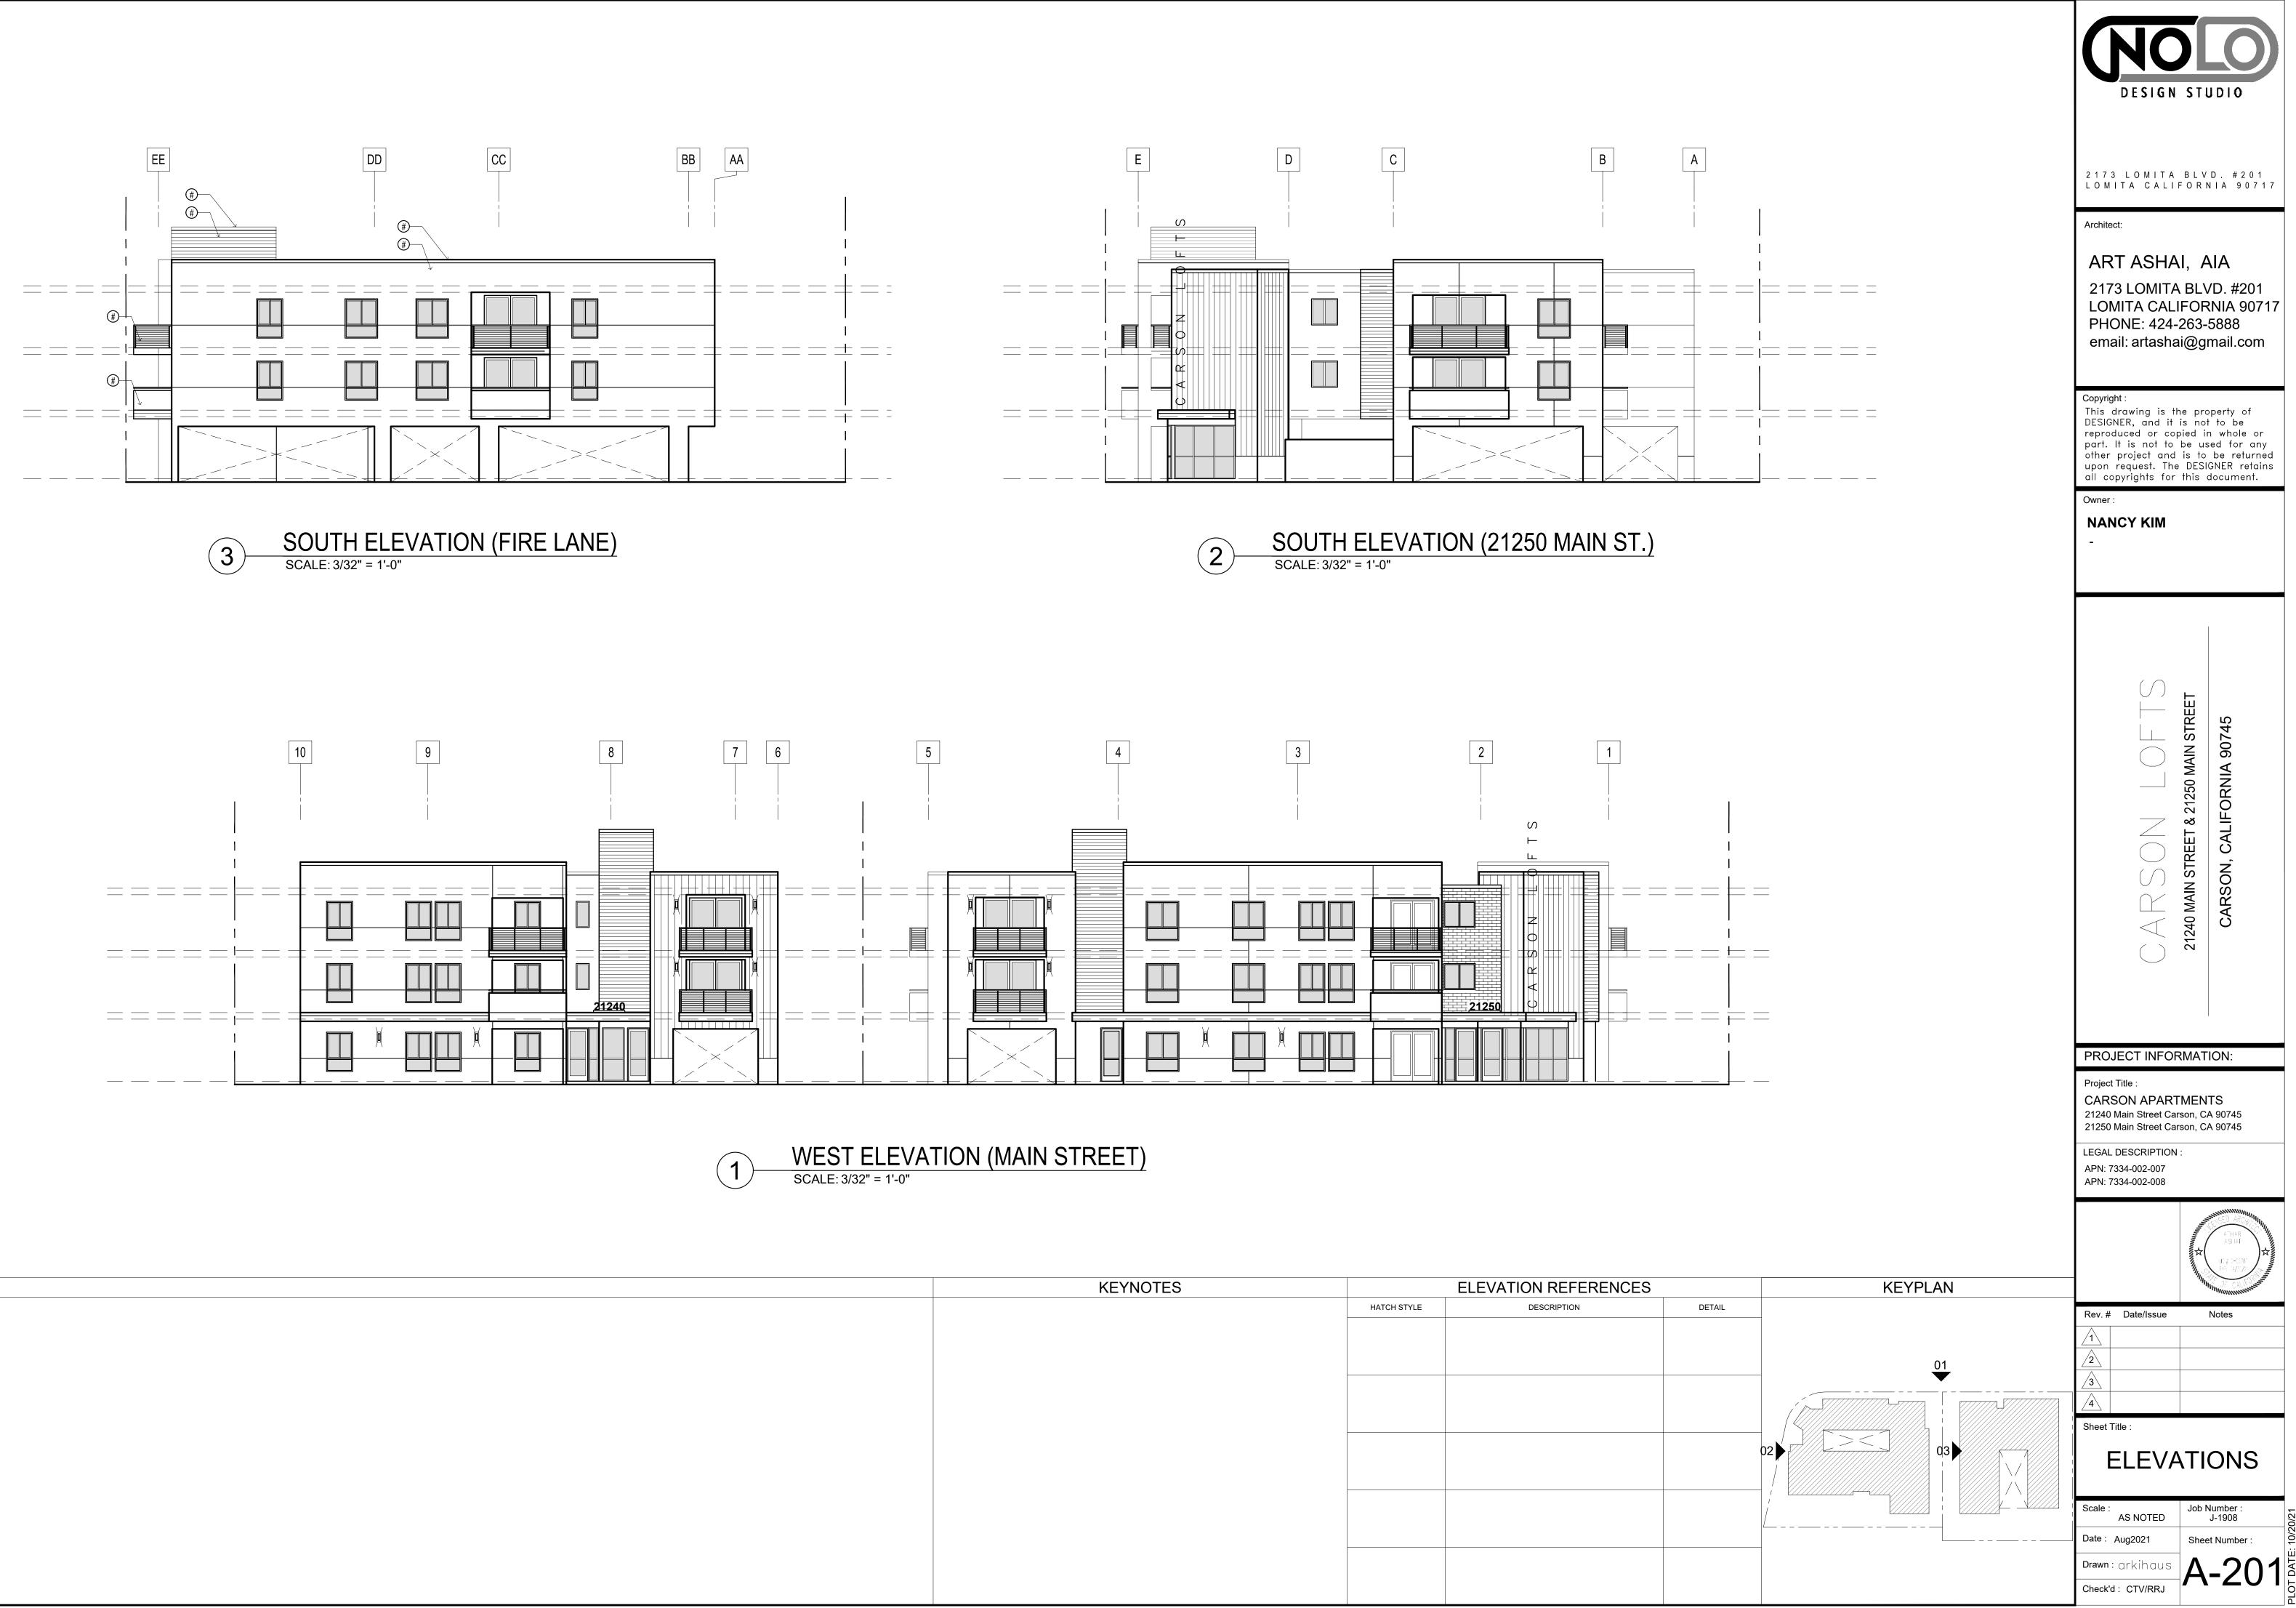


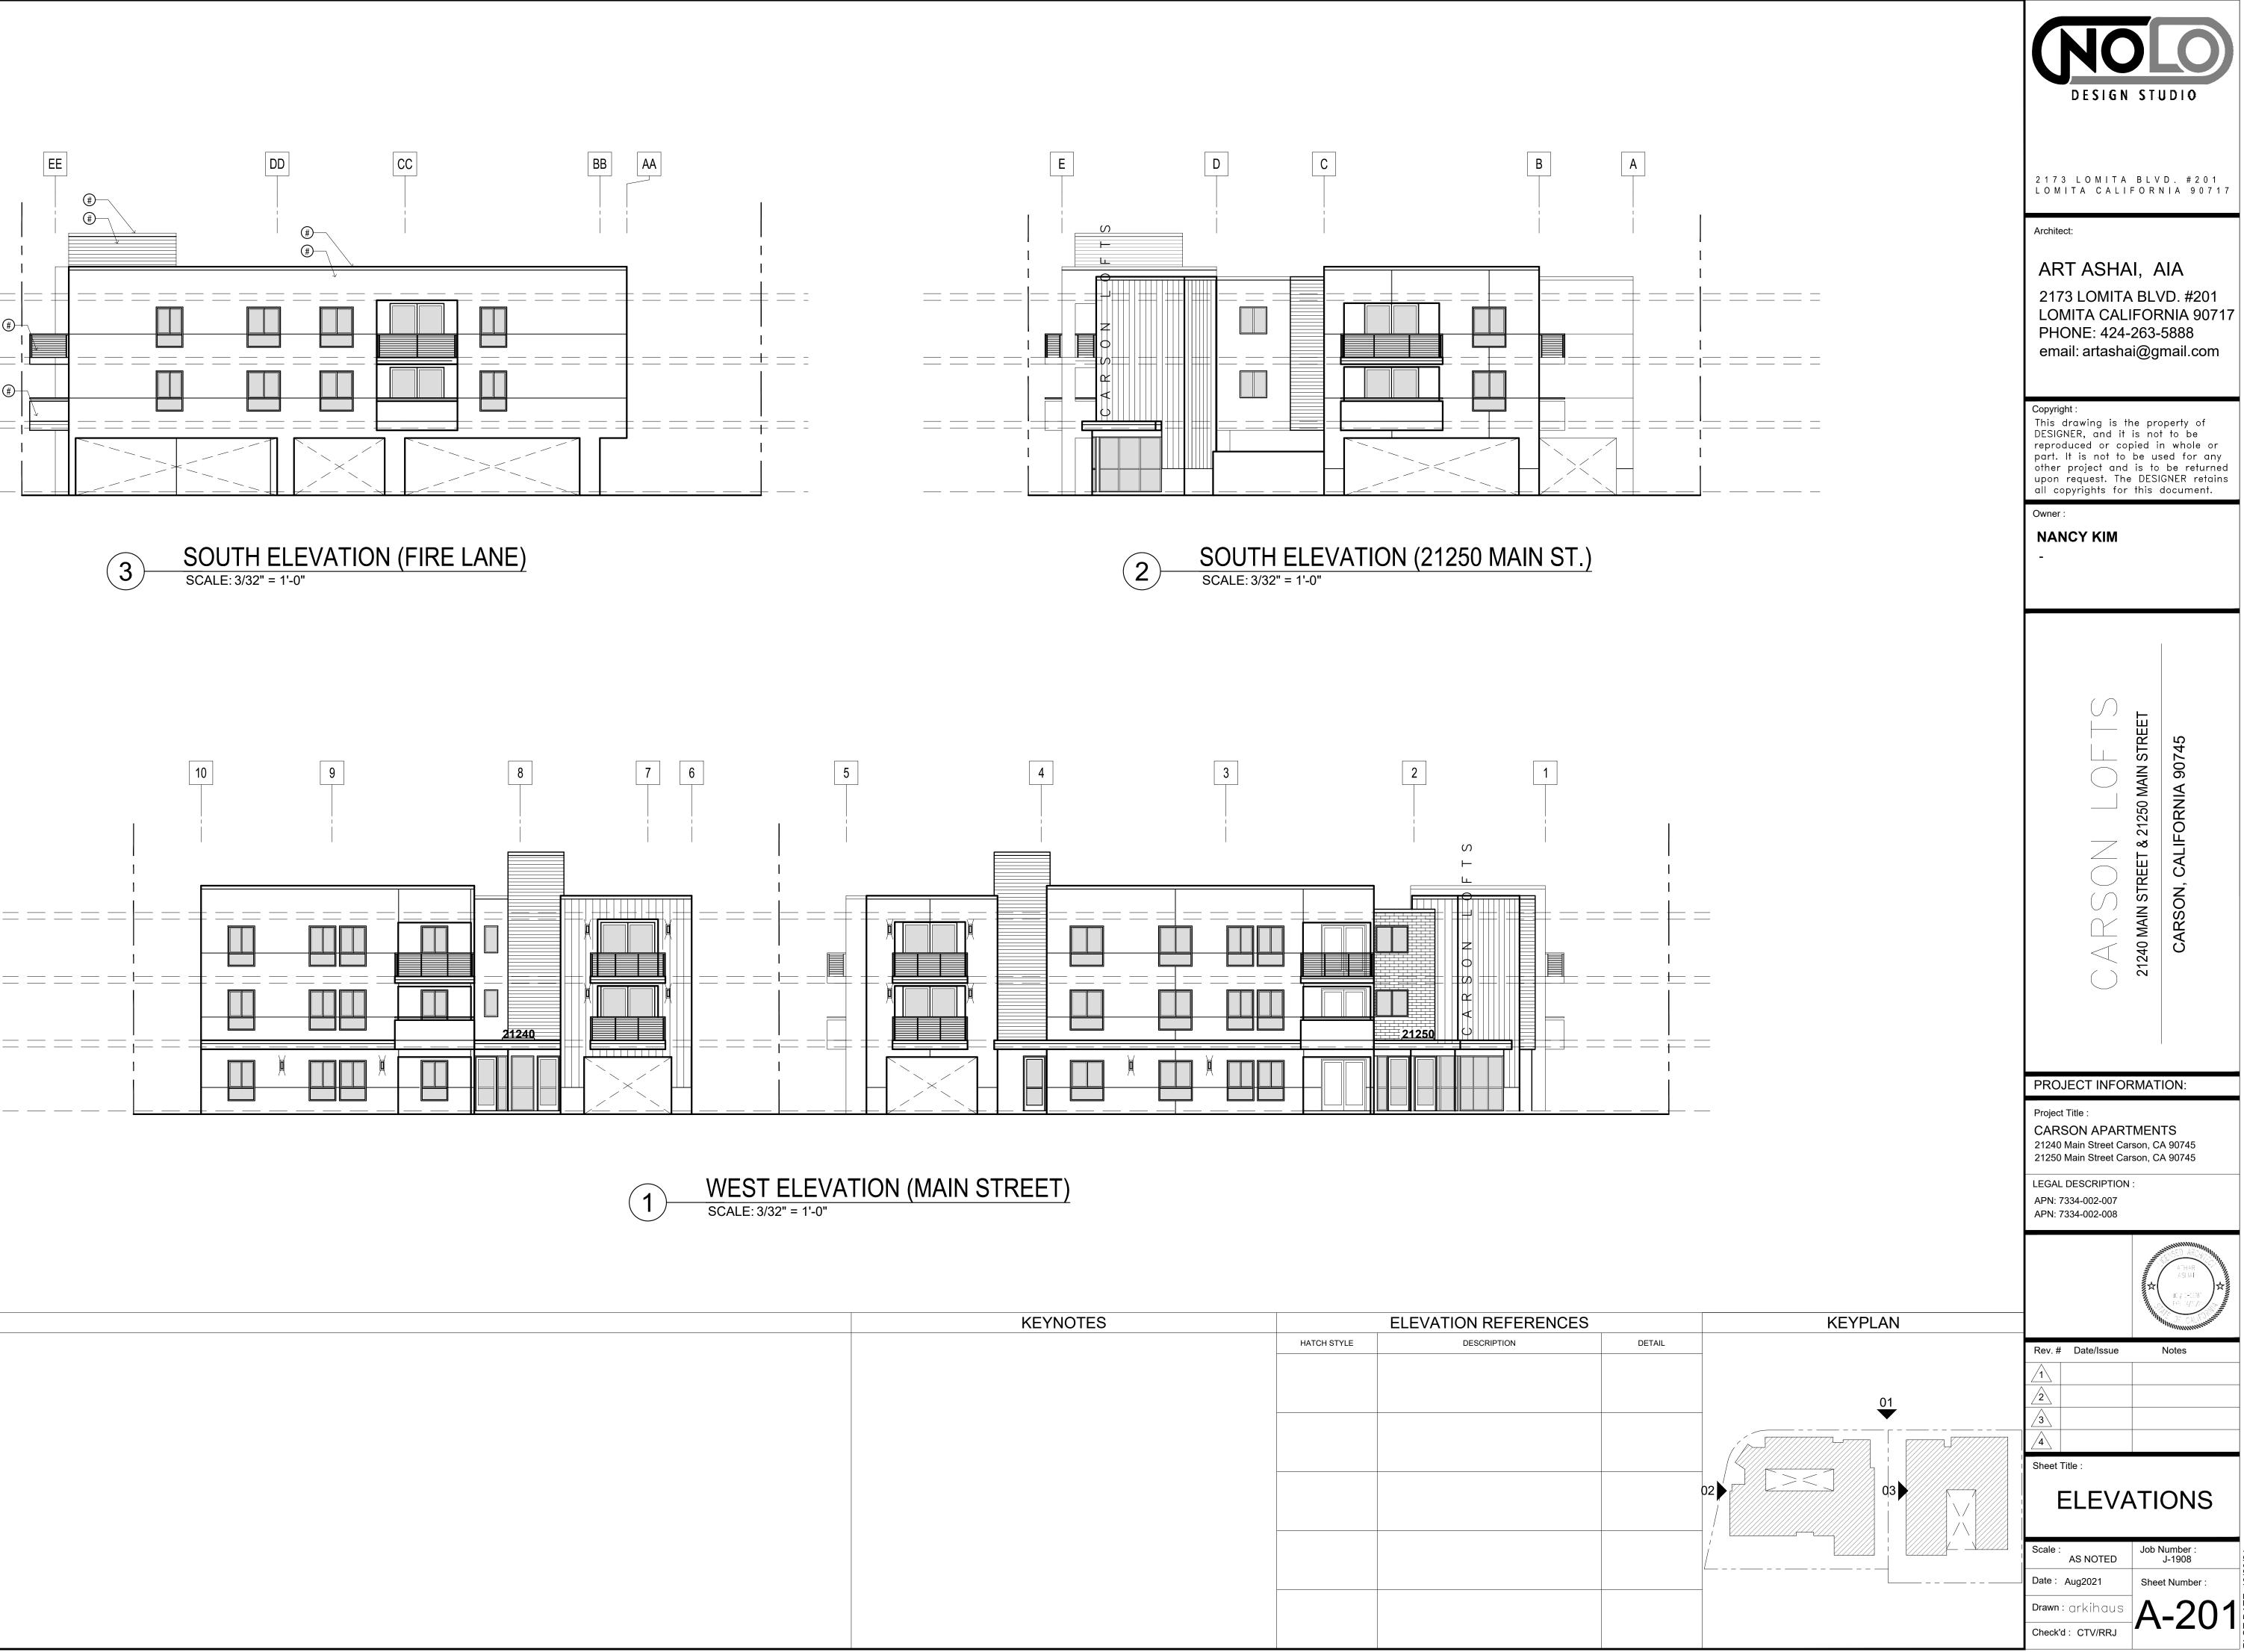



STYLE DESCRIPT

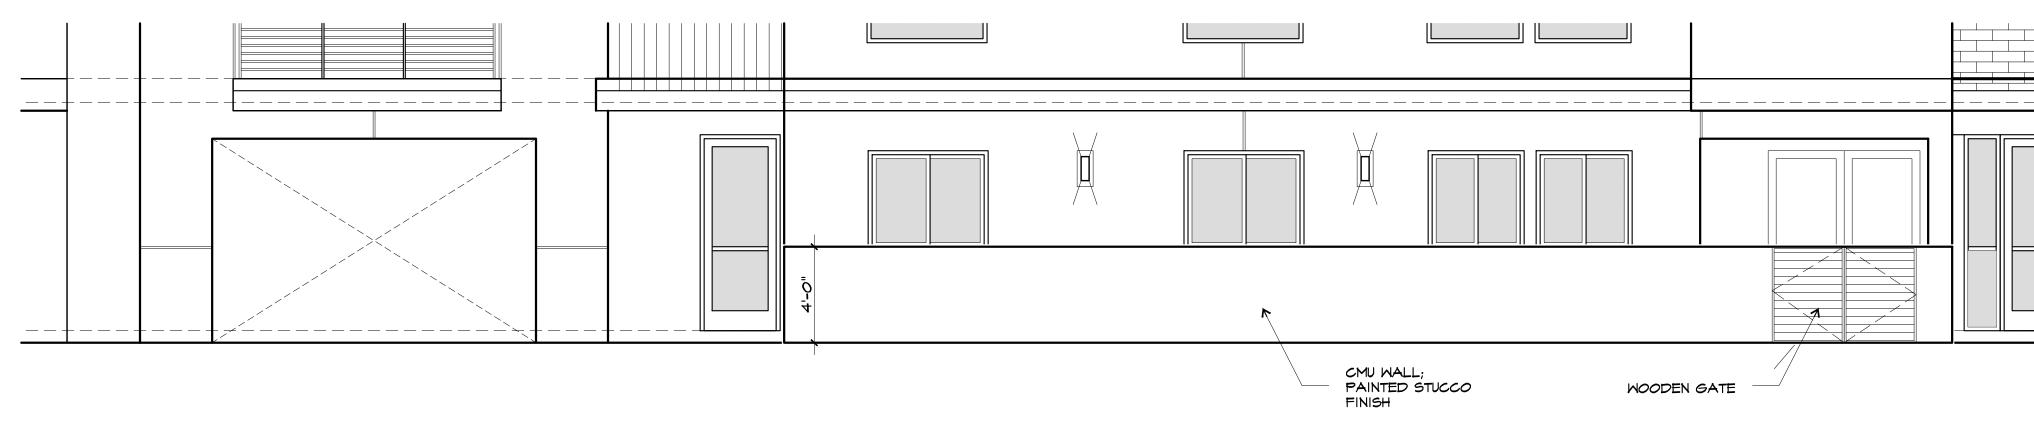


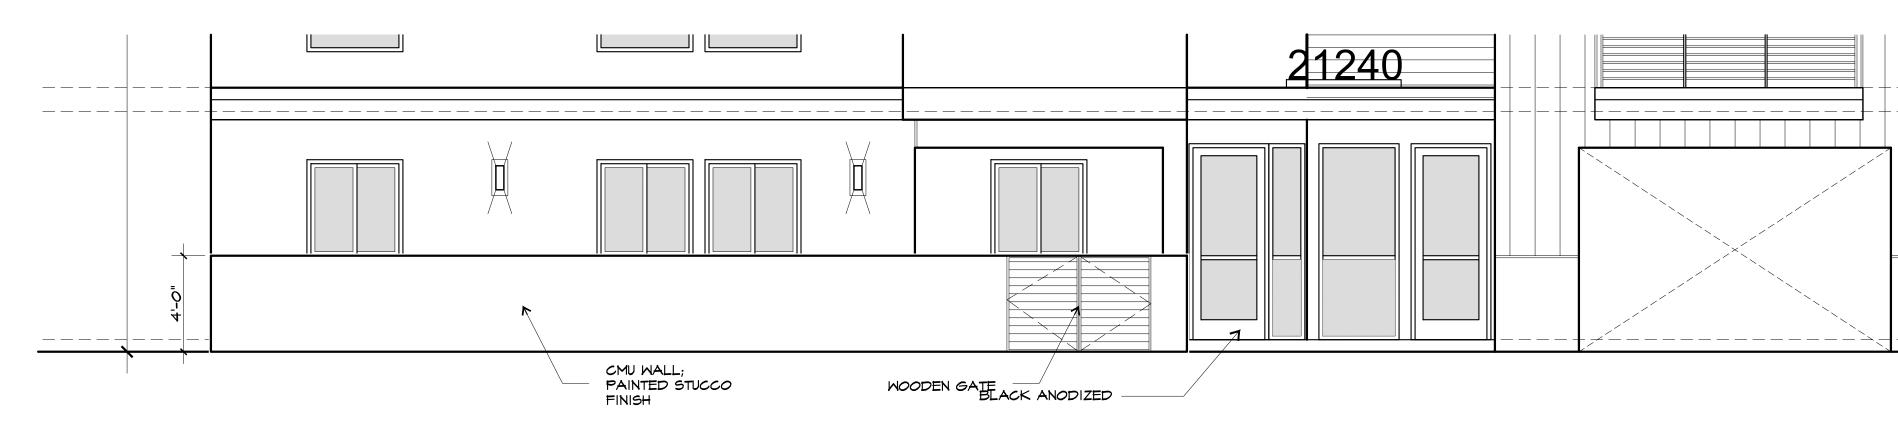




BLOW-UP ELEVATION (21250 MAIN STREET)



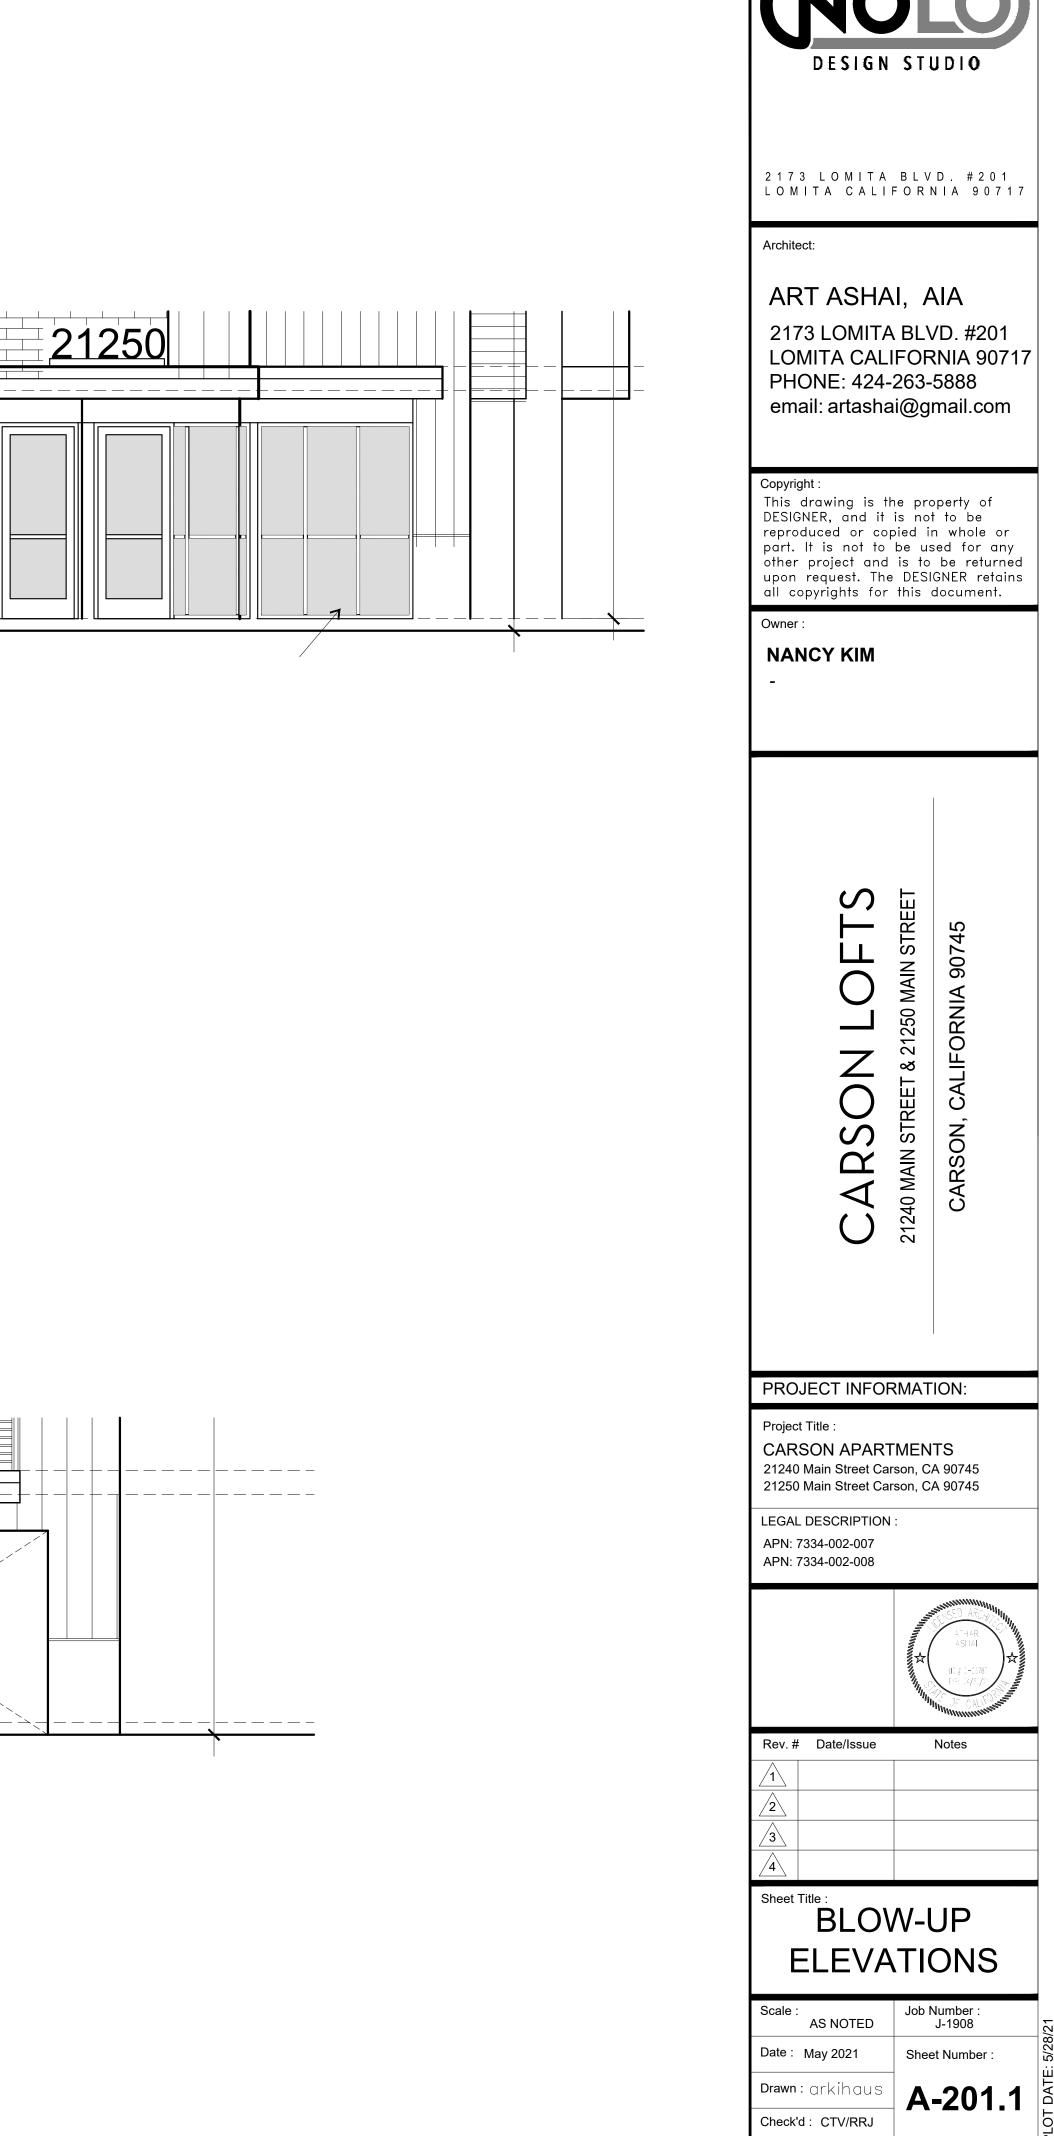

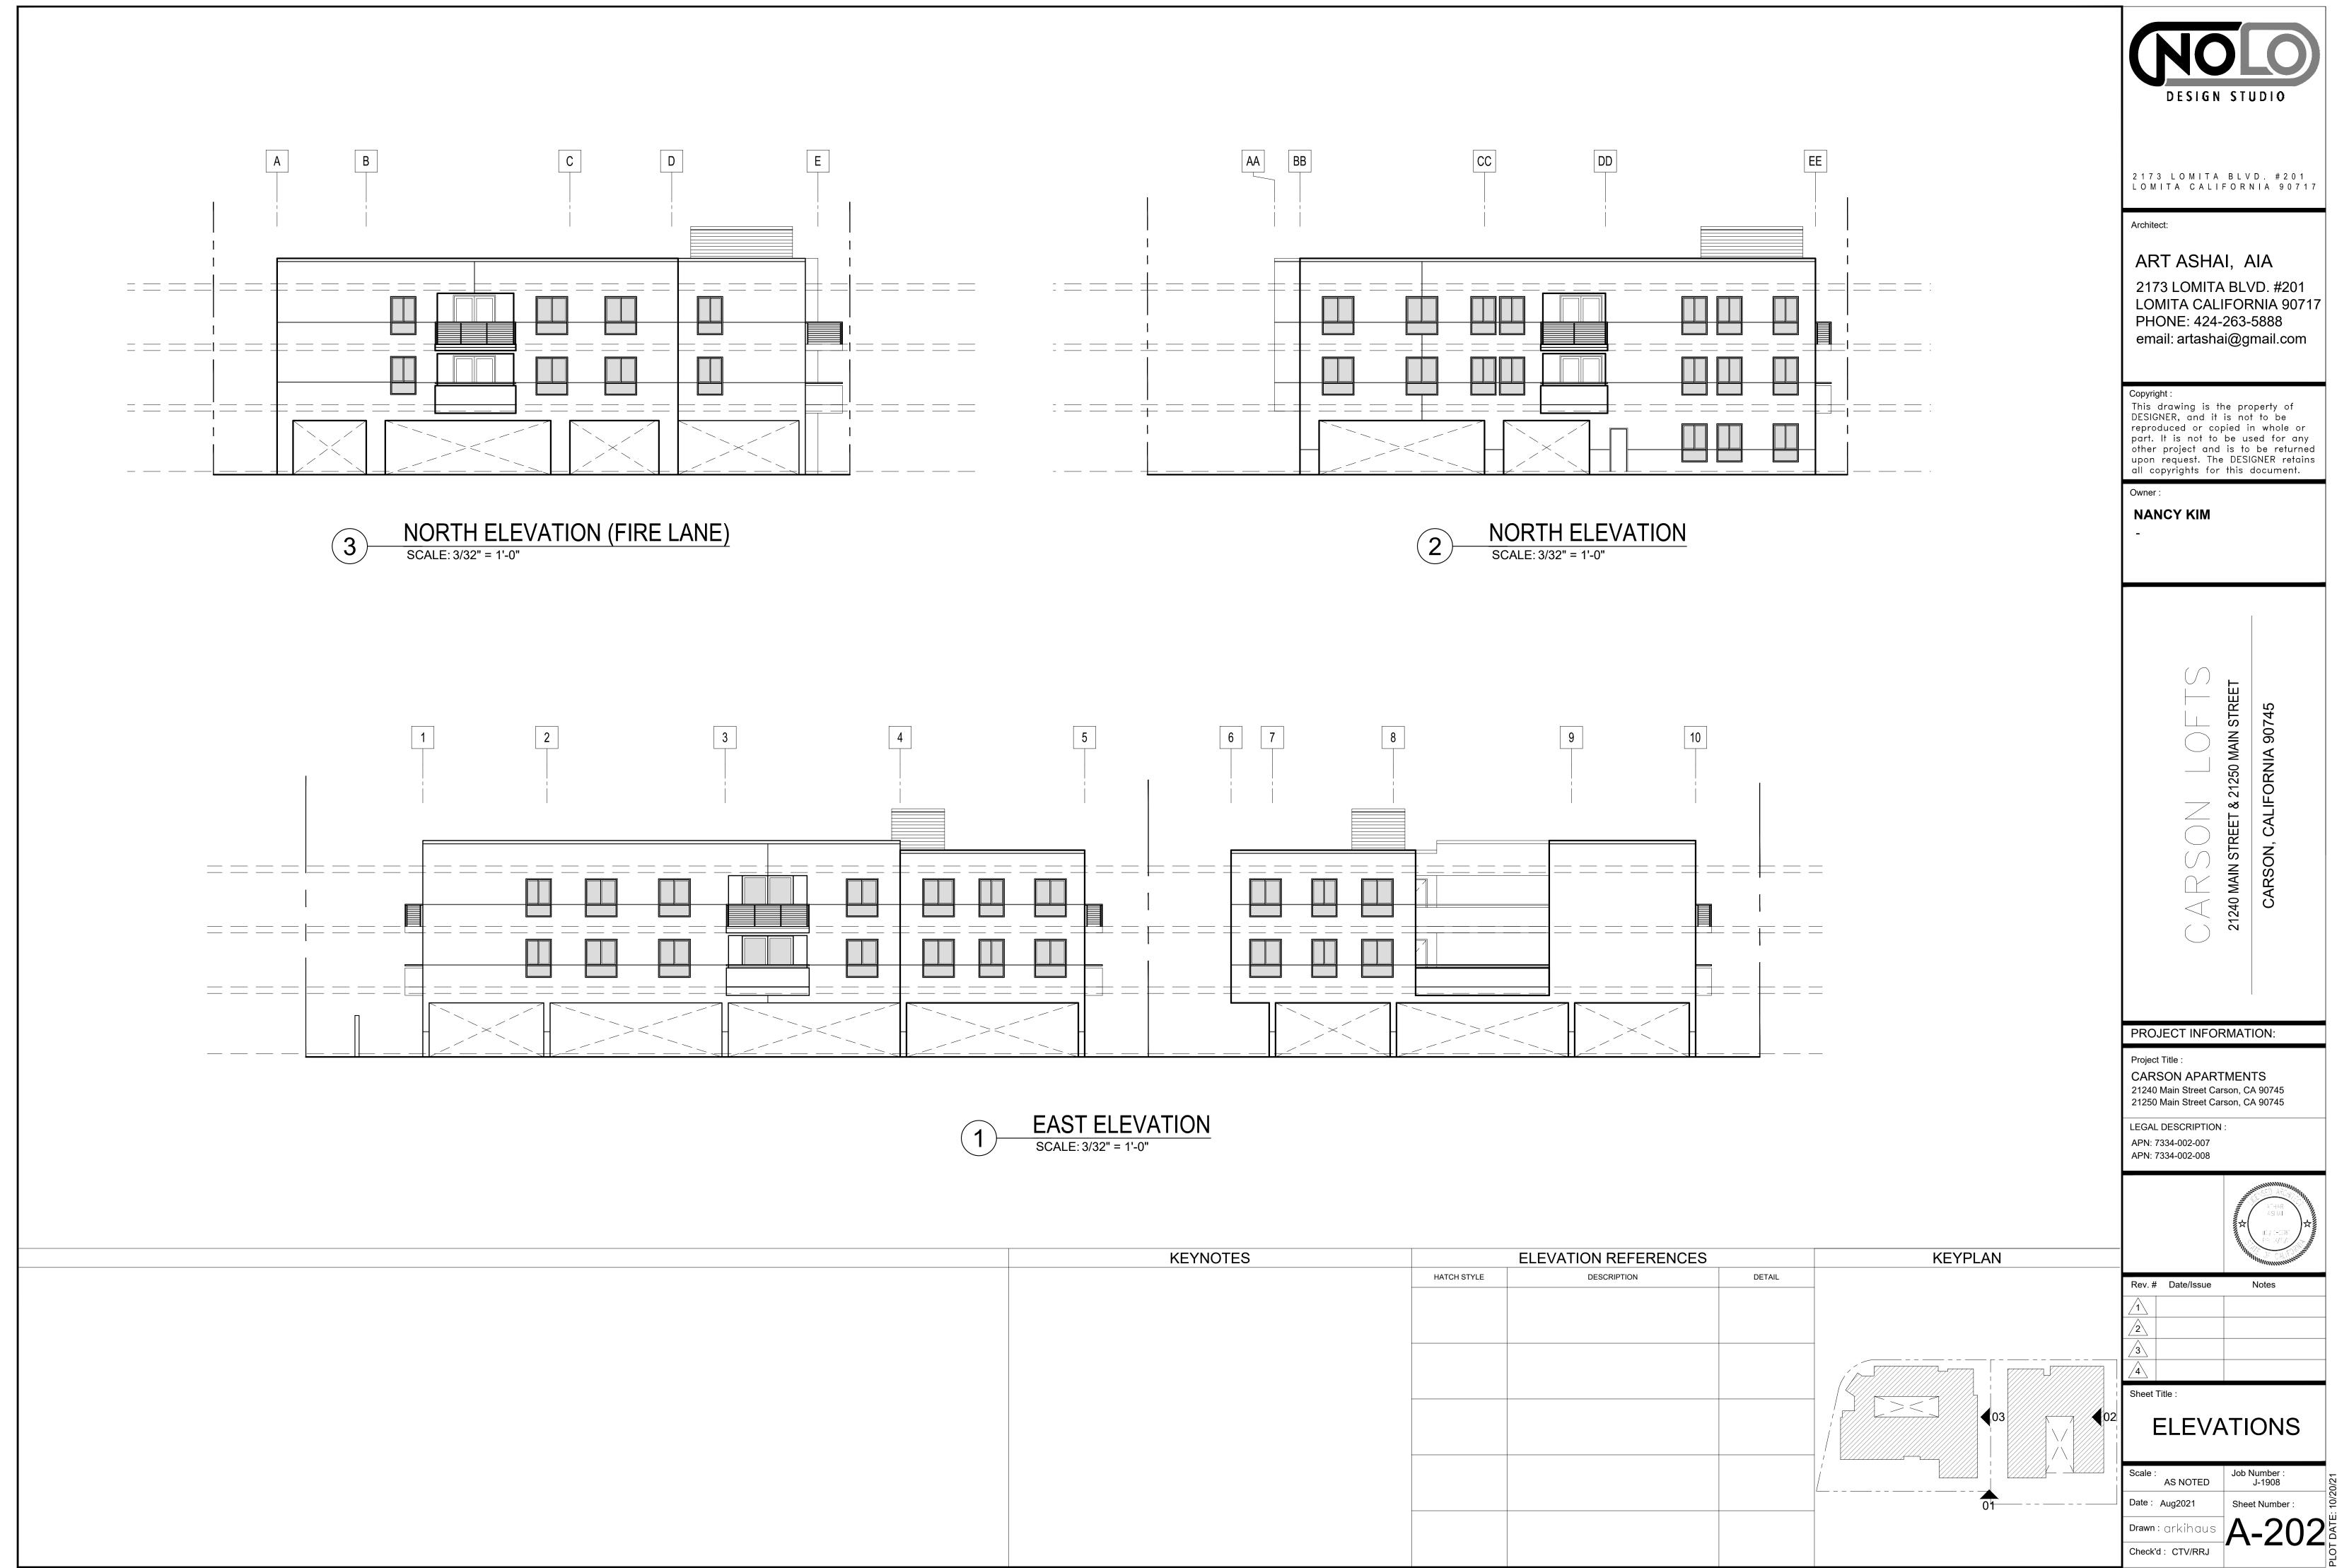



KEYNOTES	El	_EVATION RI
	HATCH STYLE	DESCRIP




SOUTHWEST RENDERING




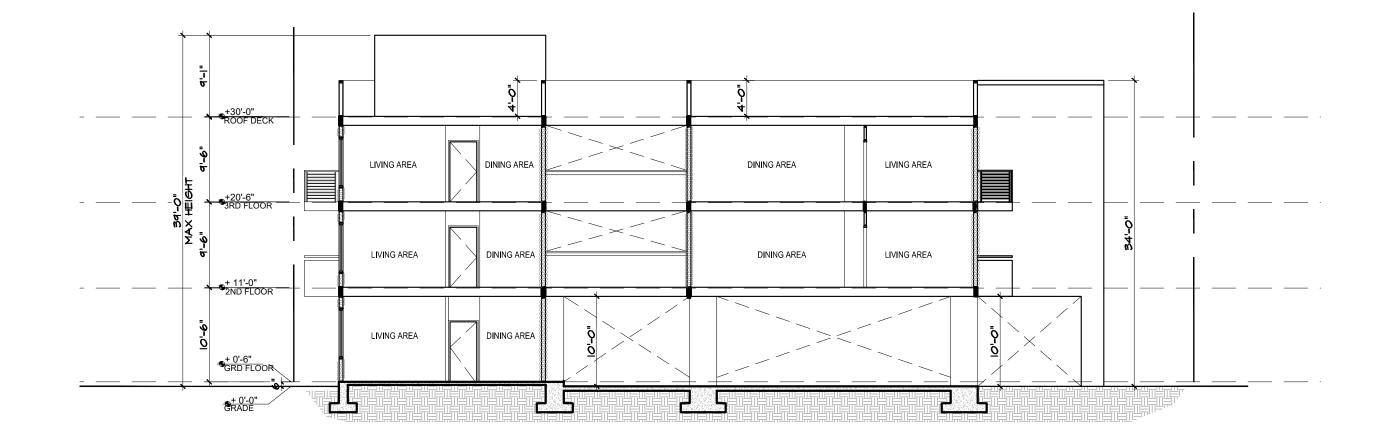


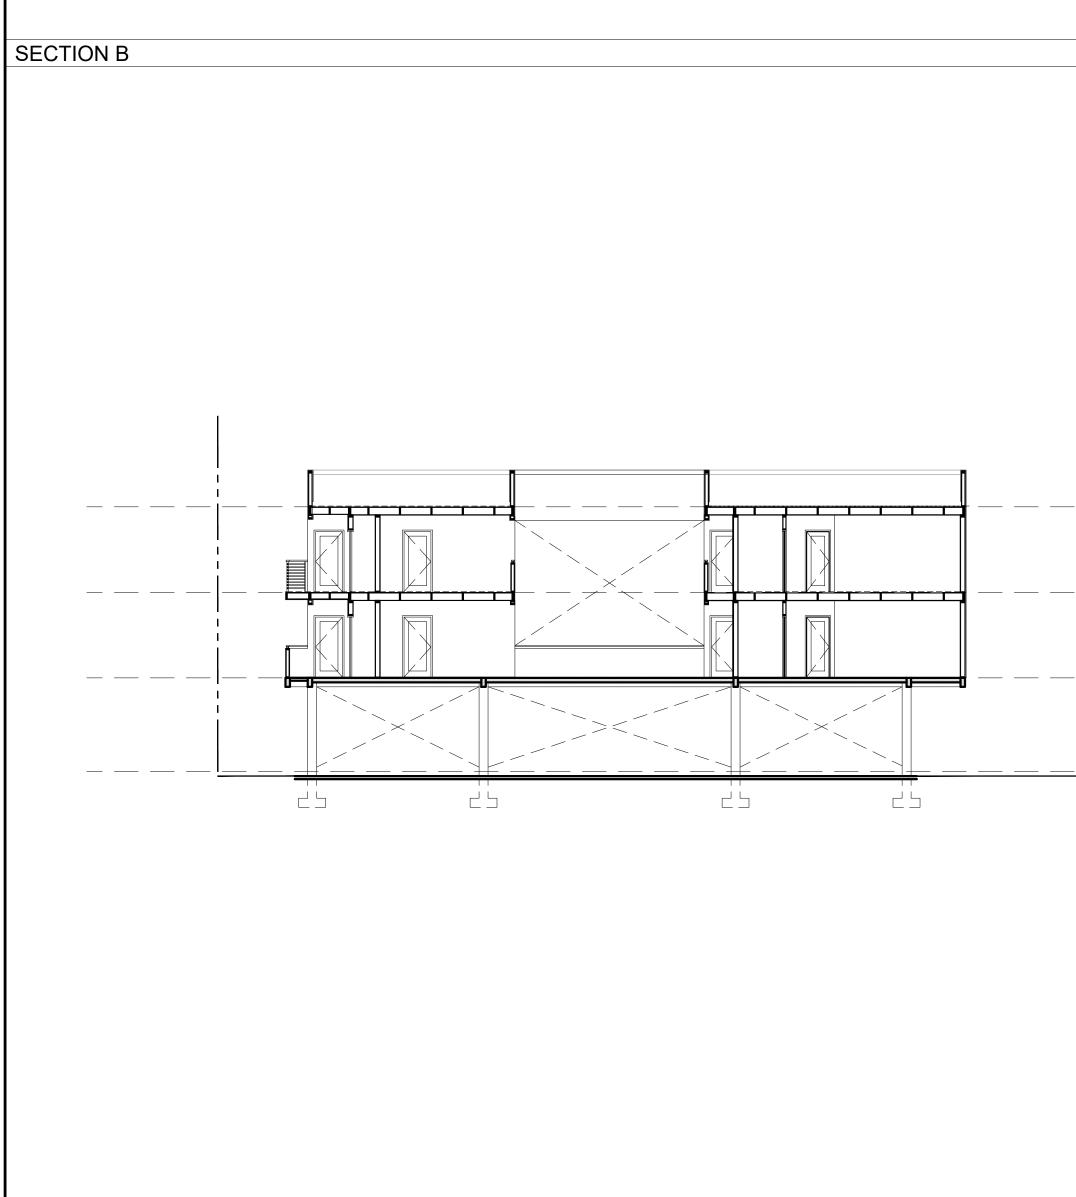

SECTION A

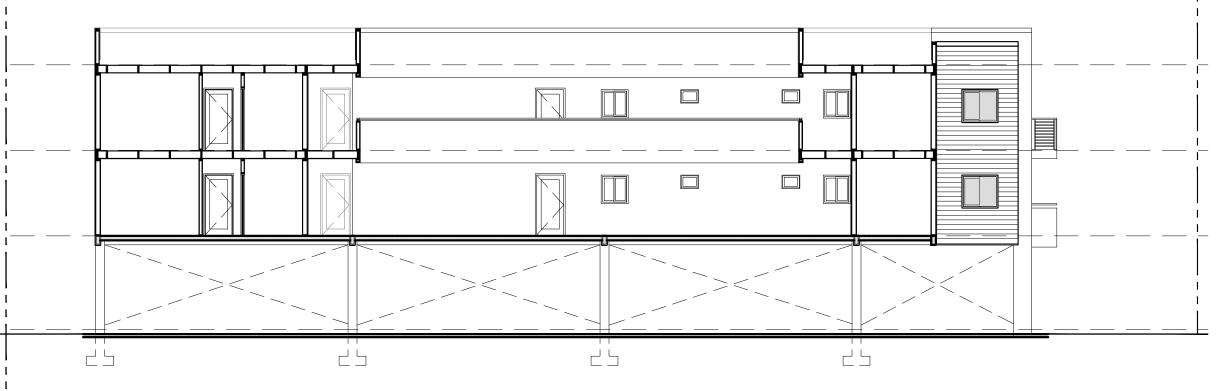

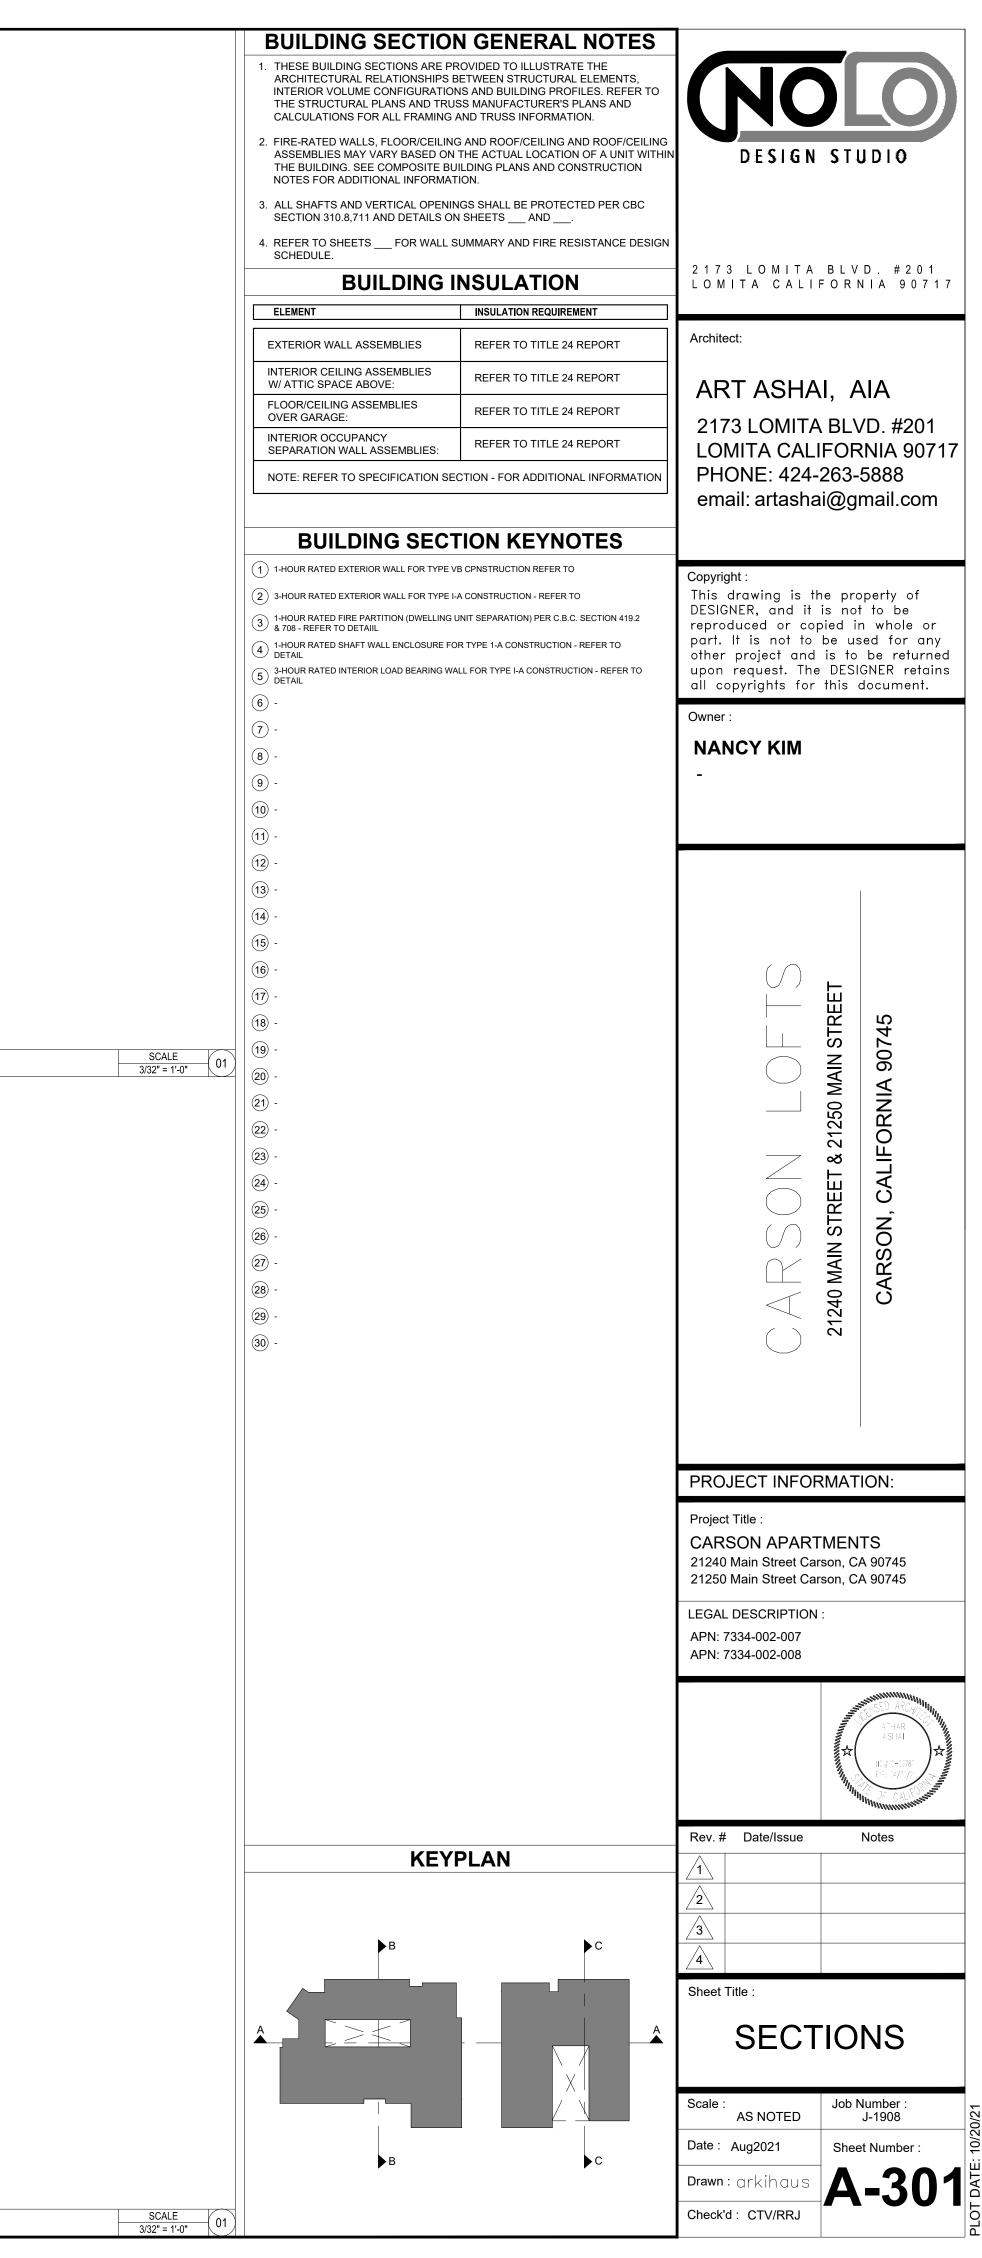

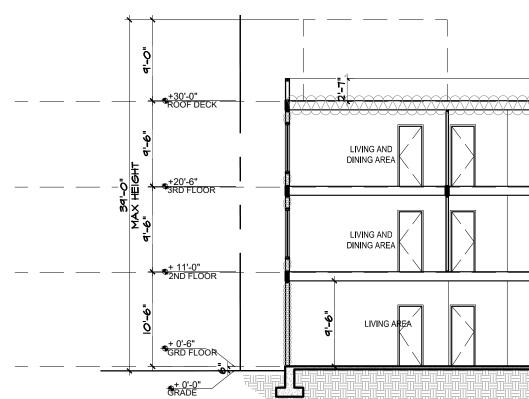

)000000)))))		\	
000000	HALLWAY			BATHROOM	winc		00000000000000000000000000000000000000		
	HALLWAY	KITCHEN	DINING AREA	BATHROOM	w.i.c	MASTER BATH	32'-6"		
									_



- 1. THESE BUILDING SECTIONS ARE PROVIDED TO ILLUSTRATE THE ARCHITECTURAL RELATIONSHIPS BETWEEN STRUCTURAL ELEMENTS, INTERIOR VOLUME CONFIGURATIONS AND BUILDING PROFILES. REFER TO THE STRUCTURAL PLANS AND TRUSS MANUFACTURER'S PLANS AND CALCULATIONS FOR ALL FRAMING AND TRUSS INFORMATION.
- 2. FIRE-RATED WALLS, FLOOR/CEILING AND ROOF/CEILING AND ROOF/CEILING ASSEMBLIES MAY VARY BASED ON THE ACTUAL LOCATION OF A UNIT WITHIN THE BUILDING. SEE COMPOSITE BUILDING PLANS AND CONSTRUCTION NOTES FOR ADDITIONAL INFORMATION.

DESIGN STUDIO

2173 LOMITA BLVD. #201

ART ASHAI, AIA

PHONE: 424-263-5888

2173 LOMITA BLVD. #201

LOMITA CALIFORNIA 90717

90745

ALIFORNIA (

CARSON, C/

Architect:


LOMITA CALIFORNIA 90717


- 3. ALL SHAFTS AND VERTICAL OPENINGS SHALL BE PROTECTED PER CBC SECTION 310.8,711 AND DETAILS ON SHEETS ____ AND ____.
- 4. REFER TO SHEETS ____ FOR WALL SUMMARY AND FIRE RESISTANCE DESIGN SCHEDULE.

BUILDING INSULATION

ELEMENT	INSULATION REQUIREMENT			
EXTERIOR WALL ASSEMBLIES	REFER TO TITLE 24 REPORT			
INTERIOR CEILING ASSEMBLIES W/ ATTIC SPACE ABOVE:	REFER TO TITLE 24 REPORT			
FLOOR/CEILING ASSEMBLIES OVER GARAGE:	REFER TO TITLE 24 REPORT			
INTERIOR OCCUPANCY SEPARATION WALL ASSEMBLIES:	REFER TO TITLE 24 REPORT			
NOTE: REFER TO SPECIFICATION SECTION - FOR ADDITIONAL INFORMATION				

email: artashai@gmail.com **BUILDING SECTION KEYNOTES** (1) 1-HOUR RATED EXTERIOR WALL FOR TYPE VB CPNSTRUCTION REFER TO Copyright : This drawing is the property of DESIGNER, and it is not to be (2) 3-HOUR RATED EXTERIOR WALL FOR TYPE I-A CONSTRUCTION - REFER TO 3 1-hour rated fire partition (dwelling unit separation) per c.b.c. Section 419.2 & 708 - Refer to detail reproduced or copied in whole or part. It is not to be used for any 4 1-HOUR RATED SHAFT WALL ENCLOSURE FOR TYPE 1-A CONSTRUCTION - REFER TO DETAIL other project and is to be returned 5 3-HOUR RATED INTERIOR LOAD BEARING WALL FOR TYPE I-A CONSTRUCTION - REFER TO DETAIL upon request. The DESIGNER retains all copyrights for this document. Owner : NANCY KIM ()) MAIN STREET _____ \frown & 21250 | _____ ____ 21240 MAIN STREET \bigcirc () \triangleleft \bigcirc PROJECT INFORMATION: Project Title : CARSON APARTMENTS 21240 Main Street Carson, CA 90745 21250 Main Street Carson, CA 90745 LEGAL DESCRIPTION : APN: 7334-002-007 APN: 7334-002-008 Rev. # Date/Issue Notes KEYPLAN C /4\ Sheet Title :

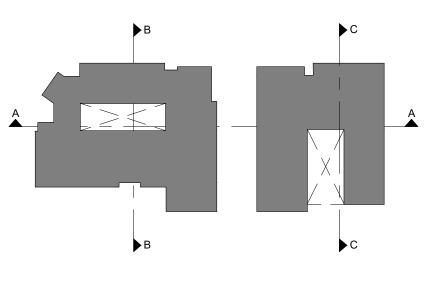

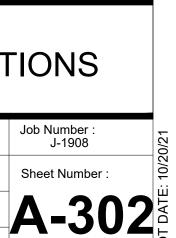

SECTIONS

Scale :

Date : Aug2021

Drawn:arkihaus

Check'd : CTV/RRJ

AS NOTED

Job Number : J-1908

Sheet Number :

GENERAL NOTES:

- ALL GRADING AND CONSTRUCTION SHALL CONFORM TO APPENDIX CHAPTER 33 AND CHAPTER 71 (LATEST EDITION) OF THE LOS ANGELES COUNTY BUILDING CODE UNLESS SPECIFICALLY NOTED ON THESE PLANS.
- ANY MODIFICATIONS OF OR CHANGES TO APPROVED GRADING PLANS MUST BE APPROVED BY THE BUILDING OFFICIAL

NO GRADING SHALL BE STARTED WITHOUT FIRST NOTIFYING THE BUILDING OFFICIAL. A PRE-GRADING MEETING AT THE SITE IS REQUIRED BEFORE THE START OF THE GRADING WITH THE FOLLOWING PEOPLE PRESENT: OWNER, GRADING CONTRACTOR, DESIGN CIVIL ENGINEER, SOILS ENGINEER, GEOLOGIST, COUNTY GRADING INSPECTOR(S) OR THEIR REPRESENTATIVES, AND WHEN REQUIRED THE ARCHEOLOGIST OR OTHER JURISDICTIONAL AGENCIES. PERMITTE OR HIS AGENT ARE RESPONSIBLE FOR ARRANGING PRE-GRADE MEETING AND MUST NOTIFY THE BUILDING OFFICIAL AT LEAST TWO BUSINESS DAYS PRIOR TO PROPOSED PRE-GRADE MEETING.

- APPROVAL OF THESE PLANS REFLECT SOLELY THE REVIEW OF PLANS IN ACCORDANCE WITH THE LOS ANGELES COUNTY BUILDING CODE AND DOES NOT REFLECT ANY POSITION BY THE COUNTY OF LOS ANGELES OR THE DEPARTMENT OF PUBLIC WORKS REGARDING THE STATUS OF ANY TITLE ISSUES RELATING TO THE LAND ON WHICH THE IMPROVEMENTS MAY BE CONSTRUCTED ANY DISPUTES RELATING TO TITLE ARE SOLELY A PRIVATE MATTER NOT INVOLVING THE COUNTY OF LOS ANGELES OR THE DEPARTMENT OF PUBLIC WORKS.
- ALL GRADING AND CONSTRUCTION ACTIVITIES SHALL COMPLY WITH LOS ANGELES COUNTY CODE, TITLE 12, SECTION 2.12.030 THAT CONTROLS AND RESTRICTS NOISE FROM THE USE OF CONSTRUCTION AND GRADING EQUIPMENT FROM THE HOURS OF 8:00 PM TO 6:30 AM, AND ON SUNDAYS AND HOLIDAYS. (MORE RESTRICTIVE CONSTRUCTION ACTIVITY TIMES MAY GOVERN, AS REQUIRED BY THE DEPARTMENT OF REGIONAL PLANNING AND SHOULD BE SHOWN ON THE GRADING PLANS WHEN APPLICABLE.)
- CALIFORNIA PUBLIC RESOURCES CODE (SECTION 5097.98) AND HEALTH AND SAFETY CODE (SECTION 7050.5) ADDRESS THE DISCOVERY AND DISPOSITION OF HUMAN REMAINS. IN THE EVENT OF DISCOVERY OR RECOGNITION OF ANY HUMAN REMAINS IN ANY LOCATION OTHER THAN A DEDICATED CEMETERY, THE LAW REQUIRES THAT GRADING IMMEDIATELY STOPS AND NO FURTHER EXCAVATION OR DISTURBANCE OF THE SITE, OR ANY NEARBY AREA WHERE HUMAN REMAINS MAY BE LOCATED, OCCUR UNTIL THE FOLLOWING HAS BEEN MEASURES HAVE BEEN TAKEN:

a. THE COUNTY CORONER HAS BEEN INFORMED AND HAS DETERMINED THAT NO INVESTIGATION OF THE CAUSE OF DEATH IS REQUIRED, AND

b. IF THE REMAINS ARE OF NATIVE AMERICAN ORIGIN, THE DESCENDANTS FROM THE DECEASED NATIVE AMERICANS HAVE MADE A RECOMMENDATION FOR THE MEANS OF TREATING OR DISPOSING, WITH APPROPRIATE DIGNITY. OF THE HUMAN REMAINS AND ANY ASSOCIATED GRAVE GOODS.

- THE LOCATION AND PROTECTION OF ALL UTILITIES IS THE RESPONSIBILITY OF THE PERMITTEE.
- ALL EXPORT OF MATERIAL FROM THE SITE MUST GO TO A PERMITTED SITE APPROVED BY THE BUILDING OFFICIAL OR A LEGAL DUMPSITE. RECEIPTS FOR ACCEPTANCE OF EXCESS MATERIAL BY A DUMPSITE ARE REQUIRED AND MUST BE PROVIDED TO THE BUILDING OFFICIAL UPON REQUEST.
- A COPY OF THE GRADING PERMIT AND APPROVED GRADING PLANS MUST BE IN THE POSSESSION OF A RESPONSIBLE PERSON AND AVAILABLE AT THE SITE AT ALL TIMES
- 10. SITE BOUNDARIES, EASEMENTS, DRAINAGE DEVICES, RESTRICTED USE AREAS SHALL BE LOCATED PER CONSTRUCTION STAKING BY FIELD ENGINEER OR LICENSED SURVEYOR. PRIOR TO GRADING, AS REQUESTED BY THE BUILDING OFFICIAL, ALL PROPERTY LINES, EASEMENTS, AND RESTRICTED USE AREAS SHALL BE STAKED.
- 11. NO GRADING OR CONSTRUCTION SHALL OCCUR WITHIN THE PROTECTED ZONE OF ANY OAK TREE AS REQUIRED PER TITLE CHAPTER 22.56 OF THE LOS ANGELES COUNTY ZONING CODE. THE PROTECTED ZONE SHALL MEAN THAT AREA WITHIN THE DRIP LINE OF AN OAK TREE EXTENDING THERE FROM A POINT AT LEAST FIVE FEET OUTSIDE THE DRIP LINE, OR 15 FEET FROM THE TRUNK(S) OF A TREE, WHICHEVER IS GREATER.
- 12. THE STANDARD RETAINING WALL DETAILS SHOWN ON THE GRADING PLANS ARE FOR REFERENCE ONLY. STANDARD RETAINING WALLS ARE NOT CHECKED, PERMITTED, OR INSPECTED PER THE GRADING PERMIT. A SEPARATE RETAINING WALL PERMIT IS REQUIRED FOR ALL STANDARD RETAINING WALLS.

NOTE: THIS NOTE ONLY APPLIES TO STANDARD RETAINING WALLS. GEOGRID FABRIC AND SEGMENTAL RETAINING WALLS DO NOT REQUIRE A SEPARATE RETAINING WALL PERMIT. DETAILS AND CONSTRUCTION NOTES FOR ALL GEOGRID WALLS MUST BE ON THE GRADING PLAN.

- 13. A PREVENTIVE PROGRAM TO PROTECT THE SLOPES FROM POTENTIAL DAMAGE FROM BURROWING RODENTS IS REQUIRED PER SECTION 3307.6 OF THE LOS ANGELES COUNTY BUILDING CODE. OWNER IS TO INSPECT SLOPES PERIODICALLY FOR EVIDENCE OF BURROWING RODENTS AND A FIRST EVIDENCE OF THEIR EXISTENCE SHALL EMPLOY AN EXTERMINATOR FOR THEIR REMOVAL.
- 14. IF GRADING AUTHORIZED BY THIS PLAN IS TO EXTEND THROUGH THE RAINY SEASON, NOVEMBER 1 THROUGH APRIL 15 OF THE FOLLOWING YEAR, SEPARATE UPDATED PLANS FOR EROSION CONTROL MUST BE SUBMITTED PRIOR TO OCTOBER PER SECTION 3319.3 OF THE LOS ANGELES COUNTY BUILDING CODE.
- 15. TRANSFER OF RESPONSIBILITY: IF THE CIVIL ENGINEER, THE SOILS ENGINEER, OR THE ENGINEERING GEOLOGIST OF RECORD IS CHANGED DURING GRADING, THE WORK SHALL BE STOPPED UNTIL THE REPLACEMENT HAS AGREED IN WRITING TO ACCEPT THEIR RESPONSIBILITY WITHIN THE AREA OF TECHNICAL COMPETENCE FOR APPROVAL UPON COMPLETION OF THE WORK. IT SHALL BE THE DUTY OF THE PERMITTEE TO NOTIFY THE BUILDING OFFICIAL IN WRITING OF SUCH CHANGE PRIOR TO THE RECOMMENCEMENT OF SUCH GRADING.

INSPECTION NOTES:

16. THE PERMITTEE OR HIS AGENT SHALL NOTIFY THE BUILDING OFFICIAL AT LEAST ONE WORKING DAY IN ADVANCE OF REQUIRED INSPECTIONS AT FOLLOWING STAGES OF THE WORK. (SECTION 3317 OF THE BUILDING CODE.)

(a) INITIAL. WHEN THE SITE HAS BEEN CLEARED OF VEGETATION AND UNAPPROVED FILL HAS BEEN SCARIFIED, BENCHED OR OTHERWISE PREPARED FOR FILL. FILL SHALL NOT BE PLACED PRIOR TO THIS INSPECTION. NOTE: PRIOR TO ANY CONSTRUCTION ACTIVITIES, INCLUDING GRADING. ALL STORM WATER POLLUTION PREVENTION MEASURES INCLUDING EROSION CONTROL DEVICES WHICH CONTAIN SEDIMENTS MUST BE INSTALLED.

(b) ROUGH. WHEN APPROXIMATE FINAL ELEVATIONS HAVE BEEN ESTABLISHED: DRAINAGE TERRACES, SWALES AND BERMS INSTALLED AT THE TOP OF THE SLOPE; AND THE STATEMENTS REQUIRED IN THIS SECTION HAVE BEEN RECEIVED.

(c) <u>FINAL.</u> WHEN GRADING HAS BEEN COMPLETED; ALL DRAINAGE DEVICES INSTALLED; SLOPE PLANTING ESTABLISHED, IRRIGATION SYSTEMS INSTALLED AND THE AS-BUILT PLANS, REQUIRED STATEMENTS, AND REPORTS HAVE BEEN SUBMITTED AND APPROVED.

- COUTY BUILDING CODE.

DRAINAGE NOTES:

- PRIVATE DRAIN PD NO.

NO.

STORMWATER POLLUTION PLAN NOTES

- THE PROJECT SITE AT ALL TIMES.
- COURSES OR WIND.
- THE DRAINAGE SYSTEM.

PRINT NAME (OWNER OR AUTHORIZED AGENT OF THE OWNER)

SIGNATURE

THE FOLLOWING BMPs AS OUTLINED IN, BUT NOT LIMITED TO, THE BEST MANAGEMENT PRACTICE HANDBOOK, CALIFORNIA STORMWATER QUALITY TASK FORCE, SACRAMENTO, CALIFORNIA 1993, OR THE LATEST REVISED EDITION. MAY APPLY DURING THE CONSTRUCTION OF THIS PROJECT (ADDITIONAL MEASURES MAY BE REQUIRED IF DEEMED APPROPRIATE BY COUNTY INSPECTORS)

CA001-DEWATERING OPERATIONS ESC20-GEOTEXTILES AND MATS CA002-PAVING OPERATIONS ESC21-DUST CONTROLS CA003-STRUCTURE CONSTRUCTION AND PAINTING ESC22-TEMPORARY STREAM CROSSING CA010-MATERIAL DELIVERY AND STORAGE ESC23-CONSTRUCTION ROAD STABILIZATION CA011-MATERIAL USE ESC24-STABILIZED CONSTRUCTION ENTRANCE CA012-SPILL PREVENTION AND CONTROL ESC30-EARTH DIKE ESC31-TEMPORARY DRAINS AND SWALES CA020-SOLID WASTE MANAGEMENT CA021-HAZARDOUS WASTE MANAGEMENT ESC32-SLOPE DRAIN CA022-CONTAMINATED SOIL MANAGEMENT ESC40-OUTLET PROTECTION CA023-CONCRETE WASTE MANAGEMENT ESC41-CHECK DAMS CA030-VEHICLE AND EQUIPMENT CLEANING ESC42-SLOPE ROUGHENING/TERRACING CA031-VEHICLE AND EQUIPMENT FUELING ESC50-SILT FENCE CA032-VEHICLE AND EQUIPMENT MAINTENANCE ESC51-STRAW BALE BARRIERS CA040-EMPLOYEE/SUBCONTRACTOR TRAINING ESC52-SAND BAG BARRIERS ESC01-SCHEDULING ESC53-BRUSH OR ROCK FILTER ESC02-PRESERVATION OF EXISTING VEGETATION ESC54-STORM DRAIN INLET PROTECTION ESC10-SEEDING AND PLANTING ESC55-SEDIMENT TRAP ESC11-MULCHING ESC56-SEDIMENT BASIN

SOILS ENGINEER: GSS INC. 11823 SAUSON AVE #46 SANTA FE SPRING, CA 90670	APPROVAL RECOMMENDED BY:			DATE	PROPERTY OWNER: NANCY KIM 21240–21250 MAIN STREET CARSON, CA 90745	157
TEL: (562) 696-6062	APPROVED BY:	DATE	Δ			REGIST
	CITY OF CARSON					

10'	5'	0'	10'	20'
		GRAP	HIC SCALE	

17. IN ADDITION TO THE INSPECTION REQUIRED OF THE BUILDING OFFICIAL FOR REGULAR GRADING, REPORTS AND STATEMENTS SHALL BE SUBMITTED TO THE BUILDING OFFICIAL IN ACCORDANCE WITH SECTIONS 3317 AND 3318 OF THE LOS ANGELES COUNTY BUILDING CODE.

18. ALL GRADED SITES MUST HAVE DRAINAGE SWALES, BERMS, AND OTHER DRAINAGE DEVICES INSTALLED PRIOR TO ROUGH GRADING APPROVAL PER SECTION 3317.6 OF THE LOS ANGELES

19. THE GRADING CONTRACTOR SHALL SUBMIT THE STATEMENT TO THE GRADING INSPECTOR AS REQUIRED BY SECTION 3318.1 OF THE LOS ANGELES COUNTY BUILDING CODE AT THE COMPLETION OF ROUGH GRADING.

20. FINAL GRADING MUST BE APPROVED BEFORE OCCUPANCY OF BUILDINGS WILL BE ALLOWED PER SECTION 3318 OF THE LOS ANGELES COUNTY BUILDING CODE

21. ROOF DRAINAGE MUST BE DIVERTED FROM GRADED SLOPES.

22. PROVISIONS SHALL BE MADE FOR CONTRIBUTORY DRAINAGE AT ALL TIMES

23. ALL CONSTRUCTION AND GRADING WITHIN A STORM DRAIN EASEMENT ARE TO BE DONE PER OR MISCELLANEOUS TRANSFER DRAIN MTD

24. ALL STORM DRAIN WORK IS TO BE DONE UNDER CONTINUOUS INSPECTION BY THE FIELD ENGINEER. WEEKLY STATUS REPORTS SHALL BE SUBMITTED BY THE FIELD ENGINEER TO THE LOCAL BUILDING AND SAFETY DISTRICT OFFICE.

EVERY EFFORT SHOULD BE MADE TO ELIMINATE THE DISCHARGE OF NON-STORMWATER FROM

ERODED SEDIMENTS AND OTHER POLLUTANTS MUST BE RETAINED ON-SITE AND MAY NOT BE TRANSPORTED FROM THE SITE VIA SHEET FLOW, SWALES, AREA DRAINS, NATURAL DRAINAGE

STOCKPILES OF EARTH AND OTHER CONSTRUCTION RELATED MATERIALS MUST BE PROTECTED FROM BEING TRANSPORTED FROM THE SITE BY THE FORCES OF WIND OR WATER.

FUELS, OILS, SOLVENTS, AND OTHER TOXIC MATERIALS MUST BE STORED IN ACCORDANCE WITH THEIR LISTING AND ARE NOT TO CONTAMINATE THE SOIL AND SURFACE WATERS. ALL APPROVED STORAGE CONTAINERS ARE TO BE PROTECTED FROM THE WEATHER. SPILLS MUST BE CLEANED UP IMMEDIATELY AND DISPOSED OF IN A PROPER MANNER. SPILLS MAY NOT BE WASHED INTO

EXCESS OR WASTE CONCRETE MAY NOT BE WASHED INTO THE PUBLIC WAY OR ANY OTHER DRAINAGE SYSTEM. PROVISIONS SHALL BE MADE TO RETAIN CONCRETE WASTES ON-SITE UNTIL THEY CAN BE DISPOSED OF AS SOLID WASTE.

TRASH AND CONSTRUCTION RELATED SOLID WASTES MUST BE DEPOSITED INTO A COVERED RECEPTACLE TO PREVENT CONTAMINATION OF RAINWATER AND DISPERSAL BY WIND.

SEDIMENTS AND OTHER MATERIALS MAY NOT BE TRACKED FROM THE SITE BY VEHICLE TRAFFIC. THE CONSTRUCTION ENTRANCE ROADWAYS MUST BE STABILIZED SO AS TO INHIBIT SEDIMENTS FROM BEING DEPOSITED INTO THE PUBLIC WAY. ACCIDENTAL DEPOSITIONS MUST BE SWEPT UP IMMEDIATELY AND MAY NOT BE WASHED DOWN BY RAIN OR OTHER MEANS.

ANY SLOPES WITH DISTURBED SOILS OR DENUDED OF VEGETATION MUST BE STABILIZED SO AS TO INHIBIT EROSION BY WIND AND WATER.

AS THE PROJECT OWNER OR AUTHORIZED AGENT OF THE OWNER. I HAVE READ AND

UNDERSTAND THE REQUIREMENTS LISTED ABOVE, NECESSARY TO CONTROL STORM WATER POLLUTION FROM SEDIMENTS, EROSION, AND CONSTRUCTION MATERIALS, AND I CERTIFY THAT I WILL COMPLY WITH THESE REQUIREMENTS.

> DATE _____ (OWNER OR AUTHORIZED AGENT OF THE OWNER)

LEGEND

С.В	CATCH BASIN
C.F	CURB FACE
CONC	CONCRETE
DWY	DRIVEWAY
F.F	FINISHED FLOOR
F.G	FINISHED GRADE
F.H	FIRE HYDRANT
F.L	FLOW LINE
F.S	FINISHED SURFACE
G.B	GRADE BREAK
H.P	HIGH POINT
MAX	MAXIMUM
MIN	MINIMUM
P.L	PROPERTY LINE
PVMT	PAVEMENT
R	RADIUS
T.C	TOP OF CURB
T.C.B	TOP OF CATCH BASIN
T.W	TOP OF WALL
INV	INVERT
CL	CENTER LINE

/_/	EXISTING CONTOUR
	PROPOSED CONTOUR
(634)	EXISTING ELEVATION
634	PROPOSED ELEVATION
<u> </u>	FENCE
\rightarrow	FIRE HYDRANT
\longrightarrow	FLOW LINE
	SLOPE
pictorio or or o	CONCRETE
	PROPOSED WALL
	EXISTING WALL
	RIDGE LINE
	GRADE BREAK LINE

LEGAL DESCRIPTION

PARCEL


LOT 7 OF TRACT NO. 8018 AS PER MAP RECORDED IN BOOK 165 PAGES 30-31 OF MAPS IN THE OFFICE OF THE COUNTY RECORDER OF SAID COUNTY, AND THE WESTERLY 10 FEET OF THAT PORTION OF THE VACATED ALLEY ADJOINING SAID LOT ON THE EASTERLY LINE.

ALSO THAT TRACT NO. 8018 AS PER MAP RECORDED IN BOOK 165 PAGES 30-31 OF MAPS IN THE OFFICE OF THE COUNTY. LIVING WESTERLY OF THE SOUTHERLY PROLONGATION OF THE EASTERLY LINE OF SAID LOT.

PARCEL 2:

LOT 8 OF TRACT 8018 AS PER MAP RECORDED IN BOOK 165 PAGES 30-31 OF MAPS IN THE OFFICE OF THE COUNTY RECORDER OF SAID COUNTY.

ALSO THAT PORTION OF THE SOUTH HALF OF AN ALLEY AS SHOWN ON SAID TRACT, VACATED BY RESOLUTION NO 142 RECORDED AS INSTRUMENT NO. 29088 ON OCT. 21, 1968 OFFICIAL RECORDS OF SAID COUNTY, LYING WESTERLY OF THE NORTHERLY PROLONGATION OF THE EASTERLY LINE OF SAID LOT.

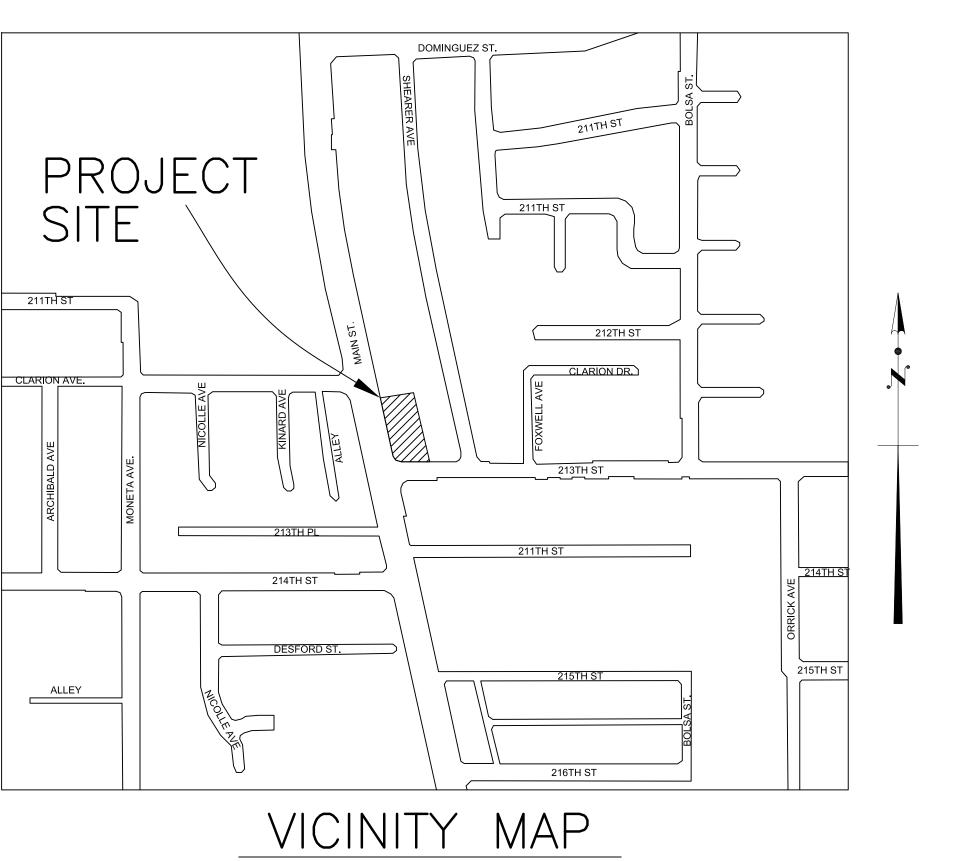

NOT TO SCALE

CONSTRUCTION NOTES

- INSTALL 12"X12" GRATE DRAIN(ALHABRA FDRY. STD. 2011)
- (2) 4" DIA. PVC PIPE(SCHEDULE 40)
- (3) 6" CONC. ON COMPACTED PAVEMENT
- (4) 6' HIGH CONC BLOCK WALL PER APPROVED ARCHITECTURAL PLANS.
- (5) LANDSCAPE AREA PER APPROVED LANDSCAPE PLANS.
- (6) CONST. 4" DIA CAST IRON PRESSURED PIPE
- (7) DUAL PUMPING SYSTEM PER SEPARATE PERMIT
- (8) CONST. CONC DRIVEWAY PER APWA STD PLAN


ADDITIONAL NOTES

- I. THIS GRADING PLAN WAS PREPARED FOR THE EXCLUSIVE USE OF JEFF DAUN. IT SHALL NOT BE TRANSFERRED TO OR USED BY A THIRD PARTY WITHOUT THE PRIOR WRITTEN CONSENT OF THIS OFFICE.
- II. THE GEOTECHNICAL REPORT PREPARED BY NORCAL ENGINEERING. DATED JANUARY 25, 2005 (PROJECT NO. 11869-05) IS PART OF THIS GRADING PLAN AND THE CONTRACTOR SHALL COMPLY WITH ALL ITS RECOMMENDATIONS AND REQUIREMENTS.
- III. ALL DRAINAGE PIPES TO BE PVC SCHEDULE 40 MINIMUM OR EQUIVALENT WITH 4" MINIMUM DIAMETER
- IV. RETAINING WALLS REQUIRES SEPARATE PERMIT.
- V. CURB DRIAN REQUIRES SEPARATE PERMIT FROM ENGINEERING DEPT. VI. THE CONTRACTOR SHALL COMPLY WITH CITY OF CARSON ORDINANCE RELATED TO STANDARD URBAN STORMWATER MITIGATION PLAN (STATE OF CALIFORNIA MANDATED) AND COMPLY WITH NPDES PERMIT REQUIREMENTS.
- VII. THE SOILS ENGINEER OF RECORDS SHALL INSPECT AND APPROVE THE FOUNDATION EXCAVATIONS BEFORE STEEL OR CONCRETE IS PLACED.
- VIII. FOR DETAIL OF THE FOOTING AND FOUNDATION, REFER TO THE APPROVED STRUCTURAL AND ARCHITECTURAL DRAWINGS.
- IX. VOLUME OF CUT AND FILL
- CUT : 1,500 C.Y. FILL : <u>1,500</u> C.Y.



OVER EX :		CUP		
DHS & ASSOCIATES, INC. 275 CENTENNIAL WAY, #205	GRADI FOR		DRAINAG HED TOW	E PLAN NHOUSES
ディージェンジン TUSTIN, CA 92780-3709	SCALE: 1"=10'			DRAWN BY: S.N.
$\begin{pmatrix} C044100 \\ EXP. 06-30-23 \end{pmatrix} = \begin{pmatrix} 714 \\ B \\ $	DATE: 10/08/2021			REVISED:
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TOF CALIFORN H. STEVE NAZEMI DATE	SHEET	1 OF	2	JOB NO.

GPC NO. XXXXXXXXX

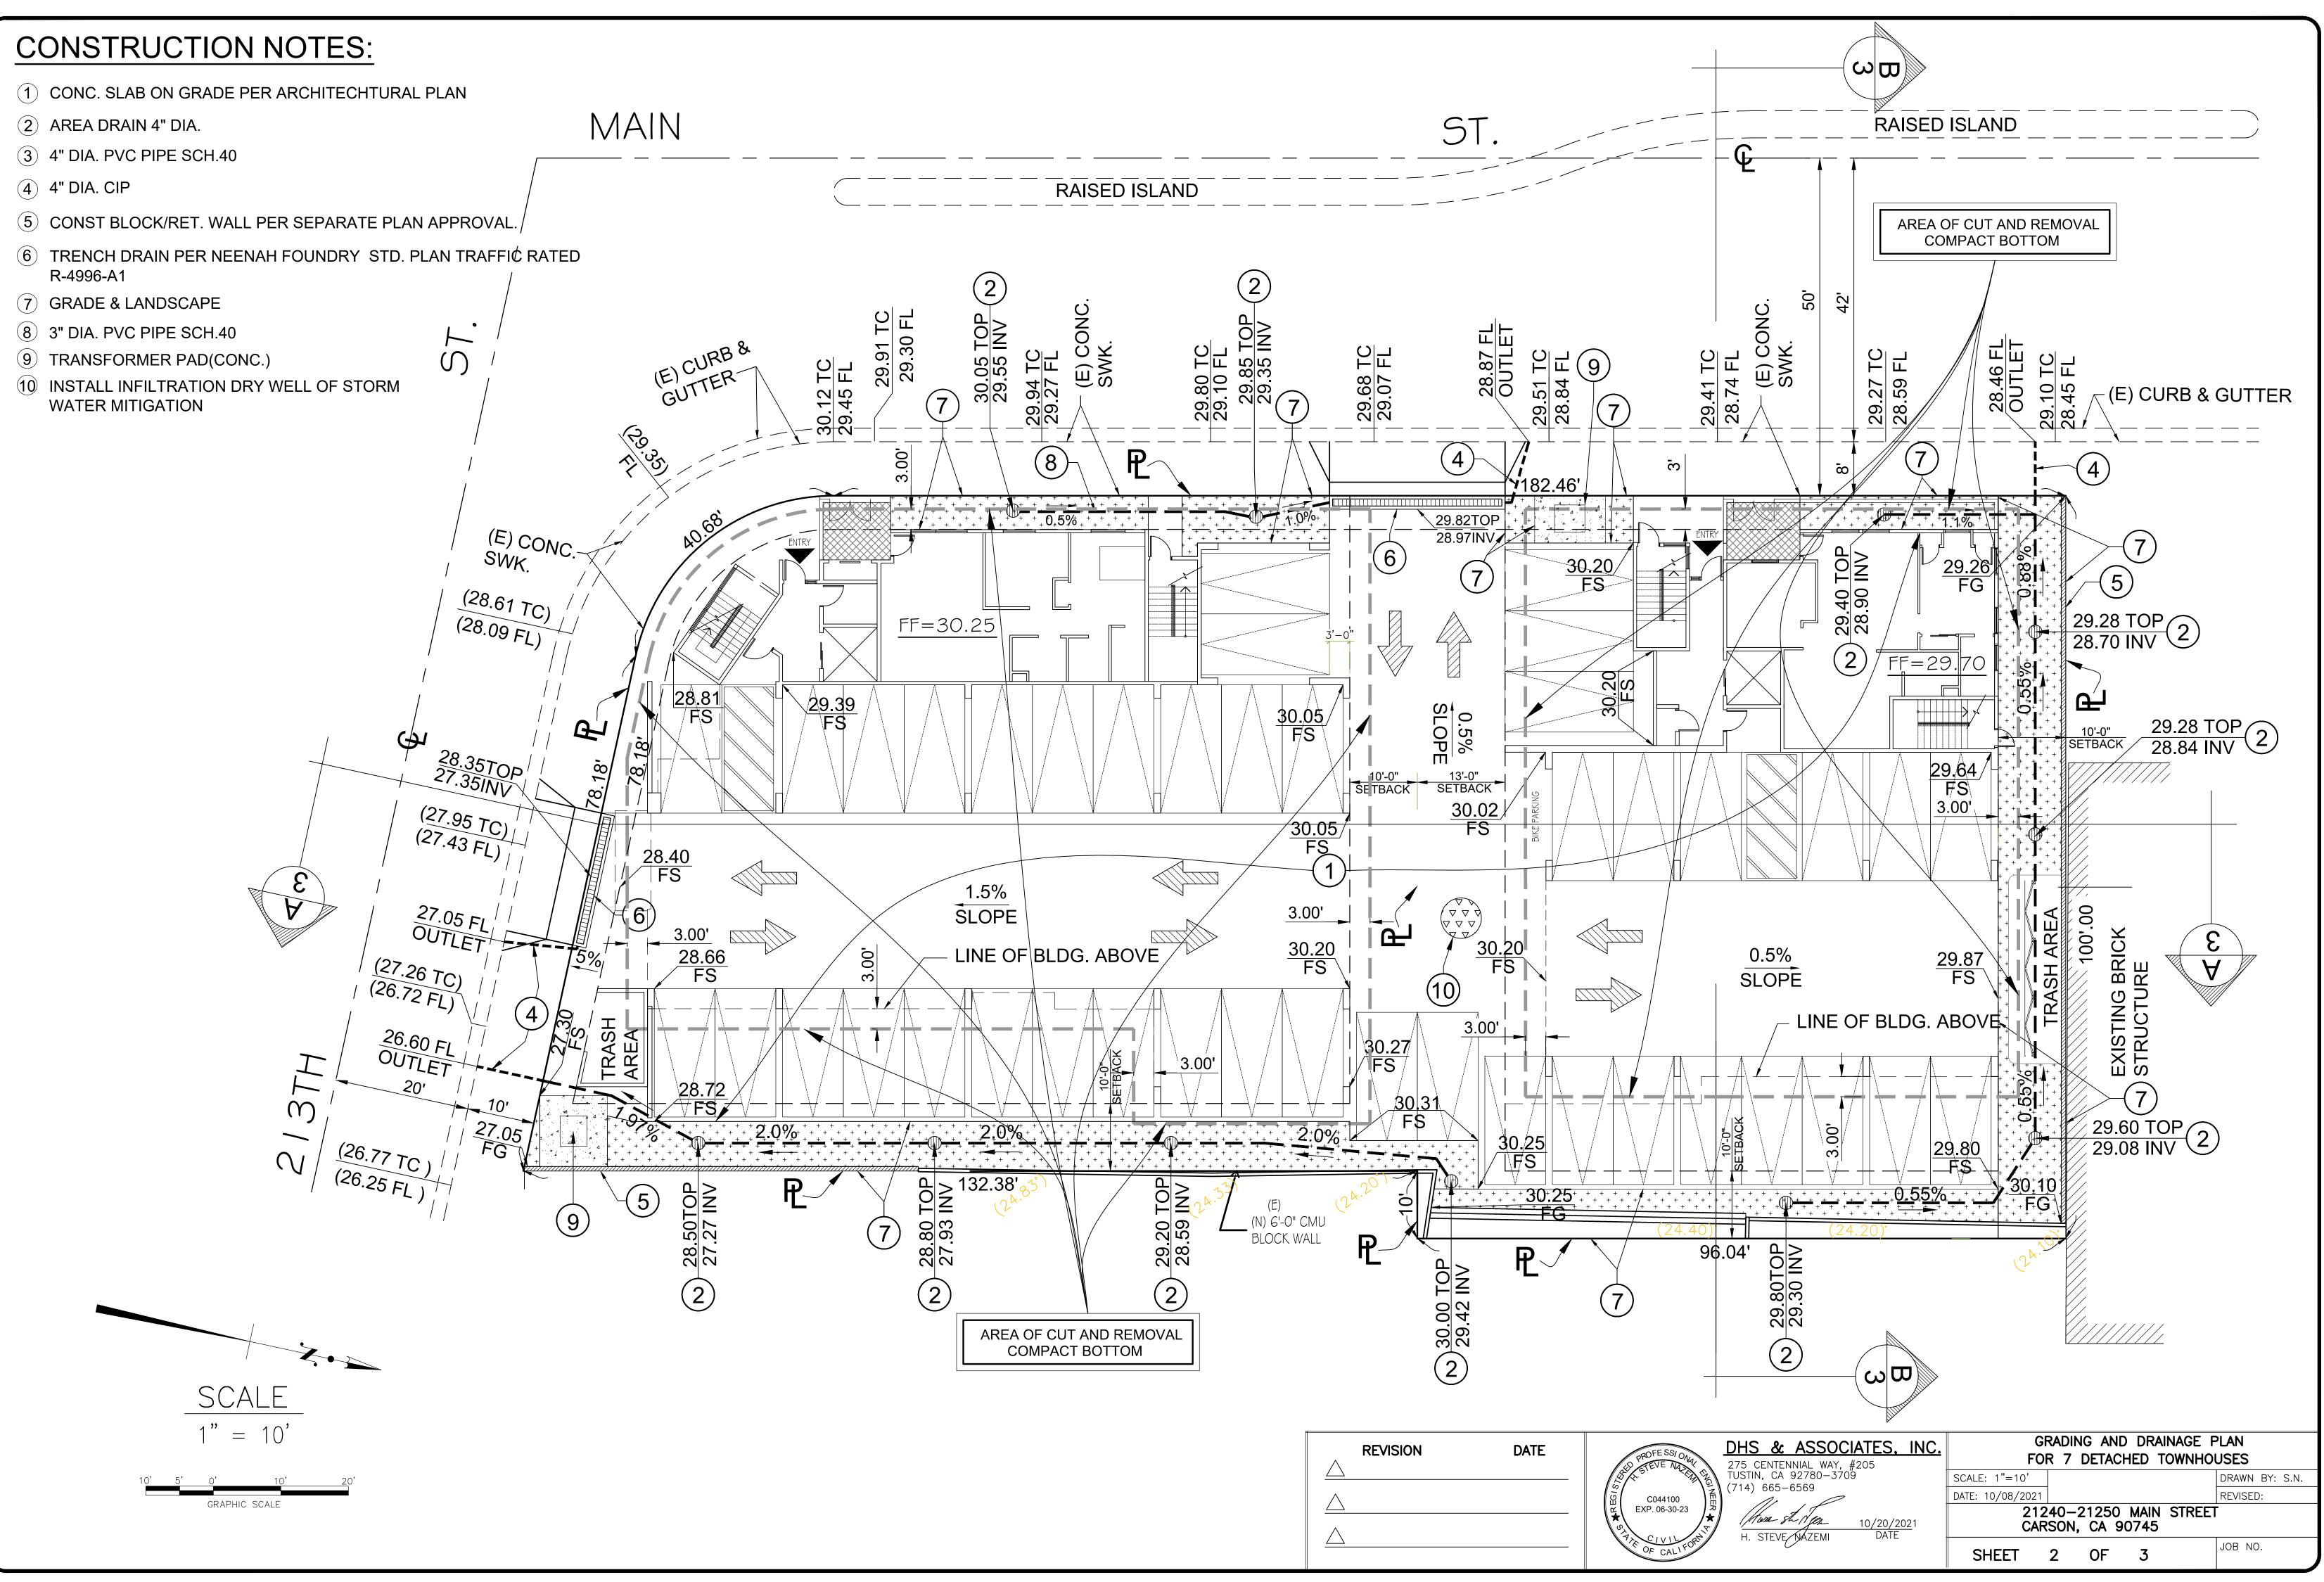

	REVISION	DATE
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CONSTRUCTION NOTES:

- 1 CONC. SLAB ON GRADE PER ARCHITECHTURAL PLAN
- 2 AREA DRAIN 4" DIA.
- 3 4" DIA. PVC PIPE SCH.40
- (4) 4" DIA. CIP
- 5 CONST BLOCK/RET. WALL PER SEPARATE PLAN APPROVAL.
- 6 TRENCH DRAIN PER NEENAH FOUNDRY STD. PLAN TRAFFIC RATED R-4996-A1
- 7 GRADE & LANDSCAPE
- 8 3" DIA. PVC PIPE SCH.40

